RIVER 504 ROWHOMES PRELIMINARY ENGINEERING PLANS

402-542 SOUTH 1ST STREET ST. CHARLES, KANE COUNTY, ILLINOIS

MASTER NOTES

- ALL ITEMS OF THIS PROJECT SHALL BE GOVERNED BY SPECIFICATIONS INCLUDED IN THE DOCUMENTS LISTED RELOW.
- A. "STANDARD SPECIFICATIONS FOR ROAD AND BRIDGE CONSTRUCTION PREPARED BY THE DUDWIENT IS USH to BELOW.

 TRANSPORTATION OF THE STATE OF ILLINOIS AND ADOPTED BY SAID DEPARTMENT

 (LINEST REVISION) AND HEREINATER REFERENCE TO A STATE STANDARD SPECIFICATIONS:

 B. "SUPPLEMENTAL SPECIFICATIONS AND RECURRING SPECIAL PROVISIONS" ADOPTED BY THE ILLINOIS DEPARTMENT OF TRANSPORTATION."
- PROVINGEN.
 ILLINOIS URBAN MANUAL (LATEST REVISION*) BY ASSOCIATION OF ILLINOIS SOIL & WATER CONSERVATION DISTRICTS.
 **STANDARD SPECIFICATIONS FOR WATER AND SEWER MAIN CONSTRUCTION IN ILLINOIS*, BY ILLINOIS ENVIRONMENTAL
- PROTECTION AGENCY.

 E. "LLINOS MANUAL ON UNIFORM TRAFFIC CONTROL DEVICES FOR STREETS & HIGHWAYS" BY ILLINOIS DEPARTMENT OF TRANSPORTATION.
 F. "ILLINOIS ACCESSIBILITY CODE", (LATEST EDITION").
- *LATEST REVISION IN EFFECT ON THE DATE OF THESE PLANS
- PRIOR TO BID, THE CONTRACTOR SHALL VERIFY CONFORMANCE BETWEEN PLANS AND THE ABOVE REFERENCED CODES. THE CONTRACTOR SHALL NOTIFY THE ENGINEER OF ANY DISCREPANCIES PRIOR TO BID.
- 3. IN THE EVENT OF A CONFLICT BETWEEN THESE VARIOUS STANDARDS, MUNICIPAL STANDARDS SHALL APPLY.
- 5. ALL WORK PERFORMED SHALL COMPLY WITH ALL APPLICABLE RULES AND REGULATIONS OF OSHA.
- THE CONTRACTOR IS RESPONSIBLE FOR NOTIFYING JULIE 1-800-892-0123 AT LEAST 48 HOURS IN ADVANCE OF CONSTRUCTION
 OPERATIONS, ALL UTILITIES MUST BE STAKEDLOCATED BY THE CONTRACTOR BEFORE CONSTRUCTION AND NOTIFY THE
 RONLINEER OF ANY DISCREPANCIES.
- 7. THE CONTRACTOR IS RESPONSIBLE FOR NOTIFYING THE MUNICIPALITY PUBLIC WORKS DEPARTMENT 639-377-4405 A MINIMUM OF 48 HOURS BEFORE CONSTRUCTION ACTIVITIES. A 48-HOUR NOTICE MUST BE PROVIDED FOR INSPECTIONS AND TESTS. MUNICIPAL STAFF MUST OPERATE ALL WATERMAN VALVES AND HYDRANTS ONLY.
- 8. THE CONTRACTOR SHALL PROTECT AND PRESERVE ALL SURVEYING MONUMENTS. UNTIL THE OWNER, THEIR AGENT OR A LICENSED SURVEYOR HAS WITNESSED OR OTHERWISE REFERENCED THEIR LOCATIONS.
- 9. THE CONTRACTOR SHALL BE AWARE OF POTENTIAL CONFLICTS WITH EXISTING UTILITIES AS MAY BE INDICATED ON THE PLANS. THESE AREAS SHALL BE EXCAVATED TO DETERMINE ELEVATIONS BEFORE BEGINNING CONSTRUCTION. CONTRACTOR SHALL NOT
- 11 ALL POAD SIGNS, STREET SIGNS AND TRAFFIC SIGNS WHICH NEED TO BE RELOCATED OR MOVED DUE TO CONSTRUCTION SMALL BE TAKEN DOWN AND STORED BY THE CONTRICTION AT HIS OWN EXPENSE EXCEPT THOSE WHICH THE PERMIT AGENCY SMALL REQUIRE TO DOB TEMPORARY PERSET UNTIL COMPLETION OF CONSTRUCTION OF THE PERMIT AGENCY WORK. THE CONTRACTOR SHALL AT HIS OWN EXPENSE, RESET ALL SAID SIGNS AT THE LOCATIONS DESIGNATED BY THE PURPIR THE CONTRACTOR SHALL AT HIS OWN EXPENSE, RESET ALL SAID SIGNS AT THE LOCATIONS DESIGNATED BY THE PERMIT AGENCY EXORER.
- 12. THE CONTRACTOR SHALL PRESERVE ALL CONSTRUCTION STAKES UNTIL THEY ARE NO LONGER NEEDED. ANY STAKES DESTROYED BY THE CONTRACTOR PRIOR TO THEIR USE SHALL BE RESET BY THE OWNER'S ENGINEER AT A COST TO BE BORNE BY THE CONTRACTOR THAT DESTROYED THE STAKES.
- 13. CONTRACTOR SHALL USE CARE NEAR ANY AND ALL EXISTING ITEMS WHICH ARE NOT INDICATED TO BE REMOVED OR MODIFIED. ANY DAMAGE DONE TO THESE ITEMS BY CONTRACTORS OPERATIONS SHALL BE REPAIRED AND/OR RESTORE! THE CONTRACTOR AT THE CONTRACTOR AT OWN EXPENSE.
- 14. THE CONTRACTOR SHALL NIBERHEY AND ANY ENABLESS THE OWNER, THE PERMIT AGENCY AND ITS OFFICIES, BHILD YERS AND ACRETS AND THE OWNERS BEGINNERS FOR MAIN AGAINST ALL LIGISSES CLAIMS, DEMANDE, PAYMENTS, SUITS ACTIONS, RECOVERIES AND JUDGMENT OF EVERY MATURE AND DESCRIPTION BROUGHT OR RECOVERED AGAINST THE BY REASON OF ANY ACT OR OMISSION OF SAID CONTRACTOR, HIS ACRETS OR REMOVERES, IN THE DECEMBING OF THE WORK.
- 16 ALL IMPROVEMENTS SHOWN ON THE PLANS ARE THE RESPONSIBILITY OF THE CONTRACTOR



VICINITY MAP

(NOT TO SCALE)

SITE AREA

OVERALL SUBDIVISION: 29 385 SE 0 675 AC

RIGHT-OF-WAY TO BE DEDICATED: 947 SF 0.022 AC

TOTAL LOTS: 28.438 SF 0.653 AC

SYMBOL LEGEND

TABLE OF CONTENTS

	PHOPERTY LINE		SHEET NO.	SHEET NAME
	BUILDING SETBACK LINE			TITLE OUEET
	EASEMENT LINE		C1	TITLE SHEET
	DEPRESSED CURB		C2	EXISTING CONDITIONS PLAN
<u> </u>	STORM SEWER		C3	DEMOLITION AND REMOVALS
<	SANITARY SEWER			
w	WATER MAIN	w	C4	PROPOSED GEOMETRY
— c ——	GAS LINE	G	C5	PROPOSED UTILITY PLAN
— Е ——	ELECTRIC LINE	— Е —		
— т —	TELEPHONE LINE	— т —	C6	PROPOSED GRADING PLAN
— го——	FIBER OPTIC	FO		
— CA ——	COMMUNICATION	CA		
— он ——	OVERHEAD WIRES	OH		

FENCE LINE SILT FENCE RADING CONTOUR VALVE VAULT BUFFALO BOX ELECTRIC STRUCTURE TRANSFORMER POWER POLE PEDESTAL DRAINAGE FLOW ARROW OVERFLOW ROUTE AID CONDITIONED SINGLE POLE SIGN DOLIBLE POLE SIGN STREET LIGHT BOLLARD CLEAN OUT TREE EROSION CONTROL BLANKET (SEE DETAIL SHEET) (SEE DETAIL SHEET)

DETECTABLE WARNINGS (SEE DETAIL SHEET)



PROJECT TEAM

OWNER

RIVER 504, LLC 525 S. TYLER RD, UNIT I ST. CHARLES, IL 60174

ARCHITECT

ALLEN+PEPPA 215 FULTON STREET GENEVA, IL 60134 PH.(630)578.1105

CIVIL ENGINEER

MeritCorp Group, LLC

NOTE

DETAILS AND NOTES WITHIN THESE PLANS, ALONG WITH NOTATIONS TO SUPPLEMENT SAME ARE CRUCIAL TO THE PROPER CONSTRUCTION OF THE DESIGN CONTAINED HEREIN.

2. CONTRACTOR SHALL VISIT THE SITE TO FAMILIARIZE HIMSELF WITH ALL CONDITIONS PRIOR TO ENGAGING IN A CONTRACT TO PERFORM WORK AS PROPOSED HEREIN.

3. PLANS ARE NOT VALID WITHOUT ORIGINAL SIGNATURE AND

BENCHMARKS

NAVD'88, AS ESTABLISHED BY TRIMBLE VRS NETWORK AT TIME OF TOPOGRAPHIC SURVEY. HORIZONTAL DATUM IS REFERENCING NAD' 83

SITE BENCHMARK #1: TAG BOLT ON FIRE HYDRANT LOCATED AT SOUTHWESTERLY CORNER OF SITE. N 1,909,513.9' E 989,773.6' EL 667.17'

SITE BENCHMARK #2: NW BOLT ON FIRE HYDRANT LOCATED APPROXIMATELY 635'± SE OF SITE E 990,090.4°

ABBREVIATIONS

3Q.	AGGREGATE GRAVEL	F-F	FACE TO FACE	R	RADIUS
T.	ALTERNATE	FES	FLARED END SECTION	RCP	REINFORCED CONCRETE
A.M.	BIT, AGG, MIXTURE	E/E	FINISHED FLOOR	ROW	RIGHT OF WAY
	BACK TO BACK	PL.	FLOW LINE	R.D.	ROOF DRAIN
	BUFFALO BOX	PQ.	FINISHED GRADE	SAN	SANITARY
T.	BACK OF CURB	HDWL	HEADWALL	STMH	STORM MANHOLE
	BITUMINOUS CONCRETE	HH	HAND HOLE	STM	STORM
a.	BENCHMARK	HWL	HIGH WATER LEVEL	STA.	STATION
ο.	BY OTHERS	HYD	HYDRANT	SE	SQUARE FEET
Р	BOTTOM OF PIPE	INL	NLET	SY	SQUARE YARD
w	BOTTOM OF WALL	INV	INVERT	TER	TO BE REMOVED
2	CATCH BASIN	LP.	IRON PIPE	TIC	TOP OF CURB
VTA	CABLE TELEVISION	MAX	MAXIMUM	TIF	TOP OF FOUNDATION
	COMM. ED.	M.E.	MATCH EXISTING	TIP	TOP OF PIPE
	CENTERLINE	MH	MANHOLE	T/W	TOP OF WALL
MP.	CORRUGATED METAL PIPE	MIN	MINIMUM MODINAL WATER LEVEL	TRANS.	TRANSFORMER
	CENTER OF STRIPE	N.W.L.	NORMAL WATER LEVEL	W	VALVE VALILT
ο.	CLEAN OUT	PED	PEDESTAL POINT OF CURVE	W.M.	WATER MAIN
ONC.	CONCRETE		POINT OF CURVE POINT OF COMPOUND CURVE		
Α.	DIAMETER DISCTILE IDON WATER MAIN	POC			
	DOUBLE IRON WATER MAIN	PI	POINT OF INTERSECTION		
2.	EDGE OF DAVEMENT	PRC	POINT OF REVERSE CURVE POINT OF TANGENCY		
Р	EDGE OF PAVEMENT				
		PVC	POINT OF VERTICAL CURVE		
EV.	ELEVATION EDGE OF STRIPE	PVI	POINT OF VERTICAL INTERSECTI		
			POINT OF VERTICAL TANGENCY		
w.	EDGE OF WALK	PL DD	PROPERTY LINE		
	EXISTING	PP	POWER POLE		

RIVER 504 ROWHOMES 402 - 542 SOUTH 1ST STREET ST. CHARLES, ILLINOIS

	RIGHT OF WAY
	ROOF DRAIN
	STORM MANHOLE
	TOP OF FOUNDATION
ON	
	R.D. SAN STMH STM STA SF SY TER TIC TIF TIP TIW TRANS

PROJECT NO. M24183

PLANS

ENGINEERING

MeritCorp

orp

CHECKED BY: SHEET NO. C1 /6

PRELIMINARY TDR

LEGEND EXETING HANDHOLE EXETING LIGHT POLE EXETING MALBOX EXETING MANHOLE EASEMENT CENTER LINE OF RIGHT OF WAY EDISTING SANITARY LINE DISTING SOMEWHELD DISTING STORM LIVE BUSTING BLECTRIC LIVE G BUSTING GAS LINE OH BUSTING FEBR OPTICS LINE FO BUSTING FEBR OPTICS LINE EXETING CABLE TV PEDESTA EXISTING CARLE TV PEDESTAL EXISTING ELECTRIC PEDESTAL EXISTING TELEPHONE PEDESTAL EXISTING SIZN EXISTING SANTARY MANHOLE EXISTING STORM CATCH BASIN EXISTING STORM INLET DISTING COMMUNICATION LINE DISTING CONTOUR MAJOR 5 FOO EXISTING STORM MANHOLE EXISTING HIRE HYDRANT EXISTING WATER BUFFALO BOX EXISTING WATER VALVE EXISTING WATER VALVE EXISTING WATER VALVE EDITING CONTOUR MINOR 1 FOOT EDITING BULDING EDITING CONCRETE PAVEMENT EDITING ASPHALT PAVEMENT EXISTING DECIDIOUS TREE (LEAF TREE) EXISTING CONFEROUS TREE INON LEAF TREE EXISTING CONFERENCE THE PINON EXISTING ELECTRIC MANHOLE EXISTING ELECTRIC TRANSFORMER EXISTING ELECTRIC TRANSFORMER EXISTING REER OPTICS HANDHOLE EXISTING TELEPHONE MANHOLE EXISTING POWER POLE EXISTING GUY WIRE CONTROL POINT - CROSS CI. EX EDGE OF WATER 0

BENCHMARKS

SOURCE: NAVD'88, AS ESTABLISHED BY TRIMBLE VRS NETWORK AT TIME OF TOPOGRAPHIC SURVEY HORIZONTAL DATUM IS REFERENCING NAD'83

SITE BENCHMARK #2: (SEE SITE KEY FOR LOCATION OF OFF-SITE BM#2)

NW BOLT ON FIRE HYDRANT LOCATED APPROXIMATELY 635's SE OF SITE.

1.508,946.5'

E. 990,090.4'

EL 701.40'

TOPOGRAPHIC SURVEY INFORMATION SHOWN FOR ON-SITE IMPROVEMENTS WAS COMPLETED BY REGIONAL LAND SERVICES. BENCHMARK INFORMATION IS SHOWN PER SAID SURVEY, AND WAS NOT COMPLETED BY MERITCORP GROUP, LLC.

UTILITY LOCATE INFO

CONTICTS

ATTERATIOSTISSUITON 0000000000 01160000ATTCOM


COMOGO.COMICATO (FORITY), MANTHA (SERIAS 2022-04000 MARTHA (JERASSICAR)E COMCAST.COM

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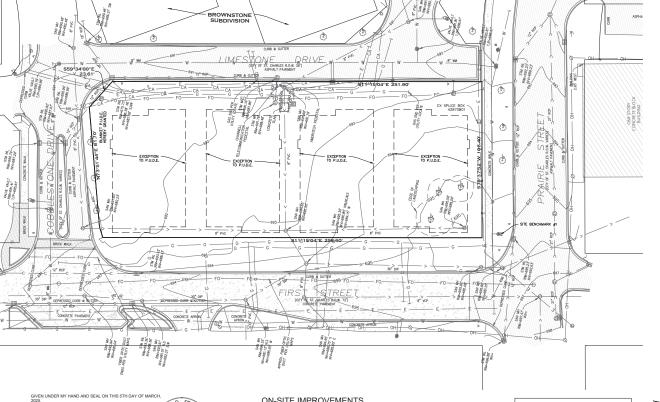
NORGA NORG GAS, UTLITY COMBULTANT COSW, 603-93-2302

SCHIGAST.CHARGE, CITY OF, ETRIC CEREBROTH, 603-972-2793, MAPPIGETCHARLESS, COV



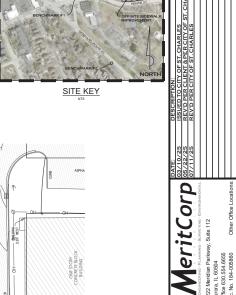

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L LAND SURVEYOR No. 3868

ON-SITE IMPROVEMENTS

NOTE MERITCORP GROUP, LLC ON 02/08/2 NORTH

EXISTING CONDITIONS PLAN PROJECT NO. M24183

RIVER 504 ROWHOMES 402 - 542 SOUTH 1ST STREET ST. CHARLES, ILLINOIS

CHECKED BY: TDR SHEET NO. C2 /6

ENGINEERING PLANS


PRELIMINARY


20 10 1" = 20' GRAPHIC SCALE


OFF-SITE SIDEWALK IMPROVEMENT


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NORTH




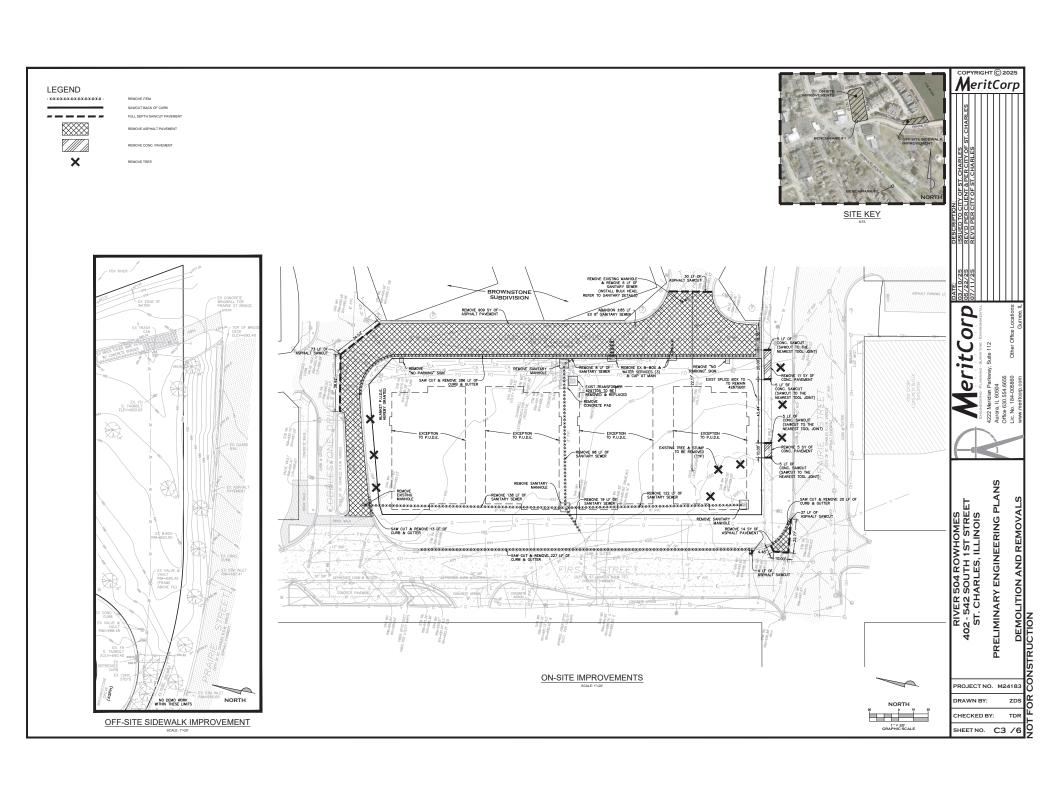

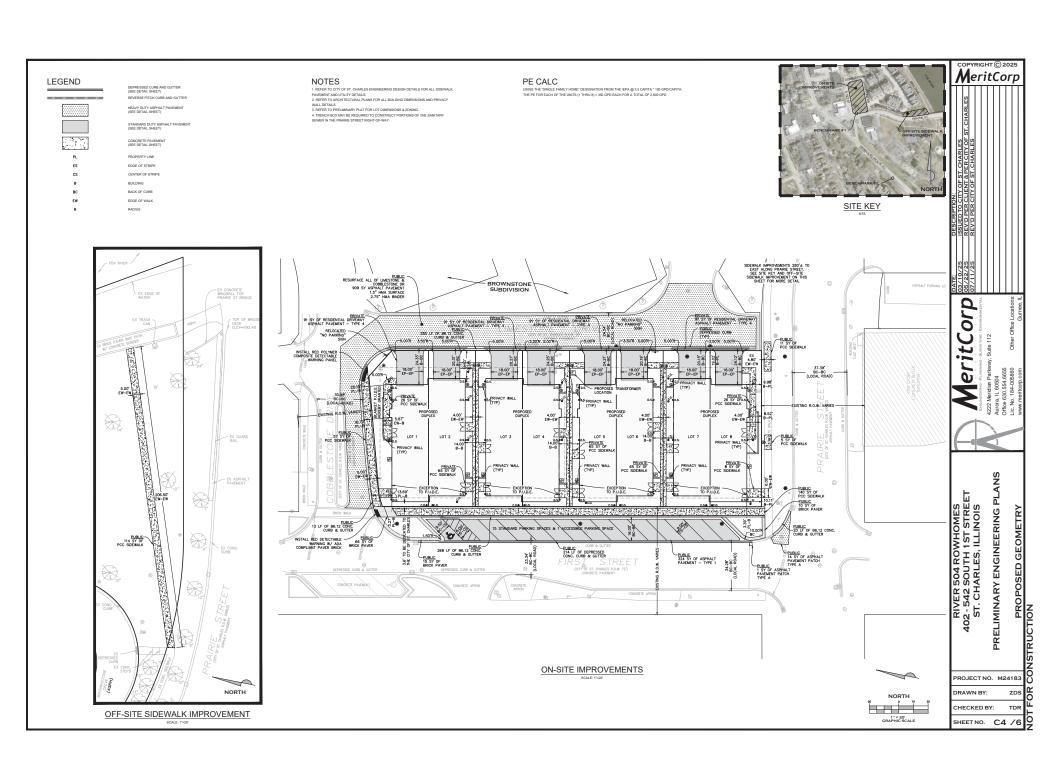

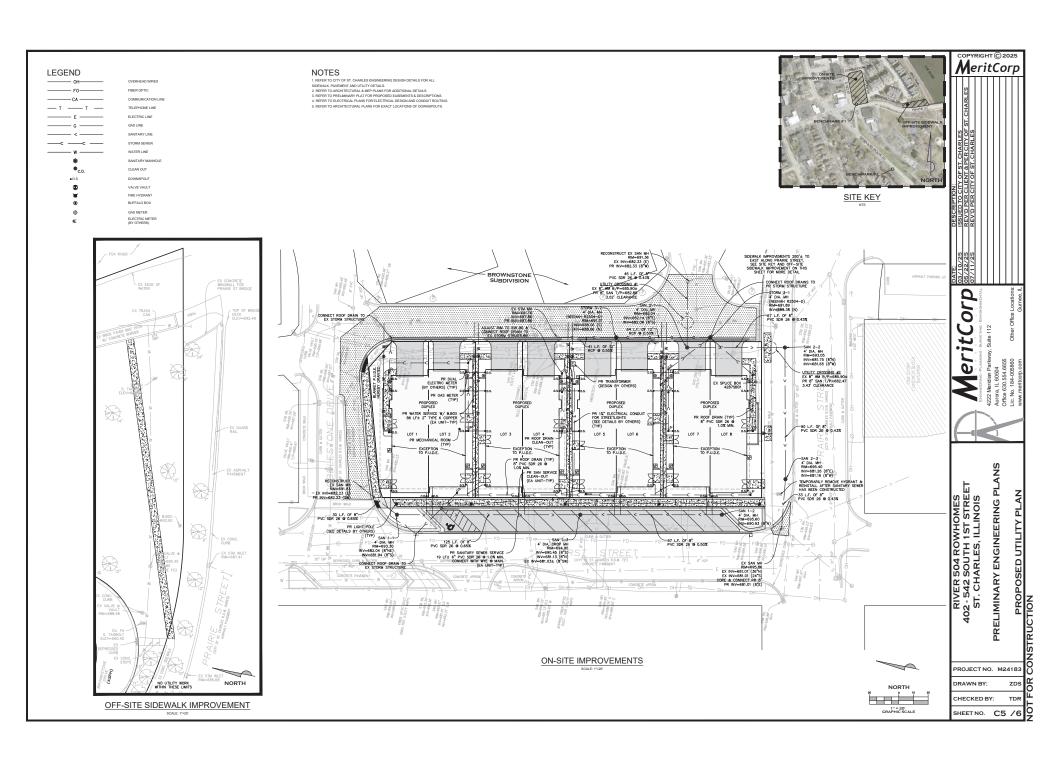

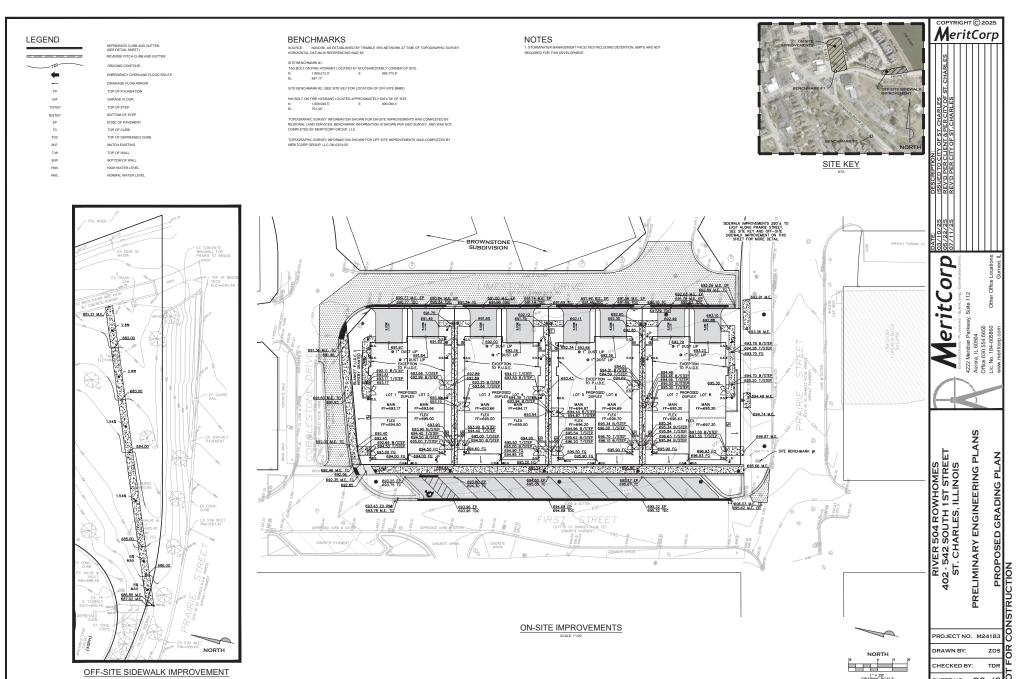SHEET NO. C6 /6

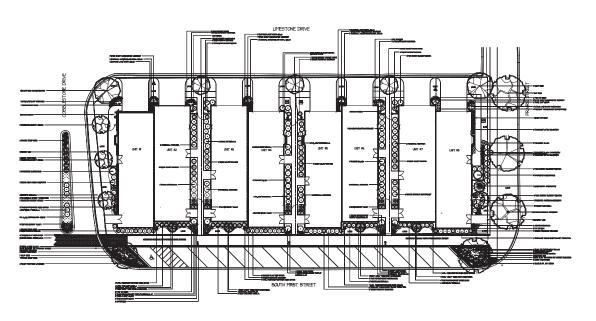

U LANDSCAPE PLAN

SOLE-7-197

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-	Balvas Jaserka Dabis Play Red	TYPE F IS AV BUT SUBSEA	3 CM /M
	Surface y Windowskin Doorf Purels'	TRACEPURATE DAME PROPER MOREAN LAAC.	164/1
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-	Series attends	AUTURN MOOR GRAND	i GAL
-	Sesioria externata Secretado hateratesto	PRAME DROP SHID	164
_	Allen Summer Backundhad	TREE-A-BOO ALLEM	I GAL
-	Allen Sammer Park-o-Sted Allen Samelorn		
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-	Heater Carried Hatermater Heate Vehicle Frost Heate Clarged Later	I SUTUPN PROBT HOBTA	I GAL
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	Sestim Phrecrecker*		I CAL
	Sealor Pere Jo! Sealor hard Servic of Jo!	TURE JOY SECUR	I GAL











NOTES

ALL LANDSCAPE BEDS TO BE MILCHED WITH PREMIUM HARDWOOD SHREDDED MILCH

ALL EVERGREENS AND CRIMPIBITAL TREES TO HAVE A MINIMAL HEIGHT OF 6 FEET AT PLANTING

ALL SHRUBS TO HAVE A MINMUM HEIGHT OF 24 Inches at Planting

SEE CIVIL DRAWNES FOR SIDEMALK AND PAVER LAYOUT

CAIL DRAWNES TO BE FOLLOWED SHOULD THERE BE MY DECREPANCES RELATED TO SOBWILK, PAYER, OR UTILITY LOCATIONS

ALL UTILITIES TO BE MARKED BY JULIE, BEFORE ANY PLANTING TAKES PLACE. PLANTS NALL BE ADJUSTED FOR UTILITIES AS NEEDED.



1 1000	195		
In	Cade	Description	
1	08/1/25	CHANGE DOOR & HALK LAYOUPS	
2	65/25	REMEE HALAS, ACO LITURES	
_			

DESIGNED BYN
MEAGAN PROVENCHIIR
SENOR LANDSCAPE DESIGNER
LLINOS CERTIFED NURSERY PROFESSIONAL

WASCO NURSHRY & GARDHN CHNYTHR 44-774 ROUTE 64 SANT CHARLES, IL 6075 630-584-4424

DESIGNANASCONURSERY.COM WASCONURSERY.COM

THE DRAWING IS THE PROPERTY OF IMPSOON MIRSERY METHER THE HORK IS TO BE MOT, INFOME THE HORK IS TO BE AND INFOME THE METHER OF ME

RIVER 504 ROW HOMES


504 LIMESTONE DRIVE ST. CHARLES, IL 60174

J & B BULDERS





nted by Symmeter"

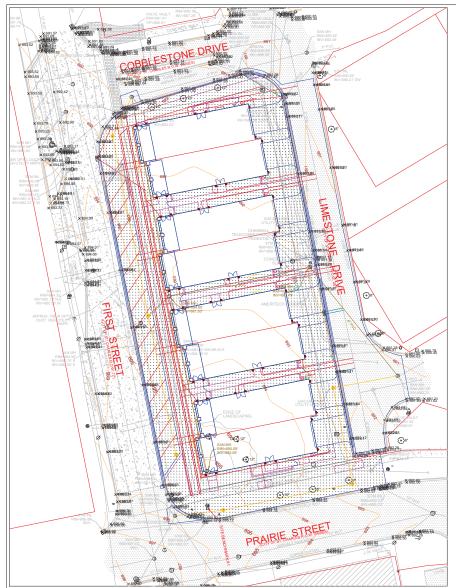

Luminaire	Schedule	1					
Symbol	Qty	Label	Description	LLF	Luminaire	Luminaire	Total
					Lumens	Watts	Watts
+0	48	WAC LIGHTING WS- W230411	WS-W230411-CS(3000K)	0.850	476	16.4157	787.954
->□	24	WAC LIGHTING WS30405	WS-W230405-CS(3000K)	0.850	444	16.3008	391.219

Calculation Summary							
Label	CalcType	Units	Avg	Max	Min	Avg/Min	Max/Min
Ground Planar	Illuminance	Fc	0.16	0.5	0.0	N.A.	N.A.

Notes:
- Mount Heights = MH as shown


- No minor obstructions included in calculations Obstructions will affect footcandle levels



Rowhome Development

250275 7/17/2025 1" = 20ft

Jeff Cascarelli

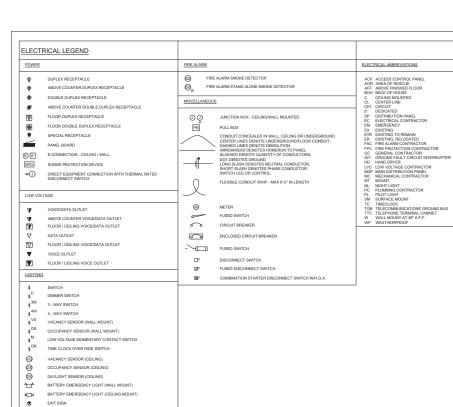

LOWERCASE LETTER DENOTES SWITCH DESIGNATION

ANNOTATION

LINE WEIGHT LEGEND

NEW

EXISTING

DEMO

KEYED NOTE TAG

KEYED NOTE TAG


REVISION NOTE TAG

(X)

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	ELECTRICAL SHEET INDEX	
SHEET NO.	SHEET NAME	SCALE
E0.0	ELECTRICAL COVER SHEET	N.T.S.
E1.0	ELECTRICAL SITE PLAN	1/16" = 1'-0"
E2.0	ELECTRICAL SCHEDULES	N.T.S.



ELECTRICAL ONE-LINE DIAGRAM (TYP. FOR 4) SCALE: N.T.S.

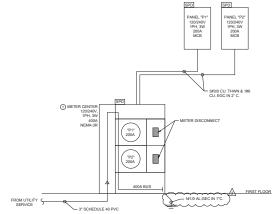
ELECTRICAL ONE - LINE DIAGRAM GENERAL NOTES:

- PROVIDE NECESSARY METERING FACILITIES INCLUDING METER SOCKET, CURRENT-TRANSFORMER (CT) CABINET.
 COORDINATE WITH LOCAL UTILITY: CONDUIT, AND OTHER WORK FOR METERING REQUIRED BY THE LOCAL UTILITY.
- UPON SUBSTANTIAL COMPLETION, THE ELECTRICAL CONTRACTOR SHALL NOTIFY THE ENGINEER AND SHALL ALLOW, AT
 THE ENGINEERS DISCRETION, FOR THE INSPECTION OF NEW WORK BEFORE ENERGIZING.
- THE ELECTRICAL CONTRACTOR SHALL PROVIDE MAXIMUM AVAILABLE FAULT CURRENT FIELD LABELING TO SERVICE EQUIPMENT IN ACCORDANCE WITH NEC 110.24. REFER TO PANEL SCHEDULE ON SHEET ES.0 FOR THE MAIC RATING OF THE PANEL.
- 4. THE ELECTRICAL CONTRACTOR IS RESPONSIBLE FOR INSTALLING ALL INDICATED EQUIPMENT TO CODE-COMPLIANT CLEARANCES. PROVIDE SUBMITTALS AS INDICATED ON SPECIFICATIONS TO PROPERLY COORDINATE PHYSICAL LOCATIONS OF NEW ANDIOR EXISTING EQUIPMENT.
- THE ELECTRICAL CONTRACTOR SHALL PROVIDE CIRCUIT DIRECTORY OR CIRCUIT IDENTIFICATION FOR PANELBOARDS AND SOURCE OF SUPPLY FOR SWITCHBOARDS AND PANELBOARDS SUPPLIED BY A FEEDER.
- ELECTRICAL EQUIPMENT SUCH AS SWITCHBOARDS, PANELBOARDS, INDUSTRIAL CONTROL PANELS, METER SOCKET ENCLOSURES AND MOTOR CONTROL CENTERS SHALL BE FILED/AMARKED WARNING QUALIFIED PERSONNEL OF THE POTENTIAL ARC PLASH HAZARD AND APPROPRIATE PPE IS REQUIRED PER NEC ART. 110 AND NPPA-070E-2000.
- 7. PANELBOARD MOUNTING HEIGHT SHALL NOT EXCEED 6'-6' FROM FINISHED FLOOR TO CENTER OF TOP BREAKER.
- ALL FLOOR MOUNTED EQUIPMENT INCLUDING SWITCHBOARDS, DISTRIBUTION PANELS, TRANSFORMERS, AND TRANSFER SWITCHES SHALL BE MOUNTED ON 4" CONCRETE PADS.
- VOLTAGE DROP FOR BRANCH CIRCUITS AND FEEDERS SHALL NOT EXCEED 3% FROM SOURCE OF ORIGIN TO FURTHEST TERMINATION POINT.
- 10. ALL NEW ELECTRICAL EQUIPMENT SHALL BE ULLISTED OR APPROVED BY CITY RECOGNIZED ELECTRICAL TESTING COMPANY
- 11. FEEDER LENGTHS ARE SHOWN FOR VOLTAGE DROP AND FAULT CURRENT CALCULATIONS PURPOSES ONLY. DO NOT USE FOR BIDDING PURPOSES. CONTRACTOR SHALL FIELD VERIFY ACTUAL PATH OF ANY AND ALL FEEDER LENGTHS PRIOR TO BID.
- 12. TERMINATION PROVISIONS FOR ELECTRICAL EQUIPMENT SHALL COMPLY WITH NEC 110.14(C)(1)

- 15. COORDINATE CIRCUIT BREAKER AND BRANCH CIRCUIT SIZES WITH SPD MANUFACTURER REQUIREMENTS BASED ON NEC

(X) ELECTRICAL ONE - LINE DIAGRAM KEY NOTES:

MC (METER CENTER) SHALL BE APPROVED BY ST. CHARLES MUNICIPAL ELECTRIC UTILITY COMPANY. COORDINATE EXACT LOCATION & MOUNTING HEIGHT ON FIELD WITH ST. CHARLES MUNICIPAL ELECTRIC UTILITY COMPANY.

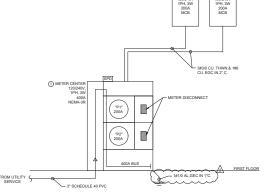



PEP/

ALLEN

ENGINEERS

YOUR TRUSTED DESIGN PARTNER

SUSHIL KUMAR DEZ.DESBOS

EXP:11.30.2025

402-542 SOUTH 1ST STREET ST CHARLES,ILLINOIS Design Developn Bidding:

PROJECT NO. 24-013

D.P. CHECKED BY S.B. 3 OF 3

ELECTRICAL COVERSHEET




SERVICE GROUNDING SYSTEM DIAGRAM 2

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1#2 AL,GEC IN 3/4°C.

SERVICE EEEDED

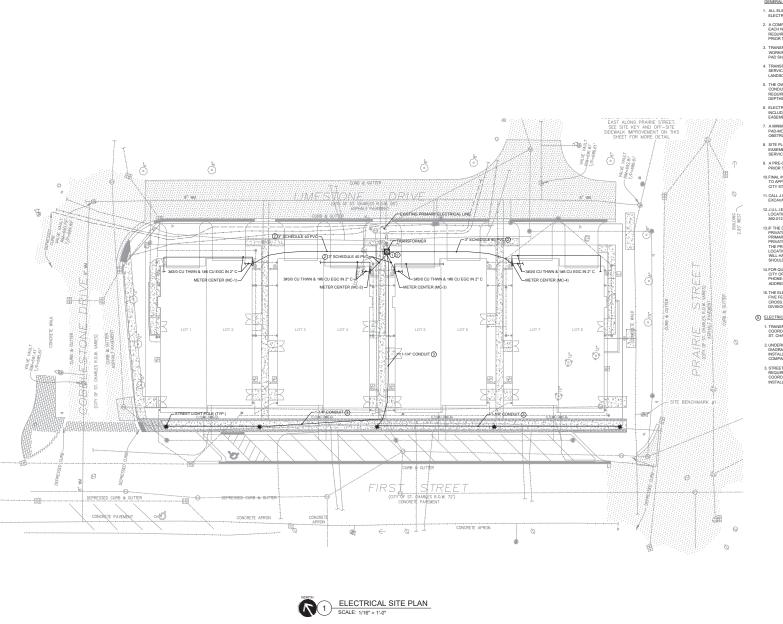

- 7. A MINIMUM 10' UTILITY EASEMENT SHALL BE PROVIDED AROUND ALL
- 8. SITE PLAN SHALL INCLUDE PROPERTY LINES, STRUCTURES, SETBACKS.
- A PRE-CONSTRUCTION MEETING WITH THE ELECTRIC UTILITY IS REQUIRED PRIOR TO BEGINNING INSTALLATION.
- 11. CALL J.U.L.I.E. AT 811 TO LOCATE ALL UNDERGROUND UTILITIES PRIOR TO EXCAVATION.
- IS THE DEVELOPEN WHISE TO PROVIDE PRIVATE STREET LIGHTING, ANY PRIVATE LIGHTING COMDUIT AND CABLE ARE NOT ALLOWED WITHIN THE PRIMARY OR SCHOOLINEY RECEIVED CONDUIT TRISCAT FURTHERMORE, TO THE PRIMARY MAINLINE OR SECONDARY SERVICE MAINS TO AVOID PTURE LOCATING CONTRISON. IF THERE IS COME TO BE PRIVATE LIGHTING, SUP-VILLAY TO BE ON A METER SEPARATE FROM THE TRANSPORDER.
- ADDRESS: 2 EAST MAIN STREET, ST. CHARLES, IL 60174

- TRANSFORMER LOCATION SHOWN IS APPROXIMATE. CONTRACTOR SHALL COORDINATE AND VERIEY FINAL TRANSFORMER LOCATION WITH THE CITY OF ST. CHARLES ELECTRIC UTILITY DIVISION PRIOR TO INSTALLATION.
- STREETLIGHTS SHALL BE CONNECTED IN "DAISY CHAIN" CONFIGURATION AS REQUIRED BY THE CITY OF ST. CHARLES ELECTRIC UTILITY DIVISION. COORDINATE AND GET APPROVAL FROM CITY INSPECTOR BEFORE INSTALLATION.

- ALL ELECTRIC SERVICE WORK SHALL CONFORM TO CITY OF ST. CHARLES ELECTRIC UTILITY STANDARDS.
- A COMPLETED ELECTRIC SERVICE APPLICATION SHALL BE SUBMITTED FOR EACH NEW OR MODIFIED SERVICE. COORDINATE SERVICE VOLTAGE, LOAD REQUIREMENTS, AND METER LOCATION WITH THE ELECTRIC UTILITY DIVISION PRIOR TO INSTALLATION.
- TRANSFORMERS SHALL BE PAD-MOUNTED WITH A MINIMUM 10' CLEAR
 WORKING SPACE AT THE FRONT AND 3' ON ALL OTHER SIDES. TRANSFORMER
 PAD SHALL BE INSTALLED LEVEL AND PER CITY STANDARDS.
- TRANSFORMERS MUST BE FULLY ACCESSIBLE TO UTILITY PERSONNEL AND SERVICE VEHICLES AT ALL TIMES. NO FENCES, STRUCTURES, OR LANDSCAPING SHALL OBSTRUCT ACCESS OR REQUIRED CLEARANCES.
- 5. THE OWNER/DEVELOPER SHALL PROVIDE AND INSTALL ALL REQUIRED CONDUITS, TRANSFORMER PAD, PULL BOXES, AND RACEWAYS PER CITY REQUIREMENTS. CONDUIT SYSTEM SHALL BE INSTALLED TO CITY-SPECIFIED DEPTHS AND CONSTRUCTION METHODS.
- ELECTRICAL SERVICE CONDUITS SHALL BE SHOWN ON THE SITE PLAN INCLUDING PRIMARY AND SECONDARY ROUTING, WITH ALL REQUIRED EASEMENTS.
- PAD-MOUNTED EQUIPMENT. NO PERMANENT STRUCTURES OR OBSTRUCTIONS ARE PERMITTED IN EASEMENTS.
- EASEMENTS, TRANSFORMER LOCATIONS, METER LOCATIONS, AND ELECTRIC SERVICE ENTRANCES AT A MINIMUM SCALE OF 1" = 20".
- 10. FINAL INSPECTION AND ELECTRIC SERVICE ENERGIZATION WILL BE SUBJECT TO APPROVAL OF ALL ELECTRICAL INSTALLATIONS, CONFORMANCE WITH CITY STANDARDS, AND SUBMISSION OF AN APPROVED AS BUILT SURVEY.
- 12.J.U.L.I.E. NOTIFICATION: PRIOR TO ANY DIGGING, CONTACT THE JOINT UTILITY LOCATING INFORMATION FOR EXCAVATORS (J.U.L.I.E.) AT 811 OR (800) 892-0123 TO LOCATE UNDERGROUND UTILITIES.
- 14.FOR QUESTIONS OR COORDINATION, CONTACT: STEVE SHROBA CITY OF ST. CHARLES ELECTRIC UTILITY DIVISION PHONE: (630) 377-4407
- 15. THE ELECTRIC MAINLINE CABLE ROUTE SHOULD BE SEPARATE OF AT LEAST FIVE FEET FROM SEWER, WATER & GAS, EXCEPT AT LOCATION WHERE THEY CROSS. COORDINATE WITH THE CITY OF ST. CHARLES ELECTRIC UTILITY DIVISION PRIOR TO INSTALLATION.

- 2 UNDERGROUND CONDUIT ROUTING SHOWN ON THE DRAWINGS IS DIAGRAMMATIC ONLY CONTRACTOR SHALL VERIET FINAL ROUTING AND INSTALLATION DETAILS IN FIELD BASED ON EXISTING CONDITIONS, UTILITY COMPANY REQUIREMENTS, AND LOCAL CODES.



INFO@ALLENPEPA.COM TEL: (630) 578-1105 215 FULTON ST., GENEVA, IL 60134 ALLEN CALLER

ENGINEERS

YOUR TRUSTED DESIGN PARTNER



ES HOM RIVER 504 ROW

402-542 SOUTH 1ST STREET ST CHARLES,ILLINOIS

PROJECT NO. 24-013 D.P.

CHECKED BY S.B. 2 OF 3

ELECTRICAL SITE PLAN



	LOAD CALCULATION (1	20/240 V, 1 Phase	e)
	BUILDING TYPE A (UNIT-1)- L	DAD CALCULATIO	N
oruro.	L LOADS:		
SENERA	Square Foot Area Per Unit		4986 Square Feet
	Watts per Square Foot		3 VA/SF
	Total General Lighting VA		14958 VA
2	Appliance Circuits @ 1500VA Each		3000 VA
1	Laundry appliance @ 1500VA Each		1500 VA
1	Range		1800 VA
1	Garbage Disposal		500 VA
1	Dishwasher		1440 VA
1	Refrigerator		1800 VA
1	Gas Dryer		1800 VA
1	Flevator		11500 VA
1	FVC		9600 VA
1	Microwave		1800 VA
	Total	General Load:	49698 VA
DEMAN		delierai Load.	43036 VA
DEITH !	FIRST 10KVA @ 100%		10000 VA
	REMAINDER @ 40%		15879 VA
	Sub-1	otal	25879 VA
MECHA	NICAL LOAD		
1	CU		4896 VA
2	FU		2189 VA
1	GWH		500 VA
1	Hood		444 VA
	Total Connected VA:		57727 VA
	Total Demand VA:		33908 VA
	Total AMPS: Total Connected	/A / 240	240.53 AMPS
	Total AMPS: Total Demand		141.28 AMPS
	Total AMPS *1.25	,	176.60 AMPS


	BUILDING TYPE A (UNIT-2)- LOAD CAL	
	BUILDING TIPE A (UNIT-2)- LOAD CAL	COUNTON
GENERA	ALLOADS:	
	Square Foot Area Per Unit	4958 Square Fee
	Watts per Square Foot	3 VA/SF
	Total General Lighting VA	14874 VA
2	Appliance Circuits @ 1500VA Each	3000 VA
1	Laundry appliance @ 1500VA Each	1500 VA
1	Range	1800 VA
1	Garbage Disposal	500 VA
1	Dishwasher	1440 VA
1	Refrigerator	1800 VA
1	Gas Dryer	1800 VA
1	Elevator	11500 VA
1	EVC	9600 VA
1	Microwave	1800 VA
	Total Genera	l Load: 49614 VA
DEMAN		
	FIRST 10KVA @ 100%	10000 VA
	REMAINDER @ 40%	15846 VA
	Sub-Total	25846 VA
	NICAL LOAD	
1	CU	4896 VA
2	FU	2189 VA
1	GWH Hood	500 VA 444 VA
	Total Connected VA:	57643 VA
	Total Demand VA:	33874 VA
	Total AMPS: Total Connected VA / 240	240.18 AMPS
	Total AMPS: Total Demand VA / 240	
	Total AMPS *1.25	176.43 AMPS

	BUILDING TYPE B (UNIT-1)	- LOAD CALCULATION
ER/	AL LOADS:	
	Square Foot Area Per Unit	4911 Square Feet
	Watts per Square Foot	3 VA/SF
	Total General Lighting VA	14733 VA
2	Appliance Circuits @ 1500VA Each	3000 VA
	Laundry appliance @ 1500VA Each	1500 VA
	Range	1800 VA
l	Garbage Disposal	500 VA
l	Dishwasher	1440 VA
	Refrigerator	1800 VA
	Gas Dryer	1800 VA
ı	Elevator	11500 VA
l	EVC	9600 VA
L	Microwave	1800 VA
	To	otal General Load: 49473 VA
AN	D:	
	FIRST 10KVA @ 100%	10000 VA
	REMAINDER @ 40%	15789 VA
	Su	b-Total 25789 VA
HA	NICALLOAD	
	CU	4896 VA
2	FU	2189 VA
L	GWH	500 VA
L	Hood	444 VA
	Total Connected VA:	57502 VA
	Total Demand VA:	33818 VA
	Total AMPS: Total Connect	ed VA / 240 239.59 AMPS
	Total AMPS: Total Dema	
	Total AMPS *1.25	176.14 AMPS
	IOUII AIVIPS 1.25	176.14 AMP3

	BUILDING TYPE B (UNIT-2)- LOAD CALCU	JLATION
GENERA	ILLOADS:	
	Square Foot Area Per Unit	4898 Square Feet
	Watts per Square Foot	3 VA/SF
	Total General Lighting VA	14694 VA
2	Appliance Circuits @ 1500VA Each	3000 VA
1	Laundry appliance @ 1500VA Each	1500 VA
1	Range	1800 VA
1	Garbage Disposal	500 VA
1	Dishwasher	1440 VA
1	Refrigerator	1800 VA
1	Gas Dryer	1800 VA
1	Elevator	11500 VA
1	EVC	9600 VA
1	Microwave	1800 VA
	Total General L	oad: 49434 VA
DEMAN	D:	
	FIRST 10KVA @ 100%	10000 VA
	REMAINDER @ 40%	15774 VA
	Sub-Total	25774 VA
MECHA	NICALLOAD	
1	CU	4896 VA
2	FU	2189 VA
1	GWH	500 VA
1	Hood	444 VA
	Total Connected VA:	57463 VA
	Total Demand VA:	33802 VA
	Total AMPS: Total Connected VA / 240	239.43 AMPS
	Total AMPS: Total Demand VA / 240	140.84 AMPS
	Total AMPS *1.25	176.05 AMPS

PROJECT NAME:	RIVER 504 ROW HOMES			
TOTAL NO. OF UNITS/APTS:	2			
TYPE OF SERVICE:	120/240, 1 PHASE, 3W			
TOTAL LOAD BUILDING	TOTAL CONNECTED VA PER UNIT		# APTS	
TYPE A UNIT 1	33,908	VA	1	33,908 VA
TYPE A UNIT 2	33,874	VA	1	33,874 VA
			TOTAL LOAD =	67,782 VA
	67,782 VA			
TOTAL AMPS = TOTAL DEMAND VA / 240V				282.43 A

PROJECT NAME:	RIVER 504 ROW HOMES			
TOTAL NO. OF UNITS/APTS:	2			
TYPE OF SERVICE:	120/240, 1 PHASE, 3W			
TOTAL LOAD BUILDING	TOTAL CONNECTED VA PER UNIT		# APTS	
TYPE A UNIT 1	33,818	VA	1	33,818 VA
TYPE A UNIT 2	33,802	VA	1	33,802 V
			TOTAL LOAD =	67,620 V
	67,620 V			
TOTA	281.75 A			

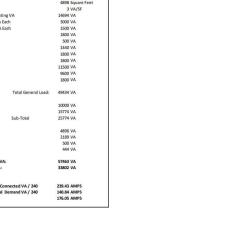



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Z15 FULTON ST, GENEVA, II, 60134

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ELECTRICAL SCHEDULES





RIVER 504 ROWHOMES

542 SOUTH 1ST STREET, ST CHARLES,

ISSUE DATE: POST BID/PERMIT REVISIONS No. Date Description

PROJECT NO. 24-013 MO/ YL DRAWN BY CHECKED BY 13 OF 28

EXTERIOR **ELEVATIONS**



PRELIMINARY PLAT **RIVER 504 ROWHÖMES SUBDIVISION** BEBIO, A RE-QUBOYISION OF LOT 14, 55 AND PARCEL 8 M BROWNSTONE IN THE CITY OF ST. CHARLES, KANE COLMY, LLLMOS, ACCORNION TO THE PLAT THEREOF RECORDED MAINNY 2.001 AS DOCUMENT ZOXIVIOUS AND EMBERG AND TO THE NORTHWEST GUARTER OF SECTION 34, TOWNSHIP 40 NORTH, RANGE BEAST OF THE THIRD PRINCIPAL MERIDIAN, IN THE CITY OF ST. CHARLES, KANE COLMYT, LLIMOS. COBBLESTONE DR SITE ACREAGE OVERALL SUBDIVISION: 29,385 SF 0.675 AC N61°27'22"E 10.47" RIGHT-OF-WAY TO BE DEDICATED: 1.380 SE 0.032 AC FND 3/4" IRON " PIPE AT CORNER TOTAL LOTS: 28,005 SF 0.643 AC *SEE LEFT FOR INDIVIDUAL LOT SIZES 3.6° TO BE DEDICATED TO-THE CITY OF ST. CHARLES LOT 2 3,405 SF 0,078 AC **PUBLIC UTILITY & DRAINAGE EASEMENT** N78'43'18'E (P.U.D.E.) NOTES: A BLANKET P.U.D.E. IS HEREBY GRANTED OVER LOTS 1 THROUGH 8, EXCEPT THOSE PORTIONS WITHIN THE BUILDING FOOTPRINT, AS CONSTRUCTED. THE APPROXIMATE LOCATION OF SAID EXCEPTIONS ARE SHOWN HEREBY, BUT SUBJECT TO CHANGE DUE TO BUILDING RE-DESIGN, AS-BUILT LOCATIONS, AND CONSTRUCTION TOLERANCES. LIMESTONE DR LOT 3 3,405 SF 0,078 AC 1784318E **PUBLIC UTILITY & DRAINAGE EASEMENT** LOT 4 3,405 SF 0,078 AC (P.U.D.E.) PROVISION S. FIRST ST A PERMANENT NON-EXCLUSIVE EASEMENT IS HEREBY GRANTED TO THE CITY OF ST. CHARLES AND TO ALL PUBLIC UTILITY COMPANIES OF ANY KIND OPERATING UNDER FRANCHISE GRANTING THEM EASEMENT RORTH FROM SHOLD OF ST. CHARLES, NOLDING BUT NOT LIMBTO TO, AMERITED AND RUCOT AND TO THEM SEQUESCIONED AND ST. CHARLES, NOLDING BUT NOT LIMBTO TO, AMERITED AND RUCOT AND TO THEM SEQUESCIONED AND SEGMENT COLLECTIVELY REFERRED TO AS AND THE SEQUENCE OF THE PUBLIC UTILITY AND DRAINAGE ASSEMBLY OF THE PUBLIC SEQUENCE OF THE PUBLIC COLLECTIVE AND THE PUBLIC THE PUBLIC COLLECTIVE AND THE P N78'43'18"E 106.40" BLANKET PURE LOT 5 ESTATE PLATTED HERBIN FOR THE NECESSARY PERSONNEL AND GOUPHERS TO MAKE ANY OR ALL OF THE ABOVE WORK. THE PERMANENT MONEXCLUSING EASEMENT IS HERBY PRESERVED FOR AND GRANTED TO THE CITY OF ST. CHARLES AND THE RESPECTIVE SUCCESSORS AND ASSIGNS FOR MOST OF THE CITY OF ST. CHARLES AND THE RESPECTIVE SUCCESSORS AND ASSIGNS FOR MOST OF THE CITY OF N78'43'18"E 106.40" NO PERMANENT BUILDINGS TREES GARDENS SHRURS OR BERMING SHALL BE PLACED ON OR I NO PERMANENT BUILDINGS, TREES, GANGENS, SHRIUS, OR BERMING SHALL BE PLACED NOW AND ADDRESSED SHALL BE PLACED NOW AND ADDRESSED SHALL BE SHALL BE ALCOHOLD AND ADDRESSED SHALL BE ALCOHOLD AND ADDRESSED SHALL BE ALCOHOLD AND ADDRESSED SHALL BE SHALL BE ADDRESSED SHALL BE SHALL BE ADDRESSED SHALL BE ADDRESSED SHALL BE ADDRESSED SHALL BE SHALL BE ADDRESSED SHALL BE ADDRESSED SHALL BE SHALL BE SHALL BE ADDRESSED SHALL BE SHALL BE ADDRESSED SHALL BE SHALL BE SHALL BE ADDRESSED SHALL BE SHALL BE ADDRESSED SHALL BE SHALL BE SHALL BE ADDRESSED SHALL BE SHALL BE SHALL BE ADDRESSED SHALL BE SUBJECT TO THE APPROVAL OF THE CITY OF ST. CHARLES, AS TO DESIGN AND LOCATION, AND ALL OTHER INSTALLATIONS ARE SUBJECT TO THE ORDINANCES OF THE CITY OF ST. CHARLES. FOLLOWING ANY WORK TO BE PERFORMED BY THE GRANTEES IN THE EXERCISE OF ITS EASEMENT FOLLOWING ANTY WORK TO BE PERFORMED BY THE GRAVITES IN THE EXERCISE OF ITS EASEMENT INGHIS GRAVITES ON THE EXERCISE OF ITS EASEMENT INGHIS GRAVITES AND HERED, IT EXPLAINED THE SHEAT OF SHEAT OF SHEAT OF THE RESTORATION, REPAIR, OR RESTORATION, REPAIR, OR REPAIR OR RESTORATION, REPAIR OR RESTORATION OR RESTORATION OF RESTORATION OF REPAIR OR RESTORATION OR REPAIR OR REST FND 5/8" IRON ROD 0.06"S 0.09"W PRAIRIE ST

SURVEYOR'S NOTES

1 SURVEY IS BASED ON FIELD WORK COMPLETED ON FEBRUARY 28, 2025 ONLY THOSE EXISTING EASEMENTS PROVIDED BY CLIENT WERE REVIEWED FOR THIS SURVEY. REFER TO THE DEED, TITLE INSURANCE POLICY AND LOCAL ORDINANCES FOR OTHER RESTRICTIONS. ADDITIONAL EASEMENTS MAY EXIST THAT ARE NOT DEPICTED HEREON.

BASIS OF BEARING: GRID NORTH - ILLINOIS EAST ZONE, STATE PLANE COORDINATE SYSTEM, NAD 83.

IRON PIPES SET SHALL BE 3/4" DIAMETER, BY 24" LENGTH, WHICH EXCEEDS VILLAGE REQUIREMENTS AND MEETS THE STATE OF ILLINOIS

1. SUBDIVIDED PROPERTY LEGAL DESCRIPTION UTILIZED FOR THIS SURVEY WAS FROM WARRANTY DEED RECORDED 4/11/2022 AS DOCUMENT NUMBER 2022K019650.

OWNER/SUBDIVIDER J&B BUILDERS, INC 525 S. Tyler Rd, Unit P St. Charles, IL 60174 PH(80)587 9900

SURVEYOR MeritCorp Group, LLC Aurora, Illinois 60504 Ph. (630) 554-6655



VICINITY MAP

LEGEND

PROPERTY BOUNDARY OFFSITE PROPERTY LINE PROPOSED LOT LINE EASEMENT LINE RECORD DIMENSION CONCRETE MONUMENT FOLIND IRON PIPE FOUND IRON ROD SET 3/4" IRON PIPE SET CUT CROSS EXCEPTION TO P.U.D.E.

P.U.D.E.= PUBLIC UTILITY & DRAINAGE EASEMENT

FND = FOLIND

LOT 14: 15 AND PARCEL O IN RECOVERSTONE IN THE CITY OF ST LOT 14, 15 AND PARCEL 9 IN BROWNSTONE IN THE CITY OF ST. CHARLES, KANE COUNTY, LILMOIS, ACCORDING TO THE PLAT 2001K000148, ALL BEING A PART OF THE NORTHWEST QUARTER OF SECTION 31, TOWNSHIP 40 NORTH, RANGE S EAST OF THE THIRD PRINCIPAL MERIDIAN, IN THE CITY OF ST. CHARLES, KANE COUNTY, LILMOIS

AS SHOWN BY THE SUBDIVISION PLAT WHICH IS A CORRECT REPRESENTATION OF SAID SURVEY AND SUBDIVISION, ALL INSTANCES ARE SHOWN IN FEET & DECIMALS FIREFOR. THIS SUBDIVISION IS WITHIN THE CITY OF ST. CHARLES, ILLINOIS WHICH ADOPTED AND FFICIAL COMPREHENSIVE PLAN ADD IS EXERCISING THE SPECIAL POWERS AUTHORIZED BY THE STATIOF ILLINOIS ACCORDING TO SE ILCS SI11-128 AS HERETOFORE AND HEREAFTER AMENDED, AND THIS SITE FALLS WITHIN
"OTHER AREAS ZONE "X" (AREAS DETERMINED TO BE OUTSIDE
THE 0.2% ANNUAL CHANCE FLOODPLAIN) AS DEFINED BY THE FLOOD INSURANCE RATE MAP COMMUNITY PANEL 170330026 MAP NUMBER 17089C0262H, EFFECTIVE DATE OF AUGUST 3,

GIVEN UNDER MY HAND AND SEAL ON THIS 11TH DAY OF JULY,

CURRENT LICENSE EXPIRES NOVEMBER 30, 2026.

THIS PROFESSIONAL SERVICE CONFORMS TO THE MINIMUN STANDARDS FOR A BOUNDARY SURVEY IN THE STATE OF



Q erit

ori

RIVER 504 ROWHOMES 402-542 SOUTH 1ST STREI ST. CHARLES, ILLINOIS PRELIMINARY PLAT RIVER 504 ROWHOM SUBDIVISION

P PROJECT NO. M24183 DRAWN BY: JDS CHECKED BY: JDS

1/1

SHEET NO.

ABBREVIATIONS

SF = SQUARE FOOTAGE AC = ACREAGE

SURVEYOR'S CERTIFICATE

STATE OF ILLINOIS COUNTY OF DUPAGE

THIS IS TO CERTIFY THAT I, JONATHAN SPINAZZOLA, ILLINOIS LAND SURVEYOR NO. 3868, HAVE SURVEYED AND PROPOSES TO SUBDIVIDE THE FOLLOWING DESCRIBED PROPERTY:

