

# Staff Report Plan Commission Meeting – March 7, 2023

| <u> </u>          |   |  |  |  |
|-------------------|---|--|--|--|
| Applicant:        | Melissa Olson, DRA  | VW Site – Verizon Cell Tower   |  |  |
|                   | Properties  |  |  |  |
| Property Owner:   | St. Charles VW Real Estate  | Cell Tower   |  |  |
| Location:         | 4050 E. Main St./ RT. 64  |  |  |  |
| Purpose:          | Construct Communication   | Subject  |  |  |
|                   | Tower on site   | Property   |  |  |
| Applications:     | Special Use for   |  |  |  |
|                   | Communication Tower   | The state of the s |  |  |
| Public Hearing:   | Yes, required   |  |  |  |
| Zoning:           | BR Regional Business  | CHARLES CHARLES BELLEVILLE   |  |  |
| Current Land Use: | Commercial  | The second time was  |  |  |
| Comprehensive     | Corridor/ Regional  | E. Main St./ RT. 64  |  |  |
| Plan:             | Commercial  | Subject Property   |  |  |
|                   |   | , ,  |  |  |
| Summary of        | Application for Special Use h   | has been submitted to construct a Communication Tower  |  |  |
| Proposal:         | • •   | the property. A Communication Tower is a permitted   |  |  |
| •                 | Special Use in the BR- Regional Business District. A Site Plan has been provided, |  |  |  |
|                   | proposing the following:  |  |  |  |
|                   | <ul> <li>145ft communication town</li> </ul>                                      | ver located at the northeast corner of the property  |  |  |
|                   | <ul> <li>Removal of 6 parking spa</li> </ul>                                      | ces  |  |  |
|                   | • 20'x 30' fenced lease area  | a for tower and equipment  |  |  |
| Info / Procedure  | Special Use:  |  |  |  |
| on Application:   | <ul> <li>Per Sec. 17.04.330, the pr</li> </ul>                                    | urpose of a Special Use is as follows: "Special Uses listed  |  |  |
|                   | -   | districts include those uses that may be acceptable if   |  |  |
|                   | established in an appropr   | iate manner and location within a zoning district, but   |  |  |
|                   | may not be acceptable if  | established in a different manner or location. Special   |  |  |
|                   | Uses may include, but are not limited to, public and quasi-public uses affected   |  |  |  |
|                   | with the public interest, and uses that may have a unique, special or unusual     |  |  |  |
|                   |   | njoyment of neighboring property."   |  |  |
|                   |   | , with a mailed notice to surrounding property owners.   |  |  |
|                   |   | dings must be in the affirmative to recommend  |  |  |
|                   | approval.   | 0  |  |  |
| Suggested Action: |   | ction" for the Commission's options regarding action on  |  |  |
|                   |   | ue regarding a restriction on cell towers in the   |  |  |
|                   | subdivision's Declaration of  |  |  |  |
| Staff Contact:    | Rachel Hitzemann, Planner   |  |  |  |
|                   |   |  |  |  |

# I. PROPERTY INFORMATION


# A. History / Context

The subject property, 4050 E. Main St., is located on the East side of town across from the Pheasant Run property. The parcel is approx. 6.86 acres in size. The existing building on the site is home to a Volkswagen Dealership. The Dealership will remain operating at this location, and the applicant will just lease a small portion of the site. A Verizon communication tower was previously located on the Pheasant Run resort tower, but due to the circumstances surrounding that property Verizon is looking to relocate the tower.

# B. Zoning


The subject property is zoned BR Regional Business District. The same zoning designation exists adjacent to the property on the north, south and east along Main St. East of the property there is also an OR-Office Research parcel. West of the property is unincorporated DuPage County, which is zoned R-3 Single family and O-R Office Research.

| Zoning                                    |  | Land Use                           |  |
|---|--|------------------------------------|--|
| <b>Subject Property</b>                   | BR Regional Business                                     | Volkswagen Dealership              |  |
| North                                     | BR Regional Business Vacant Lot                          |                                    |  |
| East BR Regional Business & OR-           |  | Commercial – Culvers               |  |
|   | Office Research  | Residential- Silverado Memory Care |  |
| South BR- Regional Business Commercial- I |  | Commercial- Pheasant Run           |  |
| West                                      | Unincorporated (R-3 Single Family & O-R Office Research) | Residential & Agriculture          |  |

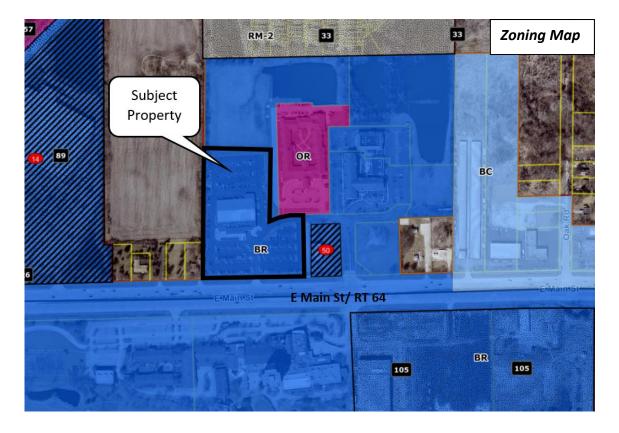

# C. Comprehensive Plan

The subject property is designated Corridor/ Regional Commercial in the Land Use Plan adopted as part of the 2013 Comprehensive Plan. All adjacent properties have the same designation, which is intended for larger shopping centers and developments that have a more regional draw.

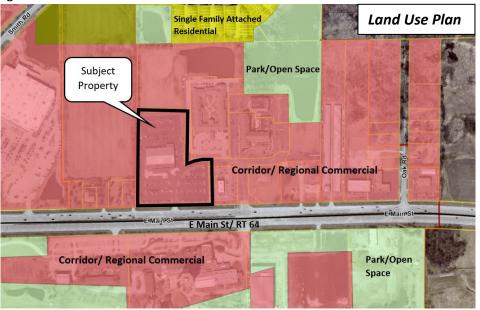

The Corridor/Regional Commercial land use category is described as follows:

Areas designated as corridor/regional commercial are intended to accommodate larger shopping centers and developments that serve a more regional function, drawing on a customer base that extends beyond the City limits. These areas often have a mix of "big box" stores, national retailers, and a "critical mass" of multiple stores and large shared parking areas. Areas designated for corridor/regional commercial are located primarily in larger consolidated areas along the City's heavily traveled corridors and intersections. Commercial service uses can also have an appropriate place in corridor/regional commercial areas, but must be compatible with adjacent and nearby retail and commercial shopping areas and be located as to not occupy prime retail locations. (p.39)

# II. PLANNING ANALYSIS

Staff has analyzed the submitted application and plans for conformance with the standards established in applicable sections of the Zoning Ordinances, including:

- Ch. 17.22 General Provisions
- Ch. 17.14 Business & Mixed Use Districts
- Ch. 17.24 Off-Street Parking, Loading & Access

# A. Proposed Use

Verizon is looking to lease a 20' X 30' portion in the northeast corner of this property to construct a 145' communication tower and install necessary ground equipment.

"Communication Tower" is a Special Use in the BR Regional Business zoning district.

The Zoning Code defines a Communication Tower as;

"A structure designed and constructed primarily for the purpose of supporting one or more Communication Antennas, including self-supporting lattice towers, guy towers

and monopole towers. This use includes radio and television transmission towers, personal communications service (PCS), microwave towers, common-carrier towers, cellular telephone towers, and the like. This use does not include any structure erected solely for a residential, non-commercial individual use, such as television reception antennas, satellite dishes or non-commercial wireless antennas (amateur radio). This use includes Wireless Support Structures supporting Small Wireless Facilities, as defined in and regulated by Chapter 13. 24 " Small Cell Wireless Facilities", when designed and constructed primarily for the purpose of supporting one or more Small Wireless Facilities."

Per Sec. 17.04.330, the purpose of a Special Use is as follows:

"Special Uses listed within the various zoning districts include those uses that may be acceptable if established in an appropriate manner and location within a zoning district, but may not be acceptable if established in a different manner or location. Special Uses may include, but are not limited to, public and quasi-public uses affected with the public interest, and uses that may have a unique, special or unusual impact upon the use or enjoyment of neighboring property."

There are no specific Use Standards in the Zoning Ordinance for Communication Towers. There are six Findings of Fact for Special Uses, all of which must be found in the affirmative for the Plan Commission to recommend approval. The applicant has provided responses to the Findings of Fact, attached to the application.

#### B. Bulk Standards

The table below compares the proposed Site Plan with the applicable requirements of the BR District. Section 17.22.020 contains additional requirements for Communication Tower height and setbacks from residential districts, which are also noted in the table. All bulk standards appear to be met.

| Category                       | BR District | Site Plan         |  |
|--------------------------------|-------------|-------------------|--|
| Min. Lot Area                  | 1 acre      | 6.86              |  |
| Max. Building Coverage         | 30%         | 12% (existing)    |  |
| Max. GFA per Building          | None        | 36,323 (existing) |  |
| Max. Tower Height              | 150ft       | 145ft             |  |
| Tower Setbacks:                |             |                   |  |
| Front (Main St.)               | 20 ft.      | 631 ft.           |  |
| Interior Side (west)           | 20 ft.      | 301 ft.           |  |
| Interior Side (east)           | 15 ft.      | 41ft              |  |
| Rear (south)                   | 30 ft.      | 41 ft.            |  |
| From Residential<br>Properties | 500 ft      | 538 ft and 542 ft |  |

The Monopine tower and fenced enclosure meet all bulk requirements. Please note that the applicant chose to propose a monopine tower, which has the appearance of a pine tree, and that it was not something suggested or required by staff.

The parking spaces removed for this project are not required for the Dealership use and no changes to the dealership are proposed at part of this project.

### C. Site Access

The property is currently accessed via a driveway off of Main St./ RT. 64. No changes will be made to this drive as part of the proposed plan. An access easement over the site will be provided to the applicant from the property owner to conduct repair and maintenance on the tower.

#### III. DEPARTMENTAL REVIEWS

City Staff reviewed the plans and provided technical comments to the applicant.

## IV. DECLARATION OF COVENANTS

This property is located within the Pheasant Run Crossing Subdivision which has a Declaration of Covenants, Conditions and Restrictions. Under that document, cell towers are not permitted. However, there is an appeal process that the applicant and property owner intend to initiate.

City staff has asked for clarification from the owner of the property on the appeal process and what exact steps are being taken to allow Cell Towers. The applicant has asked that the zoning approval process move forward with a condition of approval that the Declaration of Covenants, Conditions and Restrictions shall be amended to allow cell towers.

# V. SUGGESTED ACTION

The applicant has provided responses to the Findings of Fact for Special Use as part of the application. All six findings must be in the affirmative for the Commission to recommend approval.

Based on the outstanding item regarding the cell tower restriction in the subdivision Declaration of Covenants, the Plan Commission may choose to:

- a. Open the public hearing on the Special Use and immediately continue the item until clarification on resolution to the Declaration of Covenants can be provided.
   OR
- b. Conduct the public hearing on the Special Use and continue the item until further clarification on resolution to the Declaration of Covenants can be provided.

Due to the outstanding issue with the Declaration of Covenants, staff does not recommend closing the public hearing and making a recommendation. Part of the resolution to the Declaration may require a change in the plans, which would be easier to address as part of the current public hearing process.

# VI. ATTACHMENTS

- Applications for Special Use; received 12/19/2022
- Plans
- Airspace Map & Study dated 10/6/2022

City of St. Charles **Community Development Division** 2 E. Main Street St. Charles, IL 60174



Phone: (630) 377-4443 Email: cd@stcharlesil.gov

# **SPECIAL USE APPLICATION**

(To request a Special Use or Amendment, or a Special Use for PUD or Amendment)

**For City Use** 

Project Name: Project Number:

Cityview Project Number: PL5U2D2200086

Received Date
RECEIVED

DFC 19 2022

City of St. Charles Community Development

- File this application to request a Special Use for a property, or to request to amend an existing Special Use Ordinance for a property
- Complete the application and submit with all required attachments to the Community Development Division.
- The information you provide must be complete and accurate. If you have a question please contact the Community Development Division.
- City staff will review the submittal for completeness and for compliance with applicable requirements prior to establishing a public hearing date.

| 1.   | Property                  | Location:   |                                |  |  |  |
|--|---------------------------|---|--------------------------------|--|--|--|
|  | Information:              | 4050 E. Main Street, St. Charles, IL 60174                |                                |  |  |  |
| nemerous estamoshumelmostrale (dife  |                           | Parcel Number (s): 0130102045 0130102045                  |                                |  |  |  |
| ne promi ortungenskilekelekelekelekelek  |                           | Proposed Name:  Verizon Cell Tower  Verizon Cell Tower    |                                |  |  |  |
| 2.   | Applicant                 | Name:   | Phone:                         |  |  |  |
|  | Information:              | DRA Properties, LLC                                       | 314-890-8566                   |  |  |  |
|  |                           | Address   | Email:                         |  |  |  |
| Agricon communication and communication of the comm |                           | 343 S. Kirkwood Rd., #5, Box 220130<br>Kirkwood, MO 63122 | molson@dolanrealtyadvisors.com |  |  |  |
| 3.   | Record Owner Information: | Name:<br>St. Charles VW Real Estate                       | Phone: 630-818-4150            |  |  |  |
|  |                           | Address:  | Email:                         |  |  |  |
|  |                           | 1421 E. Main Street, St. Charles, IL 60174                | emir@foxvalleyag.com           |  |  |  |

| 4. | Ide | entify the Type of Application:  |
|----|-----|--|
| [  |     | Special Use for Planned Unit Development - PUD Name:  New PUD  Amendment to existing PUD- Ordinance #:  PUD Preliminary Plan filed concurrently        |
| [  | V   | Other Special Use (from list in the Zoning Ordinance): 17.22.020  Newly established Special Use  Amendment to an existing Special Use Ordinance #:     |
| 5. | Inf | ormation Regarding Special Use:  |
|    |     | Comprehensive Plan designation of the property: Neighborhood Commercial  |
|    |     | Is the property a designated Landmark or in a Historic District? No  |
|    |     | What is the property's current zoning? BR Regional Business District   |
|    |     | What is the property currently used for? Car dealership  |
|    |     | If the proposed Special Use is approved, what improvements or construction are planned? Install a 145' cell tower on a leased area measuring 20' x 60' |
|    |     |  |
| 6. | For | Special Use Amendments only:   |
|    |     | Why is the proposed change necessary?  N/A   |
|    |     | IN/A   |
|    |     | What are the proposed amendments? (Attach proposed language if necessary)  |
|    |     | N/A  |
|    |     |  |
|    |     |  |

**Note for existing buildings:** If your project involves using an existing building, whether you plan to alter it or not, please contact the St. Charles Fire Department (630-377-4458) and the Building and Code Enforcement Division (630-377-4406) for information on building, life safety and other code requirements. Depending on the proposed use, size of structure and type of construction, these requirements can result in substantial costs.

| 7.             | Requi  | red Attachments:       |                         |                       |                        |   |                    |
|----------------|--|------------------------|-------------------------|-----------------------|------------------------|---|--------------------|
|                | If multiple zoning or subdivision applications will be submitted concurrently, do not submit duplicate checklist items |                        |                         |                       |                        |   |                    |
|                | or plan  | s. Fee must be paid    | for each application    | n.                    |                        |   |                    |
|                |  |                        |                         |                       |                        |   |                    |
|                | APPLIC   | ATION FEE: Specia      | al Use for PUD: \$1,0   | 00                    |                        |   |                    |
|                |  |                        | ner Special Use requ    |                       |                        |   |                    |
|                |  |                        |                         |                       |                        |   |                    |
|                | REIMB  | URSEMENT OF FEE        | S AGREEMENT: An         | original, executed    | Reimbursement of       | f Fees Agreement a                      | nd deposit of      |
| Ш              |  |                        | City, as provided by    |                       |                        | _                                       |                    |
|                |  |                        | 5.1, 40 p. 01.000 2,    | ripperialize of the   | Loring Oranionec.      |   |                    |
|                | REIMB  | URSEMENT OF FEE        | S INITIAL DEPOSIT:      | Deposit of funds in   | n escrow with the      | City. Required depo                     | sit is based on    |
|                |  |                        | applications filed) ar  |                       |                        |   |                    |
|                |  | Number of              |                         |                       |                        |   | 1                  |
|                |  | Review Items           | Under 5 Acres           | 5-15 Acres            | 16-75 Acres            | Over 75 Acres                           |                    |
|                |  | 1                      | \$1,000                 | \$2,000               | \$3,000                | \$4,000                                 | 1                  |
|                |  | 2 or 3                 | \$2,000                 | \$4,000               | \$5,000                | \$7,000                                 | 1                  |
|                |  | 4 or more              | \$3,000                 | \$5,000               | \$7,000                | \$10,000                                | 1                  |
|                | 1  | 701111010              | 40,000                  | <del>φ3,000</del>     | 47,000                 | 710,000                                 | J                  |
|                | PROOF  | OF OWNERSHIP:          | a) A current title po   | licy report: or       |                        |   |                    |
|                |  |                        | b) A deed and a cur     |                       |                        |   |                    |
|                |  |                        | •                       |                       |                        |   |                    |
|                | NOTE: F  | Private covenants and  | l deed restrictions can | limit private propert | ty rights with respect | t to the use of land ev                 | en though the      |
|                |  |                        | authorize the use or o  |                       |                        |   |                    |
|                |  |                        | e any private covenar   |                       |                        |   |                    |
|                |  |                        | ons may conflict with   |                       |                        |   |                    |
|                | an atto  | rney to obtain an opir | nion with respect to w  | hether your intended  | d use is compatible w  | vith those restrictions                 |                    |
|                | OWNE   | DENID DISCLOSIDE       | : Use the appropria     | ata disalasura farm   | (attached) if the      | aumar ar analisant                      | ia a               |
|                |  | rship, Corporation,    |                         | ite disclosure form   | (attacheu), ii the     | owner or applicant                      | 15 d               |
|                | raitile  | isinp, corporation,    | irust, or LLC.          |                       |                        |   |                    |
|                | LETTER   | OF ALITHORIZATIO       | ON: If the property     | owner is not the a    | nnlicant an origina    | al letter of authoriza                  | ation from the     |
|                |  |                        | g the applicant to fil  |                       |                        |   |                    |
|                | proper   |                        | 5 the applicant to m    | e the zoning appin    | sacion with the city   | y or st. charles for t                  | ne subject         |
|                | p. opc.  | -,.                    |                         |                       |                        |   |                    |
| 1              | LEGAL  | DESCRIPTION: For       | entire subject prop     | erty on 8 1/2 x 11    | inch naner and Mi      | crosoft Word file                       |                    |
| 3              |  |                        | onthi o subject prop    | 010,01101,211         | men paper and ivi      | crosort word me.                        |                    |
|                | PLAT C   | F SURVEY: A curre      | nt plat of survey for   | the subject prope     | rty showing all evi    | sting improvements                      | s on the           |
|                |  |                        | egistered Illinois Pro  |                       |                        | oung improvement                        | , on the           |
|                | Je Je  | -,, ppaa a, a          | 0.000                   |                       |                        |   |                    |
|                | FINDIN   | GS OF FACT: Fill ou    | ut the attached "Cri    | teria for Planned U   | Init Developments      | (PUDs)" form for a                      | nv PUD             |
|                |  |                        | ngs of Fact – Specia    |                       |                        |   | ,,                 |
|                |  |                        |                         |                       |                        | ,,,,,,,,,,,,,,,,,,,,,,,,,,,,,,,,,,,,,,, |                    |
|                | LIST O   | PROPERTY OWNE          | RS WITHIN 250 FT.:      | Fill out the attach   | ed form or submit      | on a separate shee                      | et. The form or    |
|                |  |                        | d notarized. Propert    |                       |                        |   |                    |
|                |  |                        | ool: http://gistech.co  |                       |                        |   | a man according to |
| heronistensing |  | 5                      |                         | A distant             |                        |   |                    |
|                | SOIL A   | ND WATER CONSE         | RVATION DISTRICT I      | LAND USE OPINIO       | N APPLICATION: A       | s required by State                     | law, submit a      |
|                |  |                        | ion and required fe     |                       |                        |   |                    |
|                |  |                        | ed Land Use Opinio      |                       |                        |   |                    |
|                |  |                        | e SWCD website: ht      |                       |                        |   |                    |

| <b>ENDANGERED SPECIES REPORT:</b> As required by State law, file an Endangered Species Consultation Agency Action with the Illinois Department of Natural Resources. Provide a copy of the report to the City. The online Ecological Compliance Assessment Tool (EcoCAT) should be utilized: <a href="https://dnr2.illinois.gov/EcoPublic/">https://dnr2.illinois.gov/EcoPublic/</a>  |
|---|
| <b>TRAFFIC STUDY:</b> If applicable. Staff will advise you whether a traffic study is recommended based on the project. Regardless, the Plan Commission or City Council may request a traffic study as a part of the review process.  |
| <b>PLANS:</b> All required plans shall be drawn on sheets no larger than 24" x 36", unless the Director of Community Development permits a larger size when necessary to show a more comprehensive view of the project. All required plans shall show north arrow and scale, and shall be drawn at the same scale (except that a different scale may be used to show details or specific features). All plans shall include the name of the project, developer or owner of site, person or firm preparing the plan, and the date of plan preparation and all revisions. |

Copies: Ten (10) full size copies, one (1) 11" by 17", and PDF electronic file emailed to: cd@stcharlesil.gov

# Site Plan or plans shall show the following information:

- 1. Accurate boundary lines with dimensions
- 2. Streets on and adjacent to the tract: Name and right-of-way width
- 3. Location, size, shape, height, and use of existing and proposed structures
- 4. Location and description of streets, sidewalks, and fences
- 5. Surrounding land uses
- 6. Date, north point, and scale
- 7. Ground elevation contour lines
- 8. Building/use setback lines
- 9. Location of any significant natural features
- 10. Location of any 100-year recurrence interval floodplain and floodway boundaries
- 11. Location and classification of wetland areas as delineated in the National Wetlands Inventory
- 12. Existing zoning classification of property
- 13. Existing and proposed land use
- 14. Area of property in square feet and acres
- 15. Proposed off-street parking and loading areas
- 16. Number of parking spaces provided, and number required by ordinance
- 17. Angle of parking spaces
- 18. Parking space dimensions and aisle widths
- 19. Driveway radii at the street curb line
- 20. Width of driveways at sidewalk and street curb line
- 21. Provision of handicapped parking spaces
- 22. Dimensions of handicapped parking spaces
- 23. Depressed ramps available to handicapped parking spaces
- 24. Location, dimensions and elevations of freestanding signs
- 25. Location and elevations of trash enclosures
- 26. Provision for required screening, if applicable
- 27. Exterior lighting plans showing:
  - a. Location, height, intensity and fixture type of all proposed exterior lighting
  - b. Photometric information pertaining to locations of proposed lighting fixtures

(Note- For a Special Use for PUD, submit PUD Preliminary Plan Application In lieu of Site Plan)

I (we) certify that this application and the documents submitted with it are true and correct to the best of my (our) knowledge and belief.

| Record Owner                  | Date     |
|-------------------------------|----------|
| Melussa Dison                 | 12/14/22 |
| Applicant or Authorized Agent | Date     |

# **Zoning Letter of Authorization**

To: Rachel Hitzemann

City of St. Charles IL Planning & Zoning

I, Emir Abinion, am the authorized signer for St. Charles VW Real Estate LLC, owner of the property located at 4050 E. Main Street in St. Charles, IL.

I give Melissa Olson with DRA Properties, LLC permission to file this zoning application with the City of St. Charles for a proposed communications tower.

**Emir Abinion** 

Date: 1/5/23

# OWNERSHIP DISCLOSURE FORM LIMITED LIABILITY COMPANY (L.L.C.)

| 5+ | STATE OF ILLINOIS )  Louis ) SS.  KANE COUNTY )  |
|----|--|
|    | I, Douglas Dolan being first duly sworn on oath depose and say that I am   |
|    | Manager of DRA Properties , an Illinois Limited Liability  |
|    | Company (L.L.C.), and that the following persons are all of the members of the said L.L.C.:  |
|    | Douglas Dolan  |
|    |  |
|    |  |
|    |  |
|    |  |
|    |  |
|    |  |
|    | By: Down Dive Manager  |
|    | Subscribed and Sworn before me this  |
|    | MARGIE D. OLIVER Notary Public, Notary Seal State of Missouri St. Louis County Commission # 12441174 My Commission Expires 12-30-2024  Notary Public |

# FINDINGS OF FACT - SPECIAL USE

\*Use this form for all Special Uses, except for PUDs or PUD Amendments\*

The St. Charles Zoning Ordinance requires the Plan Commission to consider the factors listed below in making a recommendation to the City Council. As the applicant, the "burden of proof" is on you to show how your proposed Special Use will comply with each of the applicable standards. Therefore, you need to "make your case" by explaining specifically how your project meets each of the following standards.

Project Name or Address: DRA Properties, LLC

# From the St. Charles Zoning Ordinance, Section 17.04.430.C.2:

No Special Use or amendment to Special Use shall be recommended by the Plan Commission unless it finds that the proposed Special Use or amendment to Special Use will conform with each of these standards. The Plan Commission shall submit its written findings together with its recommendations to the City Council after the conclusion of the Public Hearing, and also may recommend such conditions as it may deem necessary to ensure conformance with these standards.

On the basis of the evidence presented at the public hearing, the Plan Commission shall record its reasons for recommending approval or denial of the petition (findings of fact) in accordance with the following standards:

A. Public Convenience: The Special Use will serve the public convenience at the proposed

This tower will imporove coverage and capacity to the City of St. Charles. It will also enhance E-911 services.

B. Sufficient Infrastructure: That adequate utilities, access roads, drainage and/or necessary utilities have been, or are being, provided.

The adequate utilities will be provided.

| C. | Effect on Nearby Property: That the Special Use will not be injurious to the use and enjoyment of other property in the immediate vicinity for the purposes already permitted, nor substantially diminish or impair property values within the neighborhood.   |
|----|--|
|    | The Special Use will not be injurious to the use and enjoyment of other property in the immmediate vicinity for the purposes already permitted, nor will substantially diminish or impair property values within the neighborhood.   |
| D. | Effect on Development of Surrounding Property: That the establishment of the Special Use will not impede the normal and orderly development and improvement of the surrounding property for uses permitted in the district.  |
|    | The establishment of the Special Use will not impede the normal and orderly development and improvement of the surrounding property for uses permitted in the district.  |
| E. | Effect on General Welfare: That the establishment, maintenance or operation of the Special Use will not be detrimental to or endanger the public health, safety, comfort or general welfare.   |
|    | Three establishment intraintenance; retropertation exittes previous beservitlental bear establishment intraintenance; retropertation exitety; conflictly, conflict |
|    | general welfare. A cell tower is equivalent to a home wifi system or barby monitor and falls within FCC regulations.   |
| F. | Conformance with Codes: That the proposed Special Use conforms to all applicable provisions of the St. Charles Municipal Code and meets or exceeds all applicable provisions of this Title, except as may be varied pursuant to a Special Use for Planned Unit Development.  |
|    | The proped कि इंग्रेडिश एक एक कि नी कार्य ज्यापित कार्य होता के कि   |
|    | The proposed Special use conforms to all applicable provising  |
|    | of the St. Charles Municipal Code and meets or exceeds all applicable provisions of this Title,  |
|    |  |

# NONRESIDENTIAL ZONING COMPLIANCE TABLE

Name of Development: St. Charles VW Real Estate

|   | Zoning District Requirement District: | Existing PUD Requirement (if applicable) Ordinance #: ain Street, St. Charles | Proposed        |
|---|---------------------------------------|---|-----------------|
| Minimum Lot Area                              | lacre                                 |   | i _59ft-        |
| Minimum Lot Width                             | None                                  |   | 20×60ft.        |
| Maximum Building Coverage                     | 3090                                  |   | Outdoor cabinet |
| Maximum Gross Floor Area per<br>Building      | None                                  |   | AU              |
| Maximum Building Height                       | 40 ft_                                |   | 145'            |
| Front Yard                                    | Min. 2097.                            |   | 42'             |
| Interior Side Yard                            | Min. 15ft.                            |   | 30              |
| Exterior Side Yard                            | Min 20ft.                             |   | 30'             |
| Minimum Rear Yard                             | 30 ft.                                |   | ' 15'           |
| Landscape Buffer Yard <sup>2</sup>            | 40 At.                                |   | NA              |
| % Overall Landscaped Area                     | 7590                                  |   | NA              |
| Building Foundation<br>Landscaping            | NA                                    |   | NIA             |
| Public Street Frontage<br>Landscaping         | yes                                   |   | yes             |
| Parking Lot Landscaping                       |                                       |   | Alu             |
| # of Parking Spaces                           |                                       |   | 6               |
| Drive-through Stacking Spaces (if applicable) | NA                                    |   | NA.             |

<sup>&</sup>lt;sup>2</sup> Within the zoning districts specified, a Landscape Buffer Yard shall be provided along any lot line that abuts or is across a street from property in any RE, RS, RT or RM District. See Chapter 17.26 for planting and screening requirements for Landscape Buffers. Landscape Buffer Yards may include or overlap with other required yards.

# **Documentation that lead to this location**

The city has a 500' setback from residential property. This is the only location based on the search ring we were given.

The DuPage airport is in close proximity to our location and we needed to stay out of the protected airspace.



# FULL RELO **SMITH & MAIN**

**CELL SITE** 

LOCATION NO. 711056 PROJECT NO. 20222341126

IL-64 ST CHARLES, IL 60174 **DUPAGE COUNTY** 

145' MONOPINE TOWER WITH COMMUNICATIONS EQUIPMENT

# DRAWING INDEX

#### TOWER DEVELOPMENT OWNER CONSTRUCTION SECTION

PROJECT INFORMATION, LOCATION MAPS, AND DRAWING INDEX

1 OF 2 SITE SURVEY

2 OF 2 SITE SURVEY

GN-1 GENERAL CONSTRUCTION NOTES

TYPICAL FENCE DETAILS

C-1 SITE LOCATION PLAN DEVELOPED SITE PLAN C-2 C-3 ENLARGED SITE PLAN C-4 SITE CIVIL DETAILS

TOWER ELEVATION

UTILITY SITE PLAN, AND NOTES ELECTRIC AND TELCO UTILITY DETAILS ENLARGED GROUNDING PLAN

GROUNDING DETAILS

APPLICANT UTILITIES - ELECTRIC

VERIZON WIRELESS
DAVID HENDRIXSON
1701 GOLF ROAD, TOWER 2, SUITE 400
ROLLING MEADOWS, IL 60008
PH. (231) 578—8860
EMAIL DAVID HENDRIXSON®
CHARLON WIRELESS.COM

SITE ACQUISITION

DOLAN REALTY ADVISORS, LLC DOUG DOLAN 343 S. KIRKWOOD ROAD #5 BOX# 220130 KIRKWOOD, MO 63122 PH: (314) 963-7700 EMAIL: DDOLAN@DOLANREALTYADVISORS.COM

SURVEYOR

SURVETUR
WILLIAMS & WORKS
BILL MCCLURE
549 OTTAWA AVE NW
GRAND RAPIDS, MI 49503
PH: (616) 224-1500
EMAIL:
MCCLURE@WILLIAMS-WORKS.COM

ARCHITECTURAL AND ENGINEERING

CONSULTANT TEAM

SITE COORDINATES AND ELEVATION

LATITUDE - N41° 55′ 24.08″ LONGITUDE - W88° 15′ 23.01″ GRD ELEV. - ±764′ AMSL

PROJECT DESCRIPTION

MISSION 1 COMMUNICATIONS
MARK ALLEN
6202 CONSTITUTION DRIVE, SUITE C
FORT WAYNE, IN 46804 PH: (260) 436-3922 EMAIL: MALLEN@M1COMM.COM

UTILITIES - FIBER TBD FIBER PROVIDER NOT SELECTED AT THE TIME OF RELEASE

POLICE DEPARTMENT ST CHARLES POLICE DEPT 1515 W MAIN ST, ST. CHARLES, IL 60174 PH: (630) 377-4435

FIRE DEPARTMENT ST CHARLES FIRE DEPT 112 N RIVERSIDE AVE, ST. CHARLES, IL 60174 PH: (630) 377-4458

LANDLORD

ST CHARLES VW REAL ESTATE 4050 E MAIN ST, ST. CHARLES, IL 60174 PH: (630) 818-4150







FIBER COORDINATION IS NOT COMPLETE (PENDING FIBER CONTACT). PRIOR TO CONSTRUCTION, CONTACT DESIGNER FOR UPDATE.







CERTIFICATION: PRELIMIN ARY RELINITAR FOR CONSTRUCTION

| RELEASE  |                       |
|----------|-----------------------|
| DATE     |                       |
| 08-11-22 | PRELIMINARY SITE PLAN |
| 09-22-22 | PRELIMINARY SITE PLAN |
| 11-09-22 | LEASE EXHIBIT         |
| 12-09-22 | LEASE EXHIBIT         |
| 12-29-22 | LEASE EXHIBIT         |
| 01-30-22 | 90% CDs               |
|          |                       |
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|          |                       |

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SITE NAME:

**FULL RELO** SMITH & MAIN **CELL SITE** 

SITE ADDRESS:

IL-64 ST CHARLES. IL 60174

SHEET TITLE:

PROJECT INFORMATION, LOCATION MAPS, AND DRAWING INDEX

A&E PROJECT NO.:

SHEET NO.:

T-1



INSTALLATION OF PANEL ANTENNA, ASSOCIATED APPLIANCES, COAXIAL CABLE AND MOUNTS ON AN 145' MONOPINE TOWER.


INSTALLATION OF A 4"-0" X 11"-0" UNMANNED EQUIPMENT PAD ON CONCRETE FOUNDATION. INSTALLATION OF GENERAC SD030-1PE-190JT 30KW DIESEL GENERATOR ON EQUIPMENT CONCRETE FOUNDATION.


NEW TELEPHONE (FIBER) SERVICE TO SITE AND EQUIPMENT SKID. NO WATER SUPPLY OR SEWAGE TO/FROM THE SITE.

DIRECTIONS TO SITE

LOCATION MAP

AERIAL MAP PROVIDED BY GOOGLE EARTH

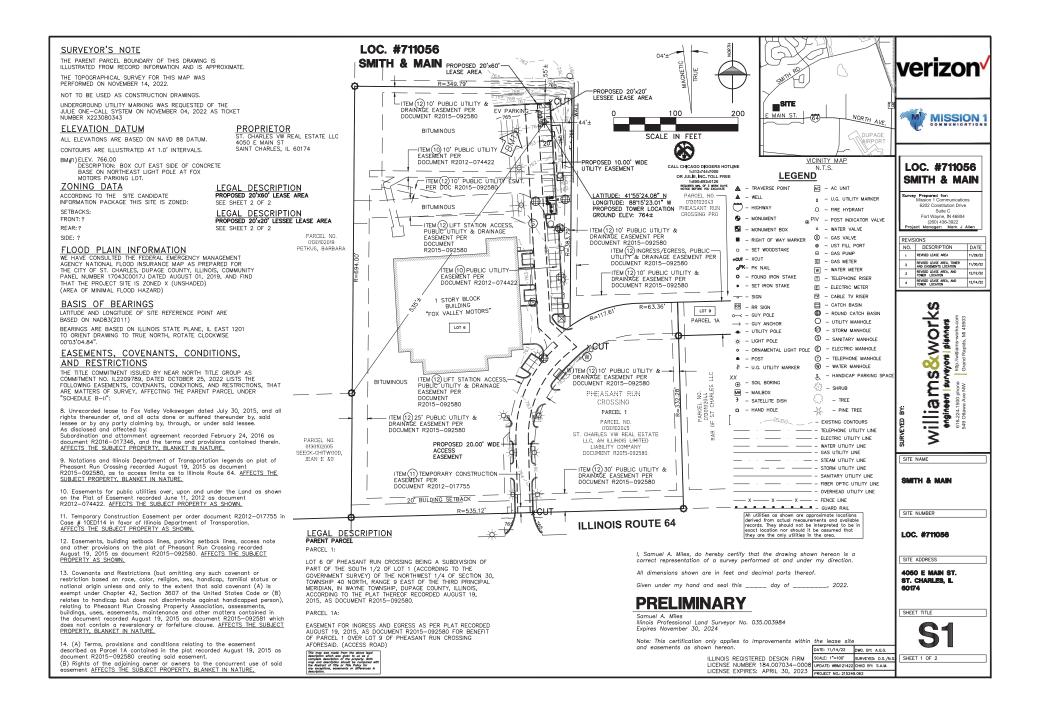

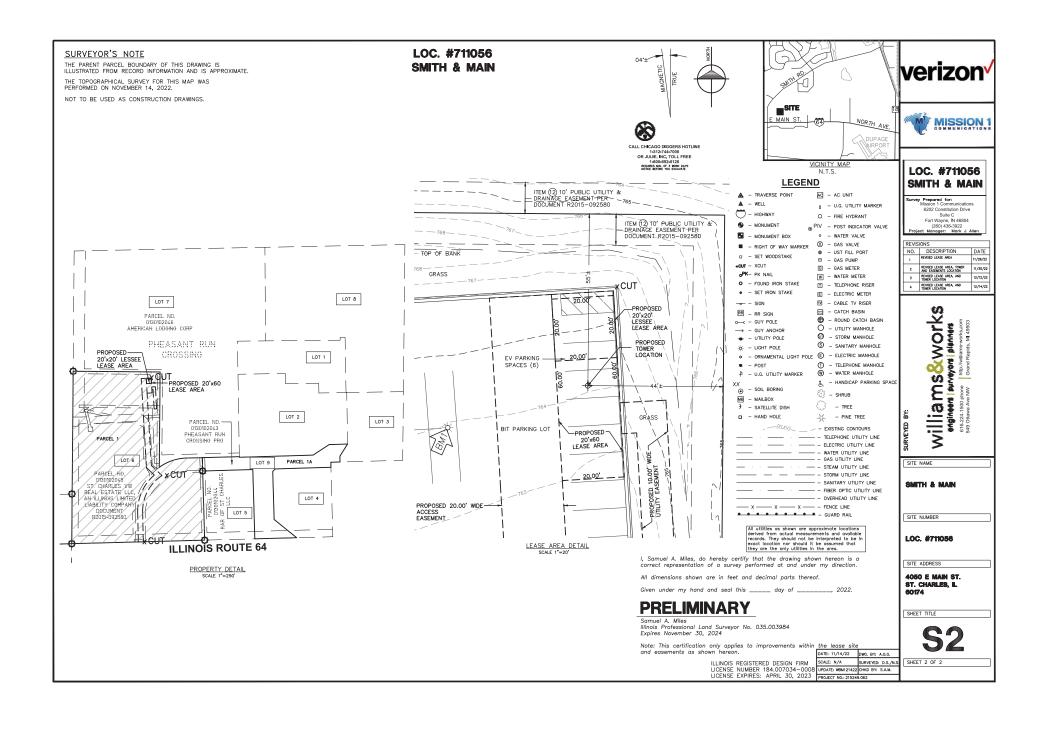

# Abbreviations and Symbols

|   | reviations an  |  |   |
|---|--|--|---|
| A/C<br>ADJ<br>AFF<br>APPROX<br>ASTM                       | AIR CONDITIONING ADJUSTABLE ABOVE FINISH FLOOR APPROXIMATELY AMERICAN SOCIETY FOR  | N<br>N/A<br>NIC<br>NTS                                       | NORTH<br>NOT APPLICABLE<br>NOT IN CONTRACT<br>NOT TO SCALE                                    |
| AWG   | TESTING AND MATERIALS<br>AMERICAN WIRE GAUGE                                       | 0/C,O.C.<br>OD<br>OPG  | ON CENTER<br>OUTSIDE DIAMETER<br>OPENING  |
| BLDG<br>BLK<br>BMR<br>B/S                                 | BUILDING<br>BLOCK<br>BASE MOBILE RADIO<br>BUILDING STANDARD                        | OPP<br>PLYWD<br>PR   | OPPOSITE<br>PLYWOOD<br>PAIR   |
| CLG<br>CLR  | CEILING<br>CLEAR   | PROJ<br>PROP<br>PT   | PROJECT<br>PROPERTY<br>PRESSURE TREATED   |
| CND,C<br>CONC<br>CONST<br>CONT                            | CONDUIT<br>CONCRETE<br>CONSTRUCTION<br>CONTINUOUS                                  | REQ'D<br>RM<br>RO  | REQUIRED<br>ROOM<br>ROUGH OPENING   |
| DBL<br>DIA,Ø<br>DIAG<br>DIM<br>DN<br>DTL,DETL<br>DWG      | DOUBLE DIAMETER DIAGONAL DIMENSION DOWN DETAIL DRAWING EAST                        | S<br>SHT<br>SIM<br>SPEC<br>SQ<br>SS<br>STL<br>STRUCT<br>SUSP | SOUTH SHEET SIMILAR SPECIFICATION SQUARE STAINLESS STEEL STEEL STEUCTURAL SUSSESSIONED        |
| E<br>EA<br>EL,ELEV<br>ELECT<br>EQ<br>EQUIP<br>EW<br>EXIST | EASI EACH ELEVATION ELECTRICAL EQUAL EQUIPMENT EACH WAY EXISTING                   | THRU<br>TNND<br>TOC<br>TOM<br>TYP                            | SUSPENDED<br>SHEET VINYL<br>THROUGH<br>TINNED<br>TOP OF CONCRETE<br>TOP OF MASONRY<br>TYPICAL |
| FIN<br>FLUOR<br>FLR<br>FT                                 | EXTERIOR  FINISH FLUORESCENT FLOOR FOOT  | UBC  | UNIFORM BUILDING<br>CODE<br>UNLESS NOTED<br>OTHERWISE   |
| GA<br>GALV<br>GC  | GAUGE<br>GALVANIZE(D)<br>GENERAL CONTRACTOR  | VERT<br>VIF<br>VT  | VERTICAL<br>VERIFY IN FIELD<br>VINYL TILE   |
| GRND<br>GWB<br>GYP BD                                     | GROUND<br>GYPSUM WALL BOARD<br>GYPSUM BOARD  | W<br>W/<br>WN  | WEST<br>WITH<br>WINDOW  |
| HARD'WD<br>HORIZ<br>HR<br>HT<br>HVAC                      | HARDWOOD<br>HORIZONTAL<br>HOUR<br>HEIGHT<br>HEATING, VENTING &<br>AIR CONDITIONING | ₩/O<br>₩P  | WITHOUT<br>WATERPROOF   |
| ID<br>IN<br>INFO<br>INSUL.<br>INT                         | INSIDE DIA.<br>INCH<br>INFORMATION<br>INSULATION<br>INTERIOR                       | & Q.P. 00#   | AND<br>CENTER LINE<br>PROPERTY LINE<br>AT<br>NUMBER   |
| LB(S)   | POUND(S)   |  |   |
| MAX<br>MECH<br>MET,MTL<br>MFR<br>MGR<br>MIN<br>MISC       | MAXIMUM MECHANICAL METAL MANUFACTURER MANAGER MINIMUM MISCELLANEOUS                |  |   |

# Symbols

| Â               | REVISION    | 1<br>T-1 DETAIL REFERENCE |
|-----------------|-------------|---------------------------|
| $\triangleleft$ | KEY NOTE    |                           |
| 100             | ROOM NUMBER | 1 ELEVATION REFERENCE     |
| 22              | KEYED NOTE  | SECTION REFERENCE         |

#### **General Notes**

- SCHEDULE: THE CONSTRUCTION OF THE SITE REQUIRES A CERTAIN SEQUENCE OF EVENTS
   TO MINIMIZE CONSTRUCTION TIME REQUIRED UNTIL AVAILABILITY OF CELLULAR TELEPHONE
  SERVICE.
- CONSTRUCTION STAKING: THE GENERAL CONTRACTOR SHALL CONTACT THE SURVEYOR TO SCHEDULE CONSTRUCTION STAKING. SURVEYOR TO STAKE LEASE AREA CORNERS, EQUIPMENT PAD CORNERS, CENTER OF THE 3 TOWER LEGS (VERFY LEG CENTER LINE DIMENSION WITH TOWER DRAWNIGS) AND CENTERLINE OF ALL ACCESS AND UTILITY EASEMENTS.
- 3. SITE CLEARING EXCAVATION AND FILL: ALL NEW EQUIPMENT PAD AND TOWER LOCATIONS SHALL BE CLEARED OF ALL TOPSOIL AND VEGETATION. CONTRACTOR SHALL USE EXCAVATION AND MATERIAL FROM FOUNDATION EXCAVATION AND SHALL PROVIDE, SPREAD AND COMPACT BANK RUN GRAVEL AS REQUIRED TO BRING EQUIPMENT PAD UP TO ELEVATIONS AS INDICATED BY THE FINAL SUBG—RADE LEEVATIONS AS SHOWN ON THE PLANS.
- 4. EQUIPMENT SKID FOUNDATIONS: THE CONTRACTOR SHALL INSTALL THE EQUIPMENT EQUIPMENT PAD FOUNDATION AND TOWER FOUNDATION(S) INCLUDING THE ANCHOR BOLTS AS FUNNISHED BY THE TOWER MANUFACTURER (TOWER FABRICATION, ERECTION, AND ANTENNA INSTALLATION SHALL BE BY OTHERS). CONTRACTOR SHALL CONTACT THE GEOTECHNICAL CONSULTANT FOR ON SITE INSPECTIONS PRIOR TO POURING CONCRETE FOR TOWER AND EQUIPMENT PAD FOUNDATIONS. CONCRETE CORES (THREE (3) CYLINDERS PER TRUCK) TO BE TAKEN AND TESTED BY THE CONSULTANT AND PROVIDET THREE (3) COPIES OF THE TESTING RESULTS TO THE VERIZON WIRELESS PROJECT MANAGER.
- RESULTS TO THE VERIZON WRIELESS PROJECT MANAGER.

  5. PREFABRICATE DEUIPMENT PAD: THE GENERAL CONTRACTOR SHALL PROVIDE ALL LABOR EQUIPMENT AND MATERIALS FOR THE PROPER LITTING OF THE FOUIPMENT PAD FROM THE TRANSPORT TRUCK BED TO THE FINAL POSITION ON THE CONCRETE FOUIPMENT PAD SHALL BE LIFTED INTO PLACE BY USING EIGHT (8) LIFTING EYELETS PROVIDED BY THE COUPMENT PAD MANUFACTURER REQUIRES EIGHT (8) 3/4" DIA, 15" CLONG STEEL CABLES CONNECTED THE SPREADER BAR. IF THE SPREADER BAR. IS THE SPREADER BAR IS AT LEAST TWO FETT WIDER THAN THE EQUIPMENT PAD, CONNER PROTECTIONS WILL NOT NEED TO THE APPROXIMATE WEIGHT OF THE COUPMENT PAD WITH THE TEPFHONE OF THE COUPMENT PAD MANUFACTURER. THE VERIZON WIRLESS EQUIPMENT PAD SHALL NOT BE USED FOR THE STORAGE OF ANY MATERIALS, TOOLS, ETC. USED BY THE CONTRACTOR SHALL NOT BE USED FOR THE STORAGE OF ANY MATERIALS, TOOLS, ETC.
- 6. THE GENERAL CONTRACTOR IS RESPONSIBLE FOR THE INSTALLATION OF THE ELECTRICAL DISCONNECT, EXTERIOR LIGHT FIXTURE, DOOR CANOPIES (WITH CAULKING), MUFFLER AND LOOSE SHIP MATERIALS, INCLUDING FUELING, START UP AND TESTING (COORDINATE WITH OPERATIONS TO SET GENERATIOR ROUTINE RUN DATE).
- THE GENERAL CONTRACTOR SHALL INSTALL THE TOWER FOUNDATION, INCLUDING THE ANCHOR BOLTS AS FURNISHED BY THE TOWER MANUFACTURER. TOWER FABRICATION, ERECTION, AND ANTENNA INSTALLATION SHALL BE BY OTHERS.
- 8. ACCESS DRIVEWAY: THE GENERAL CONTRACTOR SHALL CONSTRUCT THE ACCESS DRIVEWAY PER THE ALIGNMENT AND CROSS SECTION ON THE DRAWNICS. IF ANY AREA OF CONSTRUCTION REQUIRES MORE FILL OF AGGREGATE STORE HAN SHOWN ON THE DRAWNICS, THE GENERAL CONTRACTOR SHALL NOTIFY THE ARCHITECT FOR APPROVAL OF THE 32E. TYPE AND QUANTITY OF STORE/FILL NECESSARY, AND SHALL NOT BE USED UNTIL APPROVAL BY THE ARCHITECT/ENGINEER.
- Utilities: The ceneral contractor shall be responsible for the excavation and proper back filling of trenches required for underground telephone and electrical utilities. Refer to electrical sheets for the utility trench plan and details coordinate, service date with the respective utility companies.
- 10. ANTENNAS INSTALLATION: ALL ANTENNAS AND LINES AND ICE BRIDGE SHALL BE INSTALLED BY ANTENNA CONTRACTOR. DURING THIS WORK THE GENERAL CONTRACTOR SHALL BE LIMITED TO THE WORK WHICH CAN BE PERFORMED IN THE VICINITY OF THE WATER TOWER.

#### Geotechnical Information

- REFER TO THE PROJECT MANUAL FOR ADDITIONAL INFORMATION AND REQUIREMENTS RELATED TO CONSTRUCTION.
- 2. THE OWNER HAS CAUSED A GEOTECHNICAL EXPLORATION TO BE PERFORMED AT THE SITE BY:
- 3. THE CONTRACTOR SHALL NOTIFY THE CLIENT'S GEOTECHNICAL ENGINEER TO COORDINATE HANING A FIELD REPRESENTATIVE ON SITE FOR TESTING AND INSPECTION. COPIES OF THE REPORT ARE ISSUED TO THE CONTRACTOR FOR CONVENIENCE ONLY. THE REPORT IS NOT A PART OF THE CONTRACT DOCUMENTS. NOTHER THE OWNER NOR THE ENGINEER/ACHITECT GUARANTEE THE ACCURACY OF VALIDITY OF THE DATA CONTAINED THEREIN, NOR DO THEY ASSUE ANY RESPONSIBILITY FOR THE CONTRACTOR'S USE OR INTERPRETATION OF THE DATA CONTAINED THEREIN.

- 11. HERBICIDE: AFTER PLACEMENT AND COMPACTING OF FILL AROUND THE PREFABRICATED EQUIPMENT FAD AND BEFORE PLACEMENT OF LIMESTONE SURFACE, A WEED BARRIER SHALL BE PLACED AND HERBICIDE SHALL BE STAYED OVER ALL DISTURBED ARE
- 12. TRASH REMOVAL: THE GENERAL CONTRACTOR SHALL REMOVE ALL TRASH AS GREATED BY HINSELF AND HIS SUBCONTRACTORS AND LAISO BY OTHER CONTRACTORS INCLUDING CABLE RELS, CAMBOARD BOXES, AND PACKAGING. THE SENERAL CONTRACTOR SHALL PROVIDE AND EXPERIENCE AND AND EXPERIENCE AND EXPERIE
- 13. FINAL CLEAN UP: UPON COMPLETION OF ALL WORK BY THE GENERAL CONTRACTOR AND ALL OTHER CONTRACTORS ON THIS PROJECT, THE GENERAL CONTRACTOR SHALL STRIP AND CLEAN THE FLOOR OF THE EQUIPMENT PAD, USING AN INDUSTRIAL STRIPPING MACHINE. THE FINISHED FLOOR SHALL BE CLEAN AND DUST FREE. NO SURFACE FINISHES SHALL BE APPLIED. THE GENERAL CONTRACTOR IS ALSO RESPONSIBLE FOR THE REMOVAL OF ALL EXCESS MATERIALS FROM INSIDE THE EQUIPMENT PAD ALONG WITH SHIPMENT OF NOTED MATERIALS BACK TO THE OWNER.
- 14. GENERAL CONTRACTOR SHALL REQUEST DELIVERY OF VERIZON WRELESS ANTENNAS AND MISCELLANEOUS MATERIALS WHEN READY TO RECEIVE AND INVENTORY. ANY SHORTAGES MUST BE REPORTED TO THE VERIZON WRIELESS PROJECT MANAGER WITHIN 48 HOURS OF DELIVERY. REQUEST FOR FINAL CLEAN UP WILL BE AT THE DIRECTION OF THE VERIZON WRIELESS PROJECT MANAGER.
- 15. THE GENERAL CONTRACTOR SHALL PROVIDE AND MAINTAIN A PORTABLE TOILET ON SITE DURING THE DURATION OF THE CONSTRUCTION PROJECT.
- 16. INDIANA PROTECTION SERVICE: CONTACT IUPS (800) 382-5544 IN INDIANA OR (800) 428-5200 OUTSIDE INDIANA AT LEAST 48 HOURS PRIOR TO DIGGING.
- 17. THE GENERAL CONTRACTOR SHALL NOTIFY THE PROJECT ADMINISTRATOR 48 HOURS PRIOR TO POURING CONCRETE FOR EQUIPMENT PAD FOUNDATION.
- 18. THE CONTRACTOR WILL UPON BECOMING AWARE OF SUBSURFACE OR LATENT PHYSICAL CONDITIONS DIFFERING FROM THOSE DISCLOSED BY THE ORIGINAL SOIL INVESTIGATION WORK, PROMPLTY NOTIFY THE OWNER VERRALLY TO PERMIT VERIFICATION OF THE CONTROL THE OWNER VERBALLY TO PERMIT VERIFICATION OF THE CONTRACTOR FOR ANY CONDITIONS. NO CLAIM BY THE CONTRACTOR FOR ANY CONDITIONS DIFFERING FROM THOSE ANTICIPATED IN THE PLANS AND SPECIFICATIONS AND DISCLOSED BY THE STUDIES WILL BE ALLOWED LINLESS THE CONTRACTOR HAS SO NOTIFIED THE OWNER, VERBALLY AND IN WRITING, AS REQUIRED ABOVE, OF SUCH DIFFERING SUBSURFACE CONDITIONS.
- 19. BEFORE AND DURING CONSTRUCTION, THE CONTRACTOR SHALL PROVIDE ADEQUATE EROSION CONTROL AS NECESSARY IN THE FORM OF SILT EROCES FOR THE SITE AND BALES AROUND ANY EXISTING MANHOLES, INLETS, OR CATCHBASINS (MHEN PRESENT) SUSCEPTIBLE TO EROSION. EROSION CONTROL MESSURES SHALL BE PERFORDICALLY INSPECTED TO ENSURE PROPER FORCIES FONCTION.
- 20. CONTRACTOR IS RESPONSIBLE FOR ANY DAMAGE TO EXISTING PAYED, CONCRETE, OR GRAVEL PARKING AREAS AND DRIVES. CONTRACTORS SHALL PHOTOGRAPH AND VIDEOTAPE EXISTING PARKING AREAS AND DRIVES PRIOR TO CONSTRUCTION, ANY DAMAGE CAUSED DURING CONSTRUCTION, ANY DAMAGE CAUSED DURING CONSTRUCTION SHALL BE REPLACED TO EXISTING OR BETTER CONDITION AT NO ADDITIONAL COST.
- 21. GRADE ALL AREAS DISTURBED DURING CONSTRUCTION TO MATCH EXISTING SURROUNDINGS AFTER WORK IS COMPLETE OR AS WEATHER PERMITS WITH APPROVAL FROM THE PROPERTY

SOME NOTES MAY NOT APPLY

| XTILE PARAMETERS                           |  |
|--|--|
| MINIMUM VALUE (a)                          | TEST METHOD  |
| 200 LBS.<br>90 LBS.<br>400 LBS.<br>75 LBS. | ASTM D-4632<br>ASTM D-4833<br>ASTM D-3786<br>ASTM D-4533 |
|  | MINIMUM VALUE (a)  200 LBS. 90 LBS. 400 LBS.             |

NOTES:

THE FABRIC SHOULD BE PLACED IN ACCORDANCE WITH THE MANUFACTURERS RECOMMENDATIONS. INTERSECTIONS OF SHEETS MUST BE SEWN OR SUFFICIENTLY OVERLAPPED (AT LEAST 24 INCHES) OR AS SPECIFIED BY THE MANUFACTURER). THE GEOTEXTILE SHEETS SHOULD ALSO BE PLACED TAUT TO REDUCE WINNILES OR FOLIOS. CARE MUST BE EXERCISED TO PREVENT PHYSICAL DAMAGE OF THE GEOTEXTILE PRIOR TO, DURING, AND AFTER INSTALLATION. UTILITIES SHOULD BE INSTALLED BEFORE PLACING THE GEOTEXTILE FABRIC.





PRELIMINARY
PRELIMINARY
CONSTRUCTION

| RELEASE  |                       |
|----------|-----------------------|
| DATE     |                       |
| 08-11-22 | PRELIMINARY SITE PLAN |
| 09-22-22 | PRELIMINARY SITE PLAN |
| 11-09-22 | LEASE EXHIBIT         |
| 12-09-22 | LEASE EXHIBIT         |
| 12-29-22 | LEASE EXHIBIT         |
| 01-30-22 | 90% CDs               |
|          |                       |
|          |                       |
|          |                       |
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DRAWN BY: J.

SITE NAME:

FULL RELO SMITH & MAIN CELL SITE

SITE ADDRESS:

IL-64 ST CHARLES, IL 60174

SHEET TITLE:

GENERAL CONSTRUCTION NOTES

A&E PROJECT NO.:

SHEET NO.:

GN-1









| RELEASE  |  |
|----------|--|
| DATE     |  |
|          | PRELIMINARY SITE PLAN  |
|          | PRELIMINARY SITE PLAN  |
|          | LEASE EXHIBIT  |
| 12-09-22 | LEASE EXHIBIT  |
|          | LEASE EXHIBIT  |
| 01-30-22 | 90% CDs  |
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DRAWN BY: CHECKED BY:

SITE NAME:

FULL RELO SMITH & MAIN CELL SITE

SITE ADDRESS:

IL-64 ST CHARLES, IL 60174

SHEET TITLE:

SITE LOCATION PLAN

A&E PROJECT NO.:

SHEET NO.:

C-1











| RELEASE  |                       |
|----------|-----------------------|
| DATE     |                       |
| 08-11-22 | PRELIMINARY SITE PLAN |
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| 11-09-22 | LEASE EXHIBIT         |
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CHECKED BY:

SITE NAME:

FULL RELO SMITH & MAIN CELL SITE

SITE ADDRESS:

IL-64 ST CHARLES, IL 60174

SHEET TITLE:

SITE LOCATION PLAN


A&E PROJECT NO.:

SHEET NO.:

C-1.1






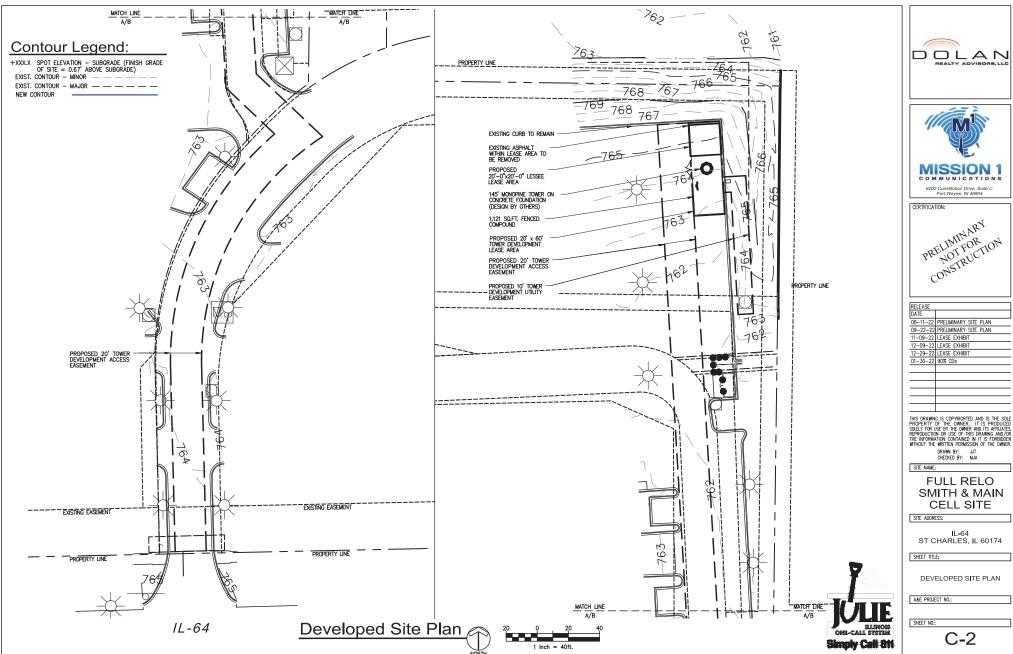






| RELEASE  |                       |
|----------|-----------------------|
| DATE     |                       |
| 08-11-22 | PRELIMINARY SITE PLAN |
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| RELEASE  |                       |
|----------|-----------------------|
| DATE     |                       |
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|          | PRELIMINARY SITE PLAN |
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DRAWN BY: J.

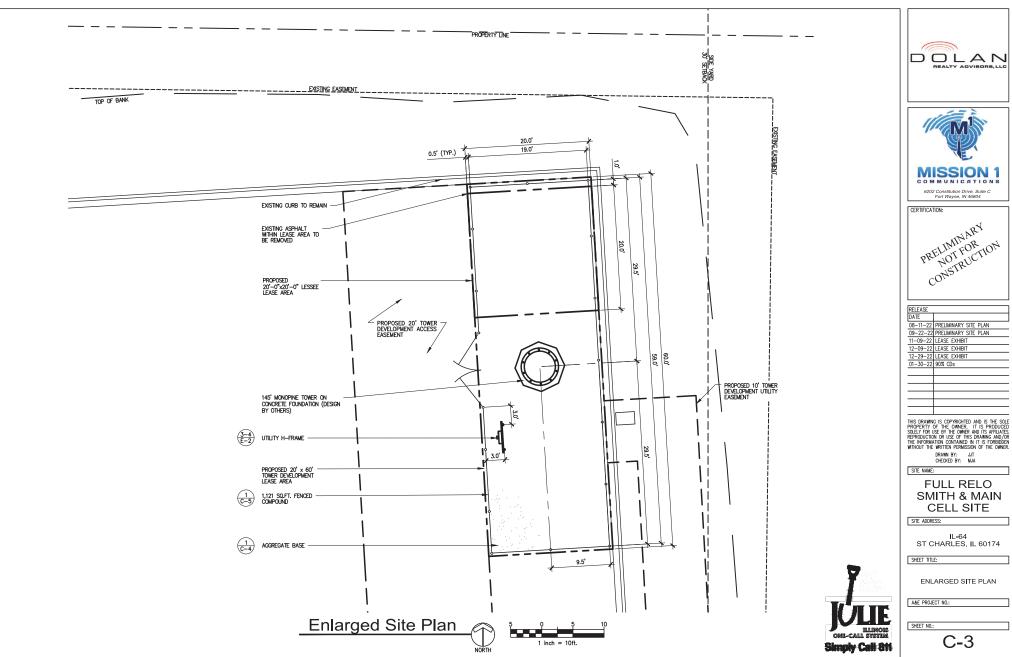SITE NAME:

FULL RELO SMITH & MAIN CELL SITE

SITE ADDRESS:

IL-64 ST CHARLES, IL 60174

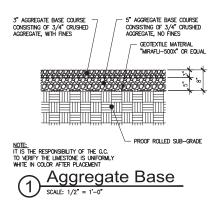
SHEET TITLE:

SITE CIVIL DETAILS

A&E PROJECT NO.:

SHEET NO.:


C-4

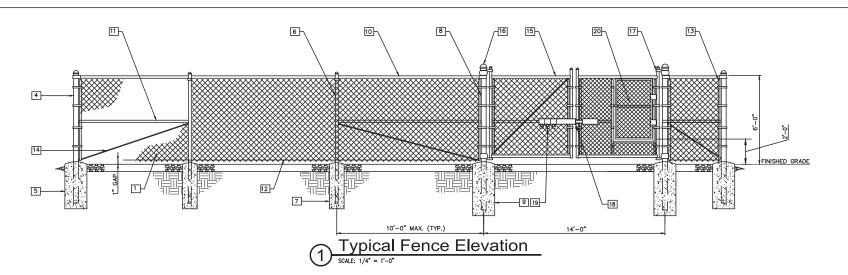

#### Keynote Legend

- 1 FABRIC: 9 GAUGE, 2" BLACK VINYL MESH, ASTM A392 (SEE FENCE SECTION FOR HEIGHT).
- 2 NOT USED 3 NOT USED
- 4 END AND CORNER POSTS: 3"Ø PIPE SCH. 40 (GALV.) ASTM F1083
- 5 CONCRETE FOUNDATION: 36"x12"ø (3000 PSI)
  6 LINE POSTS: 2"ø PIPE SCH. 40 (GALV.) ASTM F1083
- 7 CONCRETE FOUNDATION: 36"x10"ø (3000 PSI)
- B GATE POSTS: 4"ø PIPE SCH. 40 (GALV.) ASTM F1083
- 9 CONCRETE FOUNDATION: 48"x12"ø (3000 PSI)
  10 TOP RAIL & BRACE RAIL: 1-1/2"ø PIPE SCH. 40 (GALV.) ASTM F1083
- 11 MIDDLE RAILS: 1-1/2"ø PIPE SCH. 40 (GALV.) ASTM F1083
- 12 BOTTOM TENSION WIRE: 0.177" METALLIC-COATED STEEL (GALV.), MARCELLED, ASTM A824
- 13 TENSION BARS: 3/16"x3/4", FULL HEIGHT OF FABRIC, FINISH TO MATCH FENCE FRAMEWORK.
- 14 TENSION ROD: 3/8"Ø WITH ADJ. TIGHTENER, FINISH TO MATCH FENCE FRAMEWORK.
- 15 GATE FRAME: 2"Ø SCH. 40 (GALV.) ASTM F1083
  16 POST CAPS: PER POST DIAMETER.
- 17 GATE HINGES: NON-LIFT-OFF TYPE, OFFSET TO PERMIT 180 DEGREE SWING.
- 18 STYMIELOCK SYSTEM
- 19 MARINE-GRADE PROGRAMMABLE FOUR DIGIT PADLOCK (SESAME BRAND OR APPROVED EQUAL)
- 20 4' WIDE SNOW GATE WITH DOUBLE SWING GATE FRAME

- 1. REFER TO PROJECT SPECIFICATIONS FOR INFORMATION NOT SHOWN IN THE DRAWING.
- FENCE FABRIC SHALL CONFORM TO CHAIN LINK FENCE MANUFACTURERS INSTITUTE (CLFMI) PRODUCT MANUAL.
- 3. INSTALL FENCE IN COMPLIANCE WITH ASTM F 567.
- 4. INSTALL SWING GATES IN COMPLIANCE WITH ASTM F 900.
- DO NOT BEGIN INSTALLATION AND ERECTION BEFORE FINAL GRADING IS COMPLETED, UNLESS OTHERWISE PERMITTED. INSTALL FENCING ON BOUNDARY LINES INSIDE OF PROPERTY LINE ESTABLISHED BY SURVEY.
- 6. DRILL OR HAND-EXCAVITE (USING POST HOLE DIGGER) HOLES FOR POSTS TO DIAMETERS AND SPACINGS INDICATED, IN FIRM, UNDISTURBED OR COMPACTED SOIL IF NOT INDICATED ON DRAWINGS, EXCAVATE HOLES FOR EACH POST TO MINIMUM DIAMETER RECOMMENDED BY FENCE MANUFACTURER, BUT NOT LESS THAN (4) TIMES LARGEST GROSS-SECTION OF POST.
- 7. REMOVE POST HOLE SPOILS FROM SITE. DO NOT SET SPOILS ON AGGREGATE WITHOUT ADEQUATE PROTECTION.
- 8. PROTECT PORTION OF POSTS ABOVE GROUND FROM CONCRETE SPLATTER. PLACE CONCRETE AROUND POSTS AND VIBRAIT OR TAMP FOR CONSOLIDATION. CHECK EACH POST FOR WEITRICAL AND TOP ALLONMENT AND HOLD IN POSTION DURING PLACEMENT AND HISINIHING OFFENTIONS, UNLESS OTHERWISE SHOWN, EXTEND CONCRETE FOOTING 1 INCH ABOVE GRADE AND TROWEL TO A CROWN TO SHED WATER.
- 9. INSTALL BARBED WIRE IN ACCORDANCE WITH MANUFACTURER'S INSTRUCTIONS.
- 10. APPLY FABRIC TO OUTSIDE OF FRAMEWORK

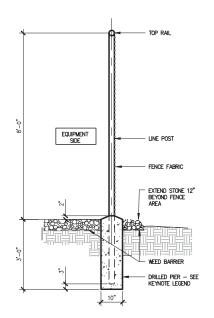

Typical Fence Section





CERTIFICATION: PRELIMIN ARY NULLWILL FOR CONSTRUCTION

08-11-22 PRELIMINARY SITE PLAN 09-22-22 PRELIMINARY SITE PLAN 11-09-22 LEASE EXHIBIT 12-09-22 LEASE EXHIBIT 12-29-22 LEASE EXHIBIT 01-30-22 90% CDs

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DRAWN BY: JJT CHECKED BY: MJA

SITE NAME:

**FULL RELO** SMITH & MAIN **CELL SITE** 

SITE ADDRESS:

IL-64 ST CHARLES, IL 60174


SHEET TITLE:

TYPICAL FENCE DETAILS

A&E PROJECT NO.:

SHEET NO.:

C-5

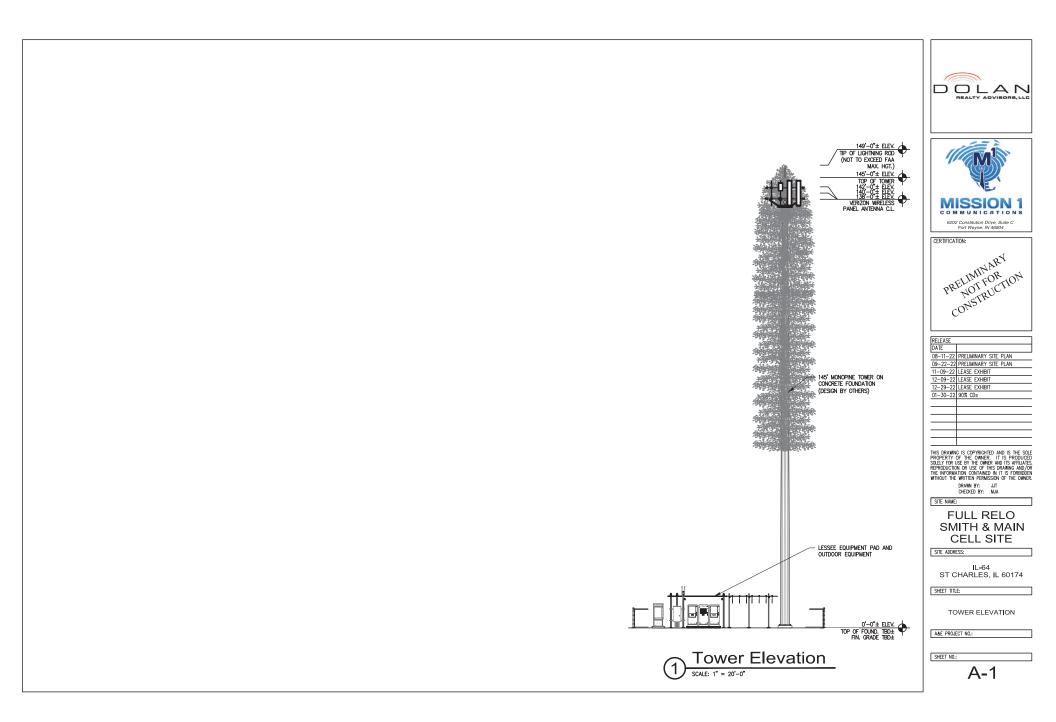

#### General Notes

#### WORK INCLUDES

THESE NOTES AND ACCOMPANYING DRAWINGS COMPLEMENT THE PROVISIONS THESE NOTES AND ACCOMPANTING DRAWNINGS COMPLEMENT THE PROVISIONS AND INSTALLATIONS BY THE ELECTRICAL CONTRACTOR, OF ALL LABOR, MATERIALS AND EQUIPMENT REQUIRED TO INSTALL THE ELECTRICAL WORK COMPLETE IN CONNECTION WITH THIS VERIZON WIRELESS SITE AND SHALL INCLUDE, BUT NOT BE LIMITED TO THE FOLLOWING:

- . THE PROVISIONS, INSTALLATION, AND CONNECTION OF A GROUNDING ELECTRODE SYSTEM COMPLETE WITH A BUILDING AND SECONDARY GROUNDING, CELLULAR TELEPHONE COMMUNICATIONS TOWER AND CONNECTIONS TO THE INCOMING ELECTRICAL DISTRIBUTION EQUIPMENT.
- ELECTRICAL DISTRIBUTION EQUIPMENT.

  2. THE PROVISION AND INSTALLATION OF AN OVERHEAD ELECTRICAL SERVICE OR UNDERGROUND ELECTRICAL SERVICE AND ALL ASSOCIATED WIRE AND CONDUIT AS REQUIRED AND/OR INDICATED ON PLANS.

  3. THE PROVISION, INSTALLATION OF CONDUIT AND CONNECTIONS FOR LOCAL

- 3. THE PROVISION, INSTALLATION OF CONDUIT AND CONNECTIONS FOR LOCAL TELEPHONE SERVICE.

  4. THE FURNISHING AND INSTALLATION OF THE ELECTRICAL SERVICE ENTRANCE CONDUCTORS, CONDUITS, METER SOCKET, AND CONNECTIONS TO THE SERVICE EXPRENDED TO THE SERVICE EXPRENDENT WITHIN THE ENCLOSURE.

  5. TWO INCH. (27) AND THREE INCH. (27) INMETER PLY CONDUITS SCHEDULE 40.

  7. LICANATION, TRENCHICAN CONTRACT OF CONDUITS, CABLE(S), AND EXPRENDED TO THE CONTRACT OF CONDUITS, CABLE(S), AND EXPRENDED TO THE CONTRACT OF CONDUITS, CABLE(S), AND EXTENSIVE CONTRACTIONS. EXTERNAL GROUNDING SYSTEM

#### CODES, PERMITS, AND FEES

- 1. ALL REQUIRED PERMITS, LICENSES, INSPECTIONS AND APPROVALS SHALL BE SECURED AND ALL FEES FOR SAME PAID BY CONTRACTOR.
  2. THE INSTALLATION SHALL COMPLY WITH ALL APPLICABLE CODES: STATE,
- LICAL AND NATIONAL, AND THE DESIGN, PERFORMANCE CHARACTERISTICS AND METHODS OF CONSTRUCTION OF ALL ITEMS AND EQUIPMENT SHALL BE IN ACCORDANCE WITH THE LATEST ISSUE OF THE VARIOUS APPLICABLE STANDARD SPECIFICATIONS OF THE FOLLOWING AUTHORITIES:

NATIONAL ELECTRIC CODE
AMERICAN NATIONAL STANDARDS INSTITUTE
INSTITUTE OF ELECTRICAL AND ELECTRONICS ENGINEERS
AMERICAN SOCIETY FOR TESTING MATERIALS N.F.C. A.N.S.I. A.S.T.M. N.E.M.A. NATIONAL ELECTRICAL MANUFACTURERS ASSOCIATION UNDERWRITERS LABORATORIES, INC. NATIONAL FIRE PROTECTION ASSOCIATION

U.L. N.F.P.A.

#### GROUNDING ELECTRODE SYSTEM

. CONNECTIONS

1. CONNECTIONS
ALL GROUNDING CONNECTIONS SHALL BE MADE BY THE "CADWELD" PROCESS
CONNECTIONS SHALL INCLUDE ALL CABLE TO CABLE, SPICES, ETC. ALL CABLE
TO GROUND RODS, GROUND RODS SPICES AND LIGHTNING PROTECTION SYSTEM
AS INDICATED. GROUND FOUNDATION ONLY AS INDICATED BY PM. ALL MATERIALS
USED (MOLDS, WELDING, METAL, TOOLS, ETC.) SHALL BE BY "CADWELD" PROCESS
AND INSTALLED PER MANUFACTURERS RECOMMENDATIONS AND PROCEDURES.
GROUND CONDUCTOR SHALL HAVE A MINIMUM 24" BENDRING RADIUS.
2. ALL CADWELD CONNECTIONS ON GALVANIZED SURFACES SHALL BE CLEANED
HYDROUGHLY AND COLORED TO MATCH SURFACE WITH (2) TWO COATS OF
HYDROUGHLY AND COLORED TO MATCH SURFACE WITH (2) TWO COATS OF
MILLIABET STORY AND COLORED TO MATCH SIGNED (CO. EQUAL) OR SHERMIN—
MILLIABET STORY AND COLORED TO MATCH SIGNED (CO. EQUAL) OR SHERMIN—
MILLIABET STORY AND COLORED TO MATCH SIGNED (CO. EQUAL) OR SHERMIN—
MILLIABET STORY AND EXCLORED TO MATCH SIGNED (CO. EQUAL) OR SHERMIN—
MILLIABET STORY AND COLORED TO MATCH SIGNED (CO. EQUAL) OR SHERMIN—
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MILLIABET STORY AND COLORED TO MATCH SIGNED TO MATCH

- 3. ALL ELECTRICAL & MECHANICAL GROUND CONNECTIONS SHALL HAVE ANTI-OXIDANT COMPOUND APPLIED TO CONNECTION

FENCE\_GABLE:
GROUND FENCE POSTS WITHIN 6 FEET OF ENCLOSURE AND 25 FEET OF TOWER AS INDICATED ON DRAWNIGS. GROUND EACH GATE POST AND CORNER POST. GROUND CONNECTIONS TO FENCE POSTS SHALL BE MADE BY THE "CADWELD" PROCESS AND INSTALLED PER MANUFACTURER'S RECOMMENDATIONS AND PROCEDURES. ALL OTHER CONNECTIONS FOR THE GROUND GRID SYSTEM SHALL BE MADE BY THE "CADWELD" PROCESS, AND INSTALLED PER MANUFACTURER'S RECOMMENDATIONS AND PROCEDURES.

5. UTILITY COMPANY COORDINATION:

ELECTRICAL CONTRACTOR SHALL CONFIRM THAT ALL WORK IS IN ACCORDANCE WITH THE RULES OF THE LOCAL UTILITY COMPANY BEFORE SUBMITTING THE BID, THE CONTRACTOR SHALL CHECK WITH THE UTILITY COMPANIES SUPPLYING SERVICE TO THIS PROJECT AND SHALL DETERMINE FROM THEM ALL EQUIPMENT AND CHARGES WHICH THEY WILL REQUIRE AND SHALL INCLUDE THE COST IN

GROUND TESTS SHALL BE PERFORMED AS REQUIRED BY VERIZON STANDARD PROCEDURES. GROUND GRID RESISTANCE SHALL NOT EXCEED 5 OHMS.

OLLOWS:

1. ONE (1) COPY TO OWNER REPRESENTATIVE
2. ONE (1) COPY TO ENGINEER
3. ONE (1) COPY TO KEEP INSIDE EQUIPMENT ENCLOSURE

#### RACEWAYS AND WIRING

- RACEWAYS AND WIRING

  1. WEINIG OF EVERY KIND MUST BE INSTALLED IN CONDUIT, UNLESS NOTED

  OTHERWISE, OR AS APPROVED BY THE ENGINEER.

  2. UNLESS OTHERWISE SPECIFIED, ALL WIRING SHALL BE COPPER (CU) TYPE

  THIWN, SIZED IN ACCORDANCE WITH THE NATIONAL ELECTRICAL CODE.

  3. RACEWAYS SHALL BE GALVANIZED STEEL SIZED IN ACCORDANCE WITH THE

  NATIONAL ELECTRICAL CODE, UNLESS OTHERWISE NOTED. ALL RACEWAYS

  SHALL BE APPROVED FOR THE INSTALLATION.

  4. PULL OR JUNCTION BOXES SHALL BE PROVIDED AS REQUIRED TO FACILITATE

  INSTALLATION OF RACEWAYS AND WIRING. PROVIDE JUNCTION AND PULLBOXES

  FOR CONDUIT RUINS WITH MORE THAN (360) DEGREES OF BENDS.

  5. PROVIDE A COMPLETE RACEWAY AND WIRING INSTALLATION, PERMANENTLY AND

  EFFECTIVELY GROUNDED IN ACCORDANCE WITH ARTICLE 250 OF THE


  NATIONAL ELECTRICAL CODE AND LOCAL CODES.
- NATIONAL ELECTRICAL CODE AND LOCAL CODES.
- ELECTRICAL PANELBOARD SHALL BE FURNISHED AND INSTALLED BY OTHERS.
   ELECTRICAL CONTRACTOR SHALL FIELD VERIFY EXACT LOCATION.
   ALL STEL CONDUIT SHALL BE BONDED AT BOTH ENDS WITH GROUNDING BUSHING.

#### GENERAL NOTES:

SEE DETAILS AND SCHEDULES ON DRAWINGS AND SPECIFICATIONS FOR MEANING OF SEE DETAILS AND SCHEDULES ON DRAWINGS AND SPECIFICATIONS FOR MEANING OF ABBREVATIONS AND ADDITIONAL REQUIREMENTS AND INFORMATION. CHECK ARCHITECTURAL, STRUCTURAL AND OTHER MECHANICAL AND ELECTRICAL DRAWINGS FOR SCALE, SPACE LIMITATIONS, COORDINATION, AND ADDITIONAL INFORMATION, ETC. REPORT ANY DISCREPANCIES, CONFLICTS, ETC. TO ENGINEER BEFORE SUBMITTING BID. ALL EQUIPMENT FURNISHED BY OTHERS (FOR) SHALL BE PROVIDED WITH PROPER MOTOR STARTERS, DISCONNECTS, CONTROLS, ETC. BY THE ELECTRICAL CONTRACTOR SHALL WILLESS SPECIFICALLY NOTICE OTHERWISE. UNICES SPECIFICALT NOTED UTHERWISE. THE ELECTRICAL CONTRACTOR SHALL INSTALL AND COMPLETELY MER ELL ASSOCIATE EQUIPMENT IN ACCORDANCE WITH MANUFACTURER'S WIRE DIAGRAMS AND AS REQUIRED FOR A COMPLETE OPERATING INSTALLATION. ELECTRICAL CONTRACTOR SHALL VERIFY AND COORDINATE ELECTRICAL CHARACTERISTICS AND REQUIREMENTS OF (FBO) EQUIPMENT PRIOR TO ROUGH-IN OF CONDUIT AND WRINING TO AVOID CONFLICTS.

#### COORDINATION WITH UTILITY COMPANY

COORDINATION WITH UTILITY COMPANY
THE ELECTRICAL CONTRACTOR SHALL COORDINATE COMPLETE ELECTRICAL SERVICE
WITH LOCAL UTILITY COMPANY FOR A COMPLETE OPERATIONS SYSTEM, INCLUDING
TRANSFORMER CONNECTIONS, CONCRETE TRANSFORMER PADS, IF REQUIRED, METER
SOCKETS, PRIMARY CABLE RACEMAY REQUIREMENTS, SECONDARY SERVICE, ETC.
PRIOR TO SUBUTITION BIO INCLUDE ALL LABOR AND MATERIALS.
THE ELECTRICAL CONTRACTOR SHALL INCLUDE IN THE BIO ANY OPTIONAL OR EXCESS
FACILITY CHARGES ASSOCIATED WITH PROVIDING ELECTRICAL SERVICE FROM LOCAL
UTILITY COMPANY, VERIFY BEFORE BIDDING TO INCLUDE ALL COSTS.
THE ELECTRICAL CONTRACTOR SHALL VERIFY THE AVAILABLE FAULT CURRENT WITH
THE LOCAL UTILITY COMPANY PRIOR TO SUBMITTING BID. ADJUST ALC, RATINGS OF
ALL OVERCURERNIP PROTECTION DEVICES IN DISTIBILITION EQUIPMENT AS REQUIRED
TO COORDINATE WITH AVAILABLE FAULT CURRENT FROM LOCAL UTILITY COMPANY,
ALL GROUNDING RODS PROVIDED BY THE POWER OR TELEPHONE UTILITY COMPANY,
ALL GROUNDING RODS PROVIDED BY THE POWER OR TELEPHONE UTILITY COMPANIES
MUST BE TIED INTO THE MAIN EXTERNAL GROUND RING.

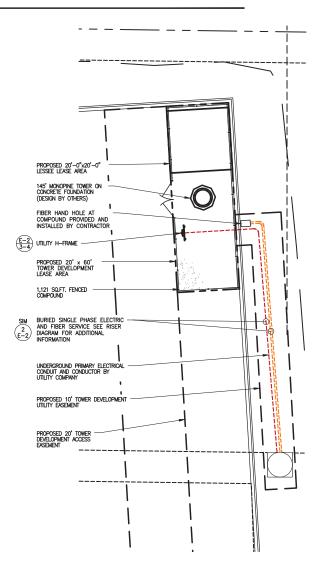





# CERTIFICATION: PRELIMINARY remote FOR CONSTRUCTION

| RELEASE  |                       |
|----------|-----------------------|
| DATE     |                       |
| 08-11-22 | PRELIMINARY SITE PLAN |
| 09-22-22 | PRELIMINARY SITE PLAN |
| 11-09-22 | LEASE EXHIBIT         |
| 12-09-22 | LEASE EXHIBIT         |
| 12-29-22 | LEASE EXHIBIT         |
| 01-30-22 | 90% CDs               |
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SITE NAME:

## **FULL RELO** SMITH & MAIN **CELL SITE**

SITE ADDRESS:

IL-64 ST CHARLES, IL 60174

SHEET TITLE:

UTILITY PLAN AND GENERAL NOTES

A&E PROJECT NO.:

SHEET NO.:

Simply Call 811

F-1

# Utility Color Legend

CONTACT). PRIOR TO CONSTRUCTION.

CONTACT DESIGNER FOR UPDATE.

FIBER COORDINATION IS NOT


COMPLETE (PENDING FIBER



**Utility Plan** 





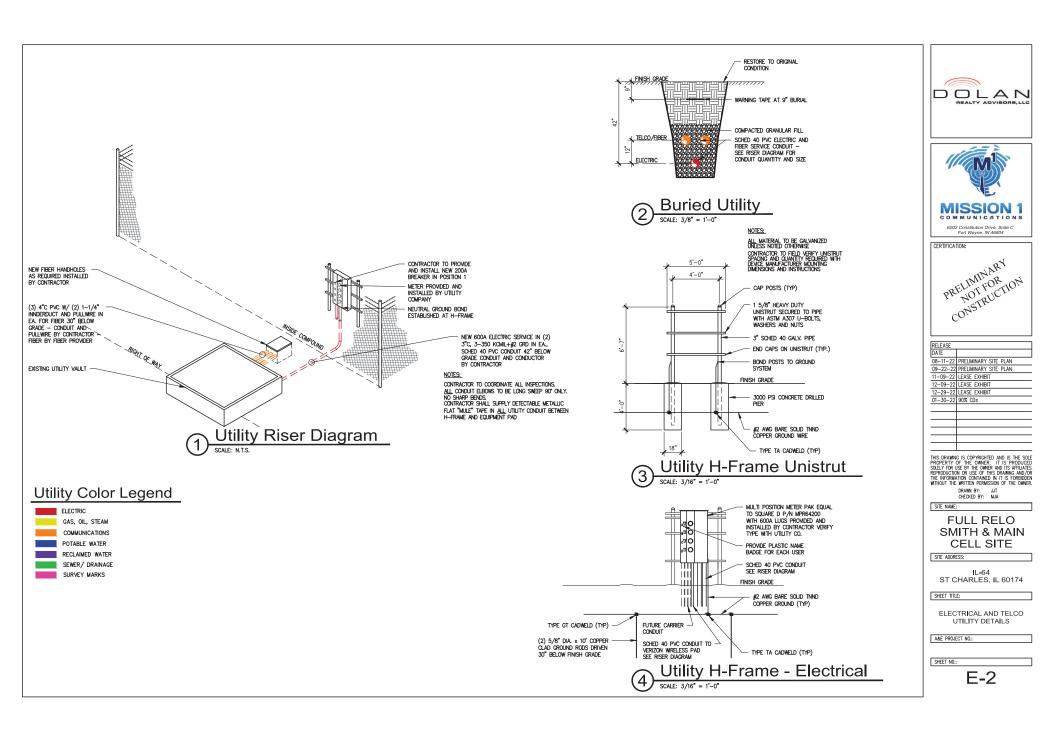



- #2 AWG TINNED SOLID BARE COPPER CONDUCTOR 42" BELOW GRADE (TYPICAL) MINIMUM 24" BENDING RADIUS
- 2. DISCONNECT AND ELECTRIC SERVICE GROUND TO GROUND ROD
- 3. 5/8" X 10' COPPER CLAD GROUND ROD
- 4. GROUND CHAIN LINK FENCE (TYPICAL) EXOTHERMIC CONNECTION (TYPE VS) GROUND FENCE POSTS WITHIN 6 FEET OF PAD AND 25 FEET OF TOWER. (SEE DETAIL, SHEET E-4)
- 5. PROPOSED TOWER GROUND RING (V.I.F.)
- 6. COPPER CLAD GROUND ROD WITH INSPECTION WELL TOP OF GROUND ROD MAX 24" BURY. SEE DETAIL SHEET E-4.
- 7. GATE JUMPERS SEE DETAIL ON SHEET E-4


Grounding Legend

GROUND SYSTEM TEST WELL (HAND HOLE)

GROUND ROD

→ FENCE LINE

**★** CADWELD CONNECTION

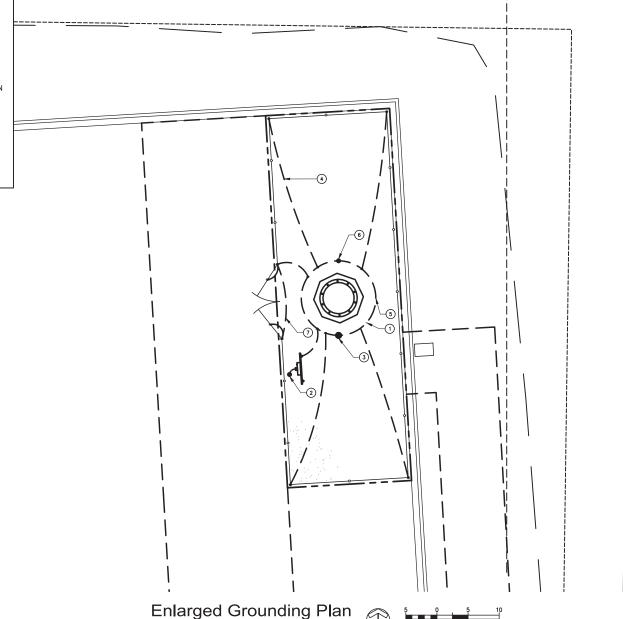





PRELIMINARY
PRELIMINARY
CONSTRUCTION

| RELEASE  |                       |
|----------|-----------------------|
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| 08-11-22 | PRELIMINARY SITE PLAN |
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CHECKED BY: MJ

SITE NAME:

FULL RELO SMITH & MAIN CELL SITE

SITE ADDRESS:

IL-64 ST CHARLES, IL 60174


SHEET TITLE:

ENLARGED GROUNDING PLAN


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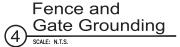
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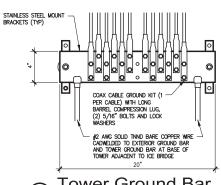
E-3






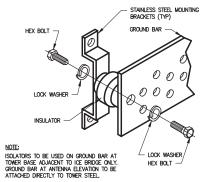



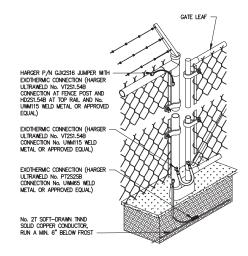



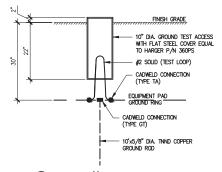

Grounding
Inspection Test Well

SOALE: 1/2' = 1'-0'



Type VN

HORIZONTAL CABLE TAP TO
VERTICAL STEEL SURFACE OR
THE SIDE OF HORIZONTAL PIPE



Type W
THROUGH VERTICAL CABLE TO VERTICAL STEEL SURFACE OR TO THE SIDE OF EITHER HORIZONTAL OR VERTICAL PIPE



Type VS

CABLE TAP DOWN AT 45' TO VERTICAL STEEL SURFACE OR SIDE OF HORIZONTAL OR MEDITAL OR ARE TO THE PER ALL CABLE



Type GY

THROUGH CABLE TO SIDE OF GROUND ROD



THROUGH AND TAP CABLES TO GROUND ROD



Type GT
THROUGH CABLE TO TOP OF GROUND ROD



CROSS OF HORIZONTAL CABLES, LAPPED AND NOT



Type GR


CABLE TAP TO TOP OF GROUND ROD



HORIZONTAL CABLE TAP TO HORIZONTAL STEEL SURFACE OR PIPE. CABLE OFF SURFACE



TEE OF HORIZONTAL RUN AND TAP CABLES

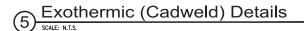





PRELIMINARY
PRELIMINARY
CONSTRUCTION

| RELEASE  |                       |
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| DATE     |                       |
|          | PRELIMINARY SITE PLAN |
| 09-22-22 | PRELIMINARY SITE PLAN |
| 11-09-22 | LEASE EXHIBIT         |
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DRAWN BY: JJI CHECKED RY: M.I.

SITE NAME:

FULL RELO SMITH & MAIN CELL SITE

SITE ADDRESS:

IL-64 ST CHARLES, IL 60174

SHEET TITLE:

GROUNDING DETAILS

A&E PROJECT NO.:

SHEET NO.:

E-4

CELLCO PARTNERSHIP d/b/a

# verizon

# **FULL RELO SMITH & MAIN CELL SITE**

LOCATION NO. 711056 PROJECT NO. 20222341126

IL-64 ST CHARLES. IL 60174 **DUPAGE COUNTY** 

WITH COMMUNICATIONS EQUIPMENT

### DRAWING INDEX

#### VERIZON WIRELESS CONSTRUCTION SECTION

VZW C-1 DEVELOPED SITE PLAN VZW C-2 ENLARGED SITE PLAN

VZW C-3 4'-0"x11'-0" EQUIPMENT PAD PLAN VZW EP-1

\/Z\/\/ A=1 TOWER ELEVATION AND ANTENNA INFORMATION ANTENNA EQUIPMENT INFORMATION

ANTENNA EQUIPMENT INFORMATION VZW A-4

VZW E-2 ELECTRIC AND TELCO UTILITY DETAILS ENLARGED GROUNDING PLAN

SPECIFICATIONS

145' MONOPINE TOWER

PROJECT INFORMATION, LOCATION MAPS, AND

ICE BRIDGE, AND FOUNDATION DETAILS

VZW EP-2 EQUIPMENT PAD - ELEV VIEW VZW EP-3 GENERATOR DETAILS

\/Z\/\/ A=2 ANTENNA EQUIPMENT INFORMATION VZW A-3

VZW E-1 ENLARGED UTILITY PLAN

GROUNDING SCHEMATIC VZW E-4 GROUNDING DETAILS

VZW SP-1 VZW SP-2 SPECIFICATIONS

APPLICANT UTILITIES - ELECTRIC

VERIZON WIRELESS DAVID HENDRIXSON 1701 GOLF ROAD, TOWER 2, SUITE 400 ROLLING MEADOWS, IL 60008 PH: (231) 578-8860 EMAIL: DAVID.HENDRIXSON® VERIZONWIRELESS.COM

SITE ACQUISITION

DOLAN REALTY ADVISORS, LLC DOUG DOLAN 343 S. KIRKWOOD ROAD #5 BOX# 220130 KIRKWOOD, MO 63122 PH: (314) 963-7700 EMAIL: DDOLAN@DOLANREALTYADVISORS.COM

SURVEYOR

SURVETUR
MILLIAMS & WORKS
BILL MCCLURE
549 OTTAWA AVE NW
GRAND RAPIDS, MI 49503
PH: (616) 224-1500
EMAIL:
MCCLURE@WILLIAMS-WORKS.COM

ARCHITECTURAL AND ENGINEERING

MISSION 1 COMMUNICATIONS
MARK ALLEN
6202 CONSTITUTION DRIVE, SUITE C
FORT WAYNE, IN 46804 PH: (260) 436-3922 EMAIL: MALLEN@M1COMM.COM

UTILITIES - FIBER

TBD FIBER PROVIDER NOT SELECTED AT THE TIME OF RELEASE POLICE DEPARTMENT

ST CHARLES POLICE DEPT 1515 W MAIN ST, ST. CHARLES, IL 60174 PH: (630) 377-4435

FIRE DEPARTMENT

ST CHARLES FIRE DEPT 112 N RIVERSIDE AVE, ST. CHARLES, IL 60174 PH: (630) 377-4458

LANDLORD

ST CHARLES VW REAL ESTATE 4050 E MAIN ST, ST. CHARLES, IL 60174 PH: (630) 818-4150

CONSULTANT TEAM

PROJECT DESCRIPTION

INSTALLATION OF PANEL ANTENNA, ASSOCIATED APPLIANCES, COAXIAL CABLE AND MOUNTS ON AN 145' MONOPINE TOWER.

INSTALLATION OF A 4'-0" X 11'-0" UNMANNED EQUIPMENT PAD ON CONCRETE FOUNDATION. INSTALLATION OF GENERAC SD030-1PE-190JT 30KW DIESEL GENERATOR ON EQUIPMENT CONCRETE FOUNDATION. NEW TELEPHONE (FIBER) SERVICE TO SITE AND EQUIPMENT SKID. NO WATER SUPPLY OR SEWAGE TO/FROM THE SITE.


SITE COORDINATES AND ELEVATION

LATITUDE - N41° 55′ 24.08″ LONGITUDE - W88° 15′ 23.01″ GRD ELEV. - ±764′ AMSL

PROJECT DESCRIPTION



DIRECTIONS TO SITE

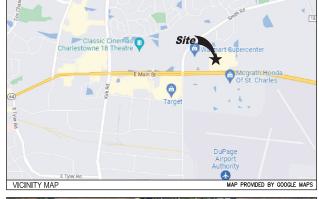



FIBER COORDINATION IS NOT COMPLETE (PENDING FIBER CONTACT). PRIOR TO CONSTRUCTION, CONTACT DESIGNER FOR UPDATE.







PRELIMINARY NOT FOR

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|          | RELEASE               |  |  |
| DATE     |                       |  |  |
| 08-11-22 | PRELIMINARY SITE PLAN |  |  |
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| 11-09-22 | LEASE EXHIBIT         |  |  |
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SITE NAME:

**FULL RELO** SMITH & MAIN **CELL SITE** 

SITE ADDRESS:

ST CHARLES, IL 60174

SHEET TITLE:

PROJECT INFORMATION, LOCATION MAPS AND DRAWING INDEX

A&E PROJECT NO.:

VZW T-1







| 1 |          |                       |  |
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| ı | RELEASE  |                       |  |
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| ı |          | PRELIMINARY SITE PLAN |  |
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| ı |          | LEASE EXHIBIT         |  |
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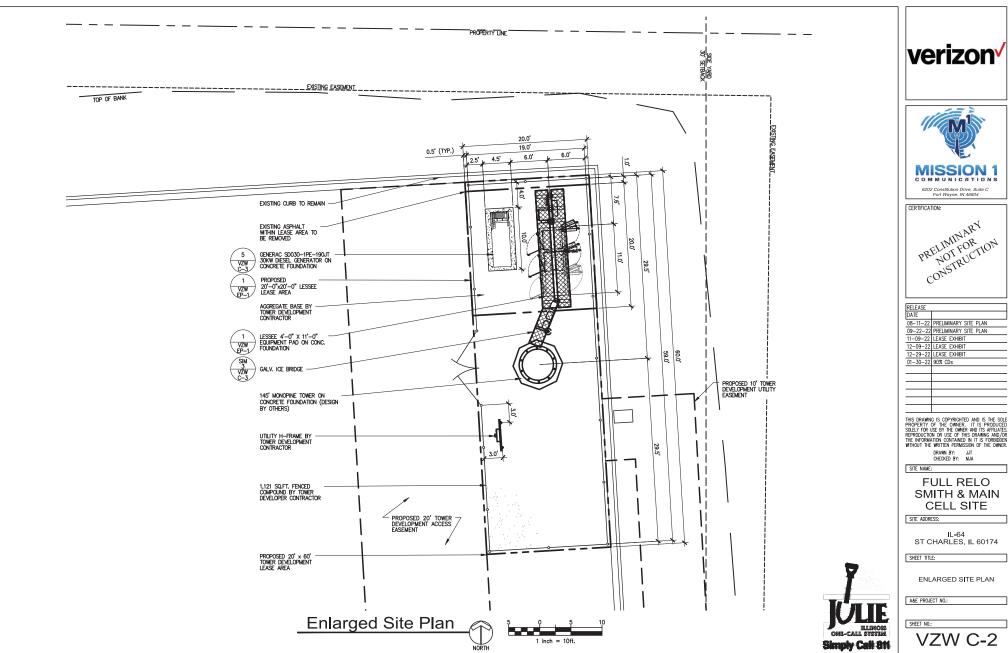
DEVELOPED SITE PLAN

A&E PROJECT NO.:

SHEET NO.:

VZW C-1










PRELIMINARY
CONSTRUCTION


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| DATE     |                       |  |  |
| 08-11-22 | PRELIMINARY SITE PLAN |  |  |
| 09-22-22 | PRELIMINARY SITE PLAN |  |  |
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**FULL RELO** SMITH & MAIN

IL-64 ST CHARLES, IL 60174

VZW C-2



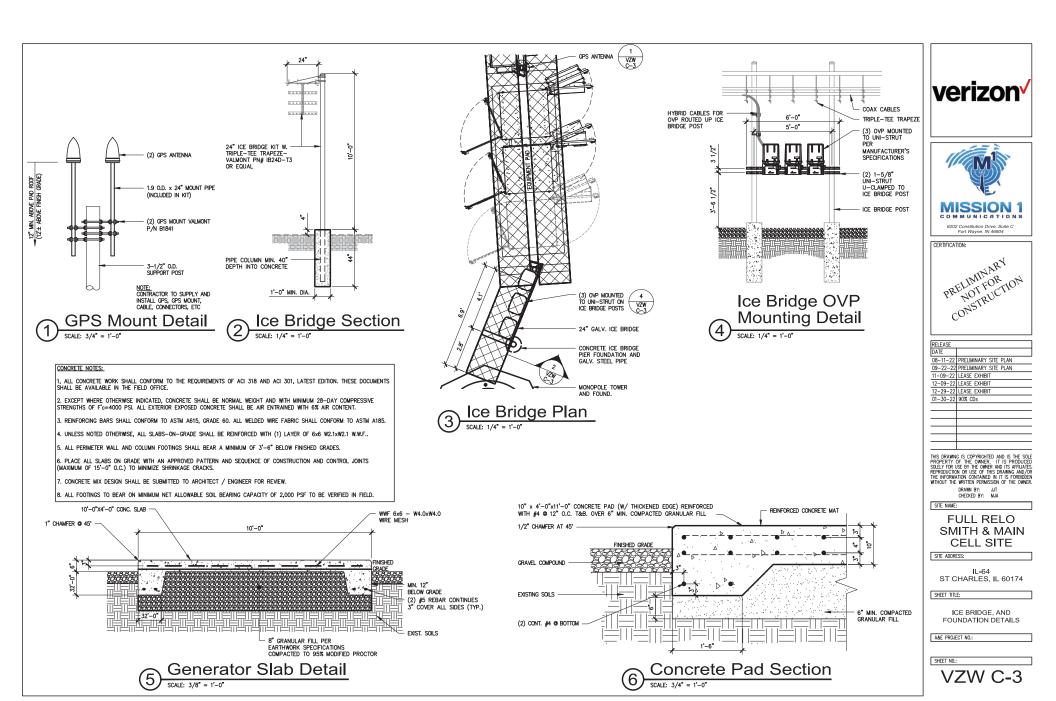

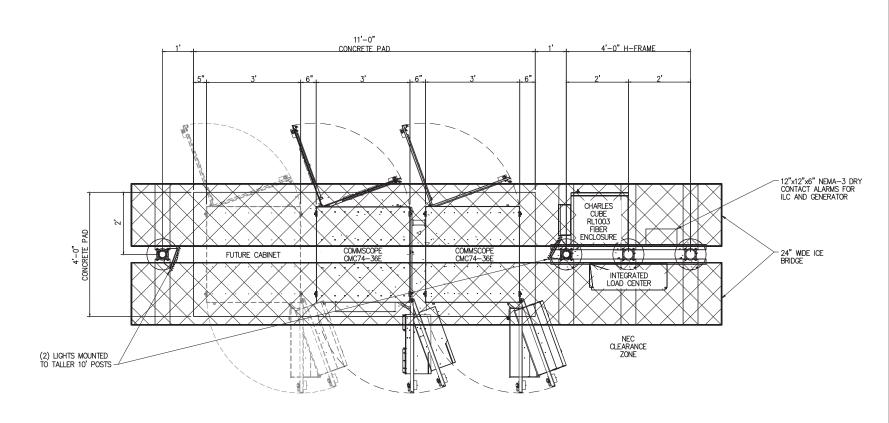Equipment Pad - Layout Plan

SCALE: 1/2" = 1'-0"





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|          | PRELIMINARY SITE PLAN |
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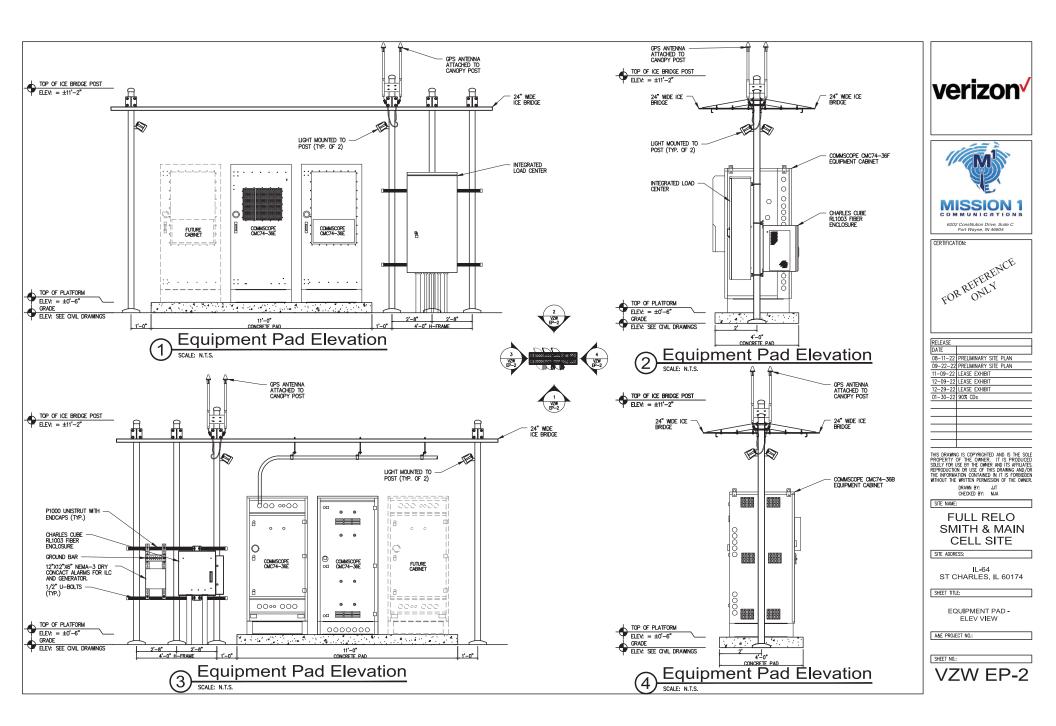
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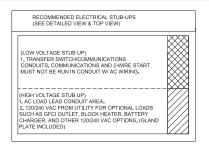
4'-0"x11'-0" EQUIPMENT PAD PLAN

A&E PROJECT NO.:

SHEET N


VZW EP-1





#### NOTES:

- 1. SEE GENERATOR MANUFACTURE'S DRAWINGS FOR PHYSICAL LOCATION OF FUEL LINES, CONTROL AND POWER NITERCONNECTIONS AND OTHER INTERFACES THAT ARE TO CAST INTO THE CONCRETE. THE PREFERRED METHOD IS TO BRING THE CONDUIT THROUGH THE PAD TO THE UNDERSIDE OF THE GENERATOR MINIMEZES ROPECT DAMAGE, PHISH CONNECTIONS WITH FLEXIBLE CONDUIT PER GENERATOR MANUFACTURES SPECS, RIGID CONDUITS SHALL BE SECURED TO THE EXISTING SLAB, THEN BURIED BETWEEN SLAB AND SHELTER.
- 2. -THE GENERATOR SHALL BE LOCATED A MIN 5' AWAY FROM A COMBUSTIBLE WALL.
  -THE GENERATOR SHALL BE LOCATED A MIN OF 3' AWAY FROM A NON-COMBUSTIBLE WALL.

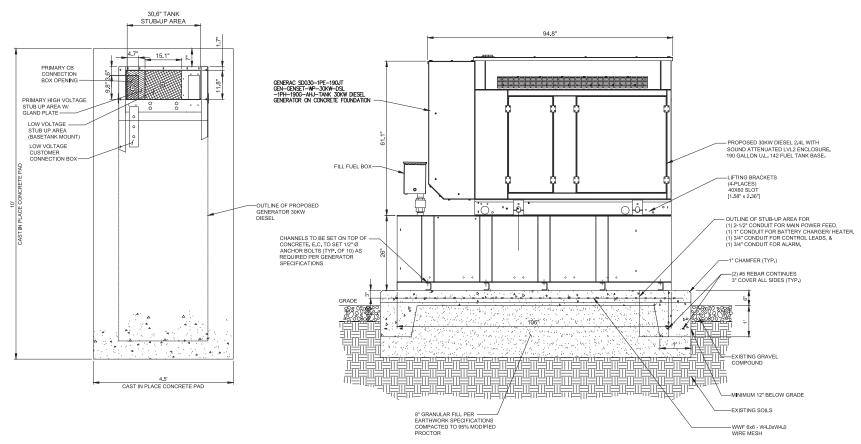

Generator Foundation -Plan View







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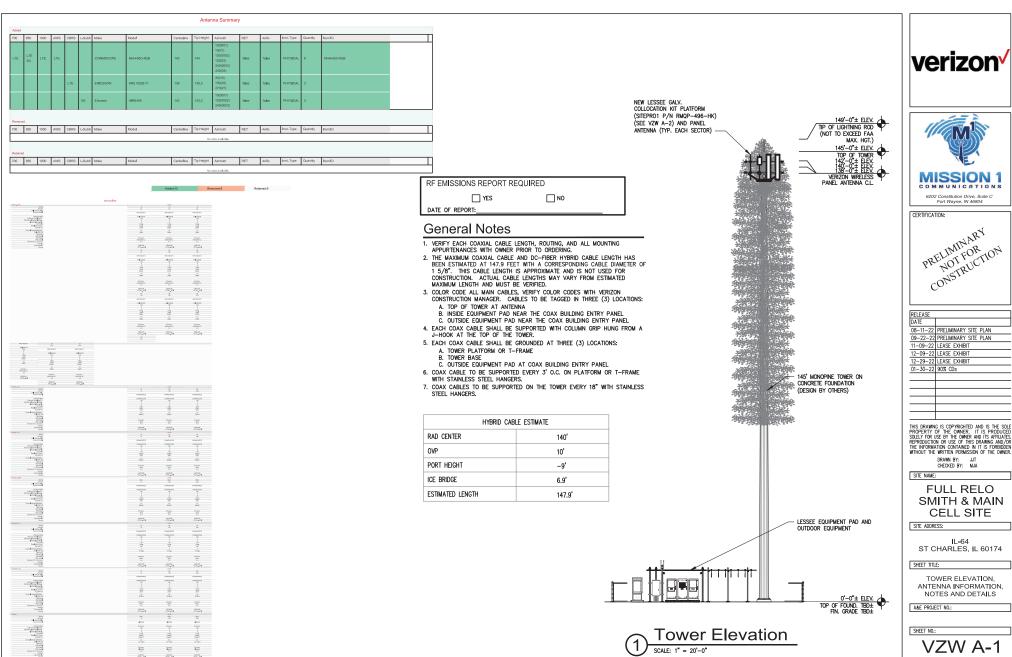
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SHEET TITLE:

GENERATOR DETAILS

A&E PROJECT NO.:

SHEET NO.:








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**FULL RELO** SMITH & MAIN

ANTENNA INFORMATION, NOTES AND DETAILS





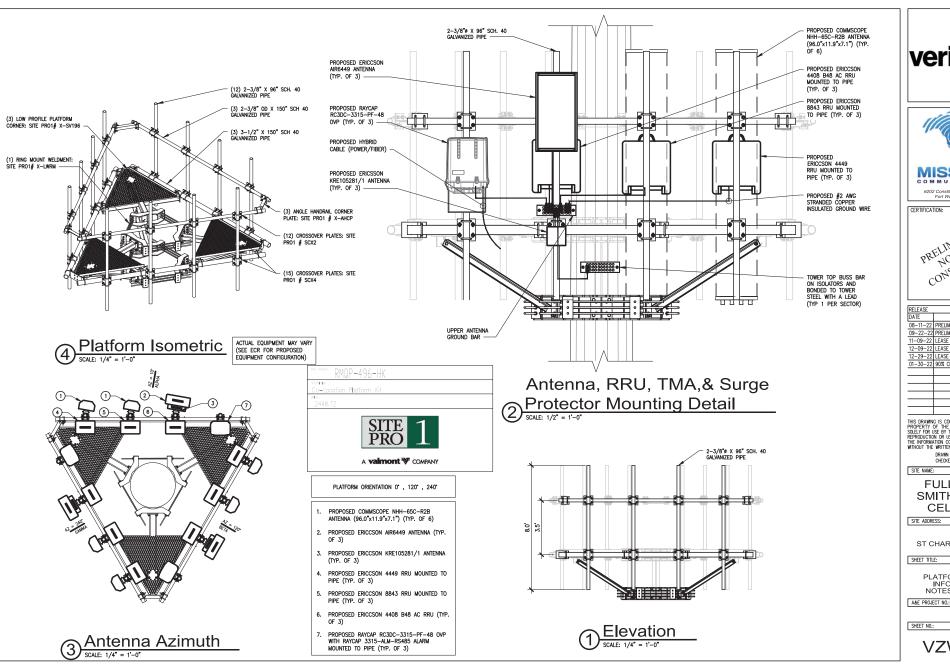



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SHEET TITLE:


PLATFORM MOUNT INFORMATION NOTES & DETAILS

SHEET NO.:

# DC Surge Protection for RRH/Integrated Antenna Radio Head RCMDC-3315-PF-48


Tower / Base / Rooftop / Rooftop Distribution Models



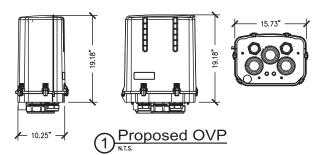


## Radio 8843 & 4449

| <b>Dual Band</b>      | Radio                          | 8843                        | Radio                              | 4449                                     | 8843 444   |
|-----------------------|--------------------------------|-----------------------------|------------------------------------|--|--|
| Band                  | Band2 (1.9GHz)                 | Band66A (2.1GHz)            | Band13 (700MHz)                    | BandS (8S0MHz)                           |  |
| Frequency             | DL:1930~1990MHz                | DL: 2110~2180MHz            | DL:746~756MHz                      | DL:869*894MHz                            |  |
|                       | UL: 1850~1910MHz               | UL:1710*1780MHz             | UL:777~787MHz                      | UL:824~849MHz                            | Dog Bartaga  |
| IBW                   | 60 MHz                         | 70 MHz                      | 10 MHz                             | 25 MHz                                   | Preliminary  |
| OBW                   | 60 MHz                         | 60 MHz                      | 10 MHz                             | 25 MHz                                   |  |
| Carrier Bandwidth     | 5, 10, 15                      | , 20 MHz                    | 10 MHz                             | 5, 10, 15, 20 MHz                        | and the same of th |
| Total # of carriers   | up to 24 per radi              | o over both bands           | up to 24 per radi                  | o over both bands                        | Inning a second  |
| RF Chain              | 4T4R, 2T4R, 2T2R               | (SW configurable)           | 414R, 214R, 212R                   | (SW configurable)                        |  |
| RF Output Power       | 320                            | w                           | 320                                | w  | 6  |
| RX Sensitivity        | Typical: 82/866A:              | -106.1 dBm @18x             | Typical: 813: -105.5:              | 85: -105.7 d8m@1Rx                       |  |
| Modulation            | EVM: 64QAM-5%.                 | 256QAM<3.5% QAM             | EVM: 64QAM-5%.                     | 256QAM:3.5% QAM                          |  |
| Input Power           | 38V-SI                         | 8.5 VDC                     | 38V-S                              | 8.5 VDC                                  |  |
| Power Consumption     | 1373 (estimated) Watt.<br>cond |                             |                                    | @ 100% RF load, typical<br>litions       |  |
| Size HxWhD*           | 28°x1                          | 5"x10"                      | 5"x10"                             |  |  |
| Weight*               | 85                             | lbs                         | 85                                 | bs                                       | the ball the |
| Operating Temperature | -40°C (-40°F) * 55°C (13       | 1°F) (Without solar load)   | -40°C (-40°F) ~ 55°C (13           | 1°F) (Without solar load)                |  |
| Cooling               | Natural c                      | onvection                   | Natural c                          | onvection                                | The state of the s |
| CPRI Cascade          | up to-                         | 4 ports                     | upto                               | 4 ports                                  |  |
| Optic Interface       | 2 CPRI ports : 2.5 G,          | 5 G, 10 G, 10.1 Gbps        | 2 CPRI ports: 2.5 G                | 5 G, 10 G, 10.1 Gbps                     |  |
| RET & TMA Interface   | 1 ALD/RET p                    | ort ASS v2.0                | 1 ALD/RET p                        | ort AISS v2.0                            |  |
| Blas-T                | Supported on 2 RF ports (f     | ist port supports one band, | Supported on 2 RF ports (f         | irst port supports one band,             |  |
|                       | second port suppo              | rts the other band)         | second port suppo                  | rts the other band)                      |  |
| NB-IoT                | supported                      | supported                   | B13: In-band and guard ban<br>Supp | d; 4 carriers per sector , B5 :<br>orted |  |
| Alarm Input           |                                | 2                           |                                    | 2  |  |

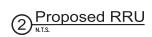

April 2017

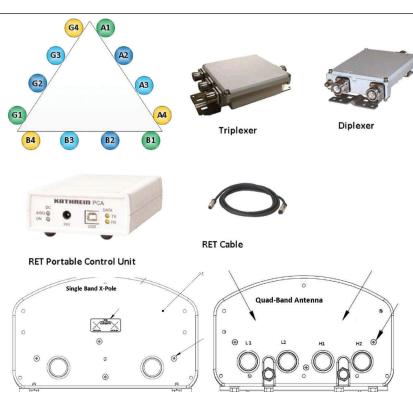

Proposed Components

N.T.S.





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CONSTRUCTION

| DATE     |                       |
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| 09-22-22 | PRELIMINARY SITE PLAN |
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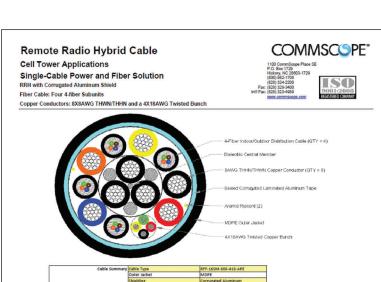
IL-64 ST CHARLES, IL 60174

SHEET TITLE:

ANTENNA EQUIPMENT INFORMATION

A&E PROJECT NO.:

SHEET NO.:



|                       | Water Block                 | Tape                       | 1 |
|-----------------------|-----------------------------|----------------------------|---|
|                       | Ripcord                     | Aramid (QTY = 2)           |   |
|                       | Conductors                  | 8 x 8AWG and 4X18AWG Bunch |   |
|                       | Fiber Cables                | 4 x 4 SM fibers            |   |
|                       | Strength Member             | GRP                        |   |
|                       |                             |                            |   |
| Optical Fiber Details | Fiber type                  | Single Mode G.652.D        |   |
| for Fiber Cable 1     | Fiber Coating Diameter      | 0.9mm Tight Buffer         |   |
|                       | Number of Fiber Subunits    | 4                          | 1 |
|                       | Fiber count (each subunit)  | 4                          |   |
|                       | Fiber Subunit Diameter (mm) | 5.07                       |   |
|                       |                             |                            |   |

| Copper Conductor Detail | ls Number, Size | 8 x 8awg     |                  |
|-------------------------|-----------------|--------------|------------------|
|                         | DC resistance   | 0.628 (2.06) | ohm/kft (ohm/km) |
|                         |                 |              |                  |


| Cable Details | Outer Diameter                 | 1.09 (27.7)           | inch (mm)    |
|---------------|--------------------------------|-----------------------|--------------|
|               | Weight                         | 0.75 (1.12)           | lb/ft (kg/m) |
|               | Minimum Bend Radius - loaded   | 21.9 (555)            | inch (mm)    |
|               | Minimum Bend Radius - unloaded | 10.9 (277)            | inch (mm)    |
|               | Max Tensile Load - short term  | 800 (3560)            | lb (N)       |
|               | Max Tensile Load - long term   | 240 (1070)            | lb (N)       |
|               | Operating Temperature Range    | -40 to +80            | °C           |
|               | Installation Temperature Range | -30 to +70            | °C           |
|               | Storage Temperature Range      | -40 to +80            | °C           |
|               | Crush resistance, FOTP-41      | 22                    | N/mm         |
|               | Impact resistance, FOTP-25     | 20 impacts of 2.94 Nm |              |
|               | Flexing, FOTP-104              | 5 cycles              |              |
|               | Twisting, FOTP-85              | exceeds               |              |

RoHS

Orawings not to scale
Opecifications subject to change
Revision Date: 6/28/12

## Equipment Summary

| Added          |          |     |           |      |     |      |        |                    |                    |                |               |              |          |                      |
|----------------|----------|-----|-----------|------|-----|------|--------|--------------------|--------------------|----------------|---------------|--------------|----------|----------------------|
| Equipment Type | Location | 700 | 850       | 1900 | AWS | CBRS | L-Sub6 | Make               | Model              | Cable Length   | Cable Size    | Install Type | Quantity | Item ID              |
| Hybrid Cable   | Tower    |     |           |      |     |      |        | COMMSCOPET-<br>001 | HFT1206-24SV4-xxxG |                |               | PHYSICAL     | 3        |                      |
| RRU            | Tower    |     |           |      |     | LTE  |        | Ericsson           | 4408 B48 AC        | 1000000        | 1111          | PHYSICAL     | 3        | KRC161746/1          |
| RRU            | Tower    | LTE | LTE<br>5G |      | 1   |      |        | Ericsson           | 4449               |                |               | PHYSICAL     | 3        | KRC161749/1          |
| RRU            | Tower    |     |           | LTE  | LTE |      |        | Ericsson           | 8843               | 1111           | 1000          | PHYSICAL     | 3        | KRC161707/2          |
| RRU            | Tower    | 100 |           | 100  | 100 | 100  | 5G     | Ericsson           | AIR6449            | 1111           |               | PHYSICAL     | 3        |                      |
| Alarm          | Tower    |     | 100       | 100  |     | 100  |        | RAYCAPING-001      | 3315-ALM-RS485     | and the second | 1000          | PHYSICAL     | 3        | 3315-ALM-RS485       |
| OVP Box        | Tower    |     |           |      |     |      |        | RAYCAPINC-001      | RVZDC-3315-PF-48   |                | 1-5/8<br>inch | PHYSICAL     | 3        | RVZDC-3315-PF-<br>48 |
| Removed        |          |     |           |      |     |      |        |                    |                    |                |               |              |          |                      |
| Equipment Type | Location | 700 | 850       | 1900 | AWS | CBRS | L-Sub6 | Make               | Model              | Cable Length   | Cable Size    | Install Type | Quantity | Item ID              |
|                |          |     |           |      |     |      |        |                    | No data ava        | lable.         |               |              |          |                      |
| Retained       |          |     |           |      |     |      |        |                    |                    |                |               |              |          |                      |
| Equipment Type | Location | 700 | 850       | 1900 | AWS | CBRS | L-Sub6 | Make               | Model              | Cable Length   | Cable Size    | Install Type | Quantity | Item ID              |
|                |          |     |           |      |     |      |        |                    |                    |                |               |              |          |                      |

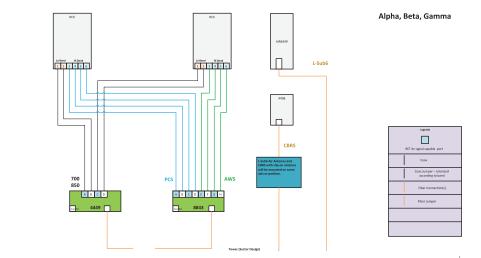

(1) Proposed Configuration







| RELEASE<br>DATE |                       |
|-----------------|-----------------------|
|                 | PRELIMINARY SITE PLAN |
|                 | PRELIMINARY SITE PLAN |
| 11-09-22        | LEASE EXHIBIT         |
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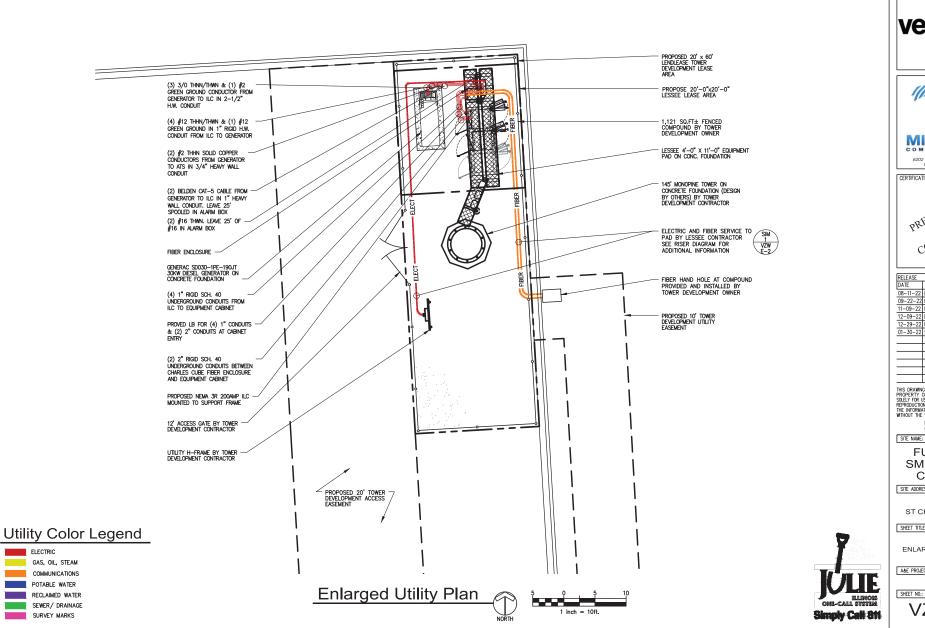
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| -22-22   | PRELIMINARY SITE PLAN |
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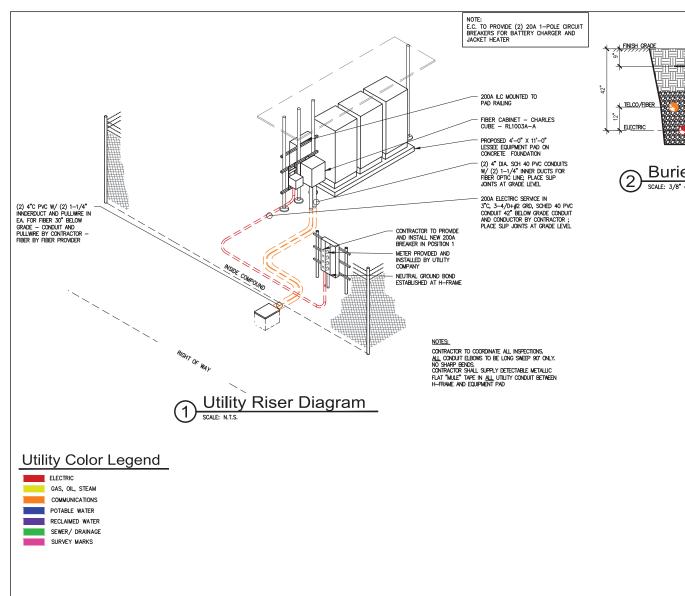
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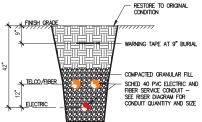
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A&E PROJECT NO.:











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SHEET TITLE:

ELECTRICAL AND TELCO UTILITY DETAILS

A&E PROJECT NO.:

SHEET NO.:


## TYPICAL GROUNDING NOTES

- #2 AWG TINNED SOLID BARE COPPER CONDUCTOR 42" BELOW GRADE (TYPICAL) MINIMUM 24" BENDING RADIUS
- PAD CORNER POST, STEEL COLUMN, STEEL BEAM & CANOPY GROUND
- 3. CABINET GROUND BOLTED TO UNIT HOUSING
- 4. DISCONNECT AND ELECTRIC SERVICE GROUND TO GROUND ROD
- 5. 5/8" X 10' COPPER CLAD GROUND ROD
- GROUND CHAIN LINK FENCE (TYPICAL) EXOTHERMIC CONNECTION (TYPE VS) GROUND FENCE POSTS WITHIN 6 FEET OF PAD AND 25 FEET OF TOWER. (SEE DETAIL, SHEET VZW E-5.)
- GROUND CABLE WAVEGUIDE BRIDGE (TYP.) BY ELECTRICAL CONTRACTOR.
- 8. TOWER GROUND RING (V.I.F.)
- 9. BOND PROPOSED TOWER GROUND RING TO PROPOSED GROUND RING WITH #2 AWG TNND SOLID COPPER CONDUCTOR IN 2 LOCATIONS.
- TWO #2 LEADS FROM THE EGR TO THE GROUND BAR AT UTILITY FRAME LOCATED ON EQUIPMENT PAD STEEL. CADWELD AT EGR AND DOUBLE HOLE LUGS ON EQUIPMENT PAD.
- COPPER CLAD GROUND ROD WITH INSPECTION WELL TOP OF GROUND ROD MAX 24" BURY. SEE DETAIL SHEET VZW E-5.
- EXTEND GROUND CONDUCTORS IN 1/2" RIGID H.W. CONDUIT ADJACENT TO PAD, OFFSET AND ATTACH TO EXTERIOR OF GENERATOR HOUSING AND EXTEND TO GROUND LUGS AS REQUIRED, VERIFY LOCATION WITH GENERAC.
- 13. MGB MOUNTED UNDER PERIMETER BEAM

# Grounding Legend

- GROUND ROD
- @ GROUND SYSTEM TEST WELL (HAND HOLE)
- **■** CADWELD CONNECTION

→ FENCE LINE

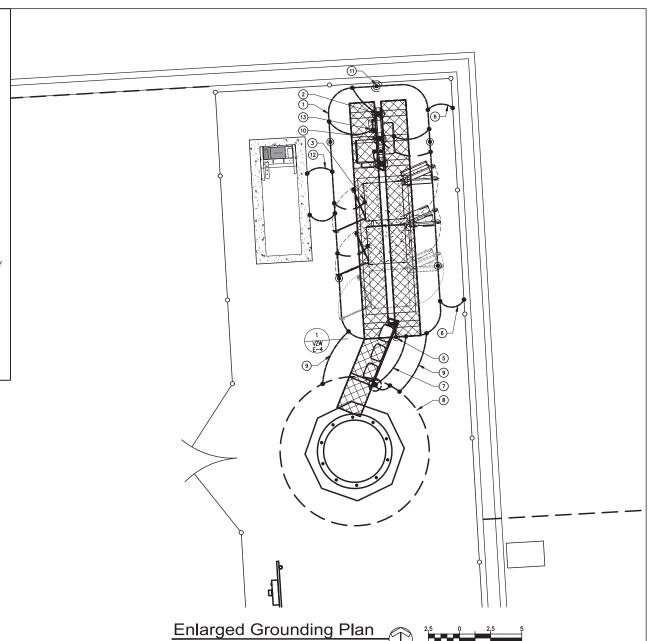





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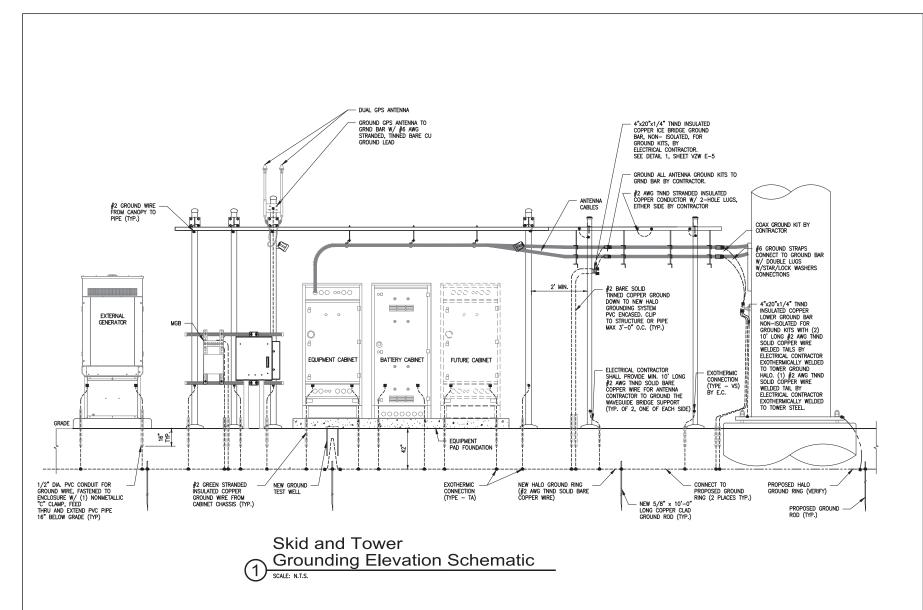
IL-64 ST CHARLES, IL 60174

SHEET TITLE:

ENLARGED GROUNDING PLAN

A&E PROJECT NO.:

SHEET NO.:







PRELIMINARY
PRELIMINARY
CONSTRUCTION

| RELEASE  |                       |
|----------|-----------------------|
| DATE     |                       |
| 08-11-22 | PRELIMINARY SITE PLAN |
| 09-22-22 | PRELIMINARY SITE PLAN |
|          | LEASE EXHIBIT         |
| 12-09-22 | LEASE EXHIBIT         |
|          | LEASE EXHIBIT         |
| 01-30-22 | 90% CDs               |
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CHECKED BY: N

SITE NAME:

FULL RELO SMITH & MAIN CELL SITE

SITE ADDRESS:


IL-64 ST CHARLES, IL 60174

SHEET TITLE:


GROUNDING SCHEMATIC AND DETAILS

A&E PROJECT NO.:

SHEET NO.:

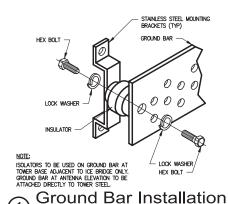



SCALE: 3" = 1'-0"

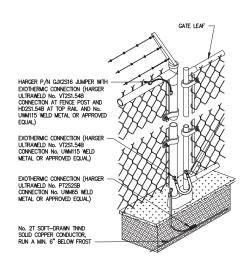

Fence and

**Gate Grounding** 

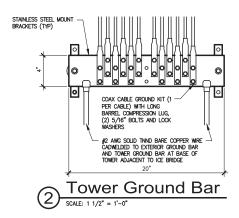

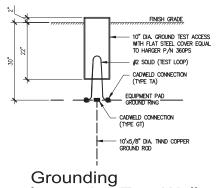





Type VN HORIZONTAL CABLE TAP TO VERTICAL STEEL SURFACE OR THE SIDE OF HORIZONTAL PIPE



Type W THROUGH VERTICAL CABLE TO VERTICAL STEEL SURFACE OR TO THE SIDE OF EITHER HORIZONTAL OR VERTICAL PIPE



Type VS CABLE TAP DOWN AT 45° TO VERTICAL STEEL SURFACE OR SIDE OF HORIZONTAL OR



Type GY THROUGH CABLE TO SIDE OF GROUND ROD



Type GT THROUGH AND TAP CABLES TO GROUND ROD THROUGH CABLE TO TOP OF GROUND ROD



Type XB CROSS OF HORIZONTAL CABLES, LAPPED AND NOT



Type GR CABLE TAP TO TOP OF GROUND ROD



HORIZONTAL CABLE TAP TO HORIZONTAL STEEL SURFACE OR PIPE. CABLE OFF SURFACE



Type TA TEE OF HORIZONTAL RUN AND TAP CABLES



Exothermic (Cadweld) Details





CERTIFICATION: PRELIMINARY
PRELIMINARY NUI TURTION CONSTRUCTION

| RELEASE  |                       |
|----------|-----------------------|
|          |                       |
| DATE     |                       |
|          | PRELIMINARY SITE PLAN |
| 09-22-22 | PRELIMINARY SITE PLAN |
| 11-09-22 | LEASE EXHIBIT         |
| 12-09-22 | LEASE EXHIBIT         |
| 12-29-22 | LEASE EXHIBIT         |
| 01-30-22 | 90% CDs               |
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SITE NAME:

**FULL RELO** SMITH & MAIN **CELL SITE** 

SITE ADDRESS:

IL-64 ST CHARLES, IL 60174

SHEET TITLE:

GROUNDING DETAILS

A&E PROJECT NO.:

SHEET NO.:

#### **GENERAL**

THE CONSTRUCTION DOCUMENT DRAWINGS ARE INTERRELATED. WHEN PERFORMING THE WORK, EACH CONTRACTOR MUST REFER TO ALL DRAWINGS. COORDINATION IS THE RESPONSIBILITY OF THE GENERAL CONTRACTOR.

### **DIVISION 1: GENERAL REQUIREMENTS**

### SECTION 01700 - PROJECT CLOSEOUT

### PART 1 - GENERAL

- 1. OBTAIN AND SUBMIT RELEASES ENABLING THE OWNER UNRESTRICTED USE OF THE WORK AND ACCESS TO SERVICES AND UTILITIES; INCLUDE OCCUPANCY PERMITS, OPERATING CERTIFICATES AND SIMILAR RELEASES.
- SUBMIT RECORD DRAWINGS, DAMAGE OR SETTLEMENT SURVEY, PROPERTY SURVEY, AND SIMILAR FINAL RECORD INFORMATION.
- 3. COMPLETE FINAL CLEAN UP REQUIREMENTS, INCLUDING TOUCH-UP PAINTING. TOUCH UP AND OTHERWISE REPAIR AND RESTORE MARRED EXPOSED FINISHES.

#### PART 2 - FINAL CLEANING

- COMPLETE THE FOLLOWING CLEANING OPERATIONS BEFORE REQUESTING INSPECTION
  FOR CERTIFICATION OF COMPLETION.
   A CLEAN THE PROJECTIVITY AND GROUNDS, IN AREAS DISTURBED BY
  A CLEAN THE PROJECTIVITY OF CLUBBIC LANGUAGE OF ENGLOPENT AREAS OF
  RUBBISH, WASTE MATERIALS, LITTLE AND FOREIGN SUBSTANCES. SEPERATE AND FOREIGN SUBSTANCES. SEPERATE OF
  RUBBISH, WASTE MATERIALS, LITTLE AND FOREIGN SUBSTANCES, STANS AND OTHER
  FOREIGN DEPOSITS. RAKE GROUNDS THAT ARE METHER PLANTED NOR PAYED,
  TO A SMOOTH EVENT-EXTENTED SURFACE.

  TO A SMOOTH EVENT-EXTENTED SURFACE.

  \*\*CONTINUED TO THE PROJECTIVE SURFACE.\*\*
  \*\*CONTINUED SURFACE.\*\*
- FOREIGN DEPOSITS, AREA GROUDS HAT ARE.

  TO A SHOON EVEN-TEXTURED SHIFFACE.

  B. READNE TOCK, SONSTRUCTION COMPILENT, MACHINERY AND SURPLUS.

  B. READNE TOCK, SONSTRUCTION COMPILENT, MACHINERY AND SURPLUS.

  C. READNE'S SHOW AND LCT OF PROMDE SAFE ACCESS TO THE SITE AND EQUIPMENT ENCLOSME.

  O. CLEAN EXPOSED EXTERIOR AND INTERIOR HARD-SHIFFACED FINISHES TO A DIRT-FREE CONDITION, FREE OF STAINS, FILMS AND SMILAR FOREIGN SUBSTANCES. AVOID DISTRIBINEN HATURAL MEATHERING OF EXTERIOR SHIFFACES.

  E. READNE DEBRIS FROM LIMITED ACCESS SPACES, INCLUDING ROOFS, COUPHENT ENCLOSMER, MANIFOLES, AND SHIFFACES THAT CAN ENTRY THE ACCESS SPACES, INCLUDING ROOFS, COUPHENT ENCOSMER, MANIFOLES, AND SHIFFACES THAT CAN CAN SHIFFACE THAT SHOW ENDERHOE OF REPAR OR RESTORATION, DO NOT PAINT OVER "U.L. AND SHIFFACES. REPLACE THAT SHOW ENDERHOE OF REPAR OR RESTORATION, DO NOT PAINT OVER "U.L. AND SHIFFACES. THAT CAN FOLLOW FOR THAT SHOW ENDERHOE OF REPAR OR RESTORATION, DO NOT PAINT OVER "U.L. AND SHIFFACES. INCLUDING ELECTRICAL NAME PLATES.
- ENCLOSURE.
  STRIP, WASH AND WAX FLOOR WITHIN EQUIPMENT ENCLOSURE WITH NON-STATIC WAX.
- 2. REMOVAL OF PROTECTION: REMOVE TEMPORARY PROTECTION AND FACILITIES INSTALLED DURING CONSTRUCTION TO PROTECT PREVIOUSLY COMPLETED INSTALLATIONS DURING THE REMAINDER OF THE CONSTRUCTION PERIOD.

### DIVISION 2: SITE WORK

SECTION 02200 -EARTHWORK AND DRAINAGE

### PART 1 - GENERAL

1. WORK INCLUDED: SEE SITE PLAN

DESCRIPTIONS
 COCCESS DRIVE WITH TURNAROUND AREA, LEASE AREA, AND IF APPLICABLE UNDERRECOUND UTILITY EASEMENTS ARE TO BE CONSTRUCTED TO PROVIDE A WELL DRAINED, EASILY MAINTAINED, EVEN SURFACE FOR MATERIAL AND EQUIPMENT DELIVERES AND MAINTENANCE PERSONNEL ACCEPTAGE TO MATERIAL AND EQUIPMENT

- 3. QUALITY ASSURANCE
  A. APPLY SOIL STERILIZER IN ACCORDANCE WITH MANUFACTURER'S RECOMMENDATIONS (AS NEEDED)
  - B. APPLY AND MAINTAIN GRASS SEED AS RECOMMENDED BY THE SEED PRODUCER (IF REQUIRED).
- (I'' REQUIRED).

  C. PLACE AND MAINTAIN VEGETATION LANDSCAPING, IF INCLUDED WITHIN THE CONTRACT, AS RECOMMENDED BY NURSERY INDUSTRY STANDARDS.

- 4. SEQUENCING
  A. CONFIRM SURVEY STAKES AND SET ELEVATION STAKES PRIOR TO ANY
- A COMPINED SURVEY STAKES AND SET LEVATION STAKES PRIOR TO ART CONSTRUCTION OF THE ACCESS DRIVE WITH TURNAROUND, UNDERGROUND UTILITY EASEMENTS, (IF APPLICABLE) AND LEASE AREA PRIOR TO FOUNDA CONSTRUCTION, PLACEMENT OF BACKFILL AND SUB-BASE MATERIAL C. CONSTRUCT LEMPORARY CONSTRUCTION AREA ALONG ACCESS DRIVE.

- D. BRING THE LEASE AREA AND ACCESS DRIVE WITH TURNAROUND TO BASE COURSE ELEVATION PRIOR TO INSTALLING FOUNDATION.
   APPLY SOIL STERILIZER PRIOR TO PLACING BASE MATERIALS. GRADE, SED, IFERTUJE, AND MULCH ALL AREAS DISTURBED BY CONSTRUCTION (INCLIDING INDERFORMON UTILITY EASIENITS) MINEDIATELY AFFER RENGING LEASE, AREA, AND ACCESS DRIVE WITH TURNAROUND TO BASE COURSE LEVATION, WARTER TO BESIDER GROWTH.
  REMOVE, GRAVEL, FROM TEMPOGRAPY CONSTRUCTION ZONE TO AM AUTHORIZED AREA OR AS DISTORCED BY PROCEED MANAGER.
- H. AFTER APPLICATIONS OF FINAL SURFACES, APPLY SOIL STERILIZER TO STONE

### 5. SUBMITTALS

### A. BEFORE CONSTRUCTION

BELVINE, LANS.HIGU,CION
IE LANDSCAPINE IS APPLICABLE TO THE CONTRACT, SUBMIT TWO COPIES OF THE
LANDSCAPE FLAN UNDER NURSERY LETTERHEAD. IF A LANDSCAPE, ALLOMANCE
WAS INCLUDED IN THE CONTRACT, PROVIDE AN ITBLEZED LISTING OF PROPOSED
COSTS ON NURSERY LETTERHEAD (REFER TO PLANS FOR LANDSCAPING
COURTMENTS).

- B. AFTER CONSTRUCTION
  1. MANUFACTURER'S DESCRIPTION OF PRODUCT AND WARRANTY STATEMENT ON
- SOIL STERILIZED.

  2. MANUFACTURE'S DESCRIPTION OF PRODUCT ON GRASS SEED AND FERTILIZER

  3. LANDSCAPING WARRANTY STATEMENT.

- ANIANTAL TO THE WARRANTY ON ALL CONSTRUCTION COVERED IN THE CONTRACT DOCUMENTS, THE CONTRACT SHALL REPAIR ALL DAMAGE AND RESTORE AREA AS CLOSE TO ORIGINAL CONDITION AS POSSIBLE AT SITE AND SURROUNDINGS
- SURROUNDINGS.

  B. SOIL STERILIZATION APPLICATION TO GUARANTEE VEGETATION FREE ROAD AND STE AREAS FOR ONE YEAR FROM DATE OF FINAL INSPECTION.

  C. DISTURBED AREAS WILL REFLECT GROWTH OF NEW GRASS COVER PRIOR TO DAILY INSPEC
- D. LANDSCAPING, IF INCLUDED WITHIN THE SCOPE OF THE CONTRACT, WILL BE GUARANTEED FOR ONE YEAR FROM DATE OF FINAL INSPECTION.

### PART 2 - PRODUCTS

#### 1. MATERIALS

A. SOIL STERILIZER SHALL BE EPA-REGISTERED, PRE-EMERGENCE LIQUID: TOTAL KILL PHASAR CORPORATION

PRODUCT 910 EPA 10292-7 AMBLISH HEDDICIDE

EPA REGISTERED

P.O. BOX 5123 DEARBORN, MI 48128 (313) 563-8000

FRAMAR INDUSTRIAL PRODUCTS UNION, NJ 07083 (800) 526-4924

- B. ROAD AND SITE MATERIALS SHALL CONFORM TO MOOT SPECIFICATIONS FILL MATERIAL (UNLESS OTHERWISE NOTED) — ACCEPTABLE SELECT FILL SHALL BE IN ACCORDANCE WITH STATE DEPARTMENT OF HIGHWAY AND TRANSPORTATION TANDARD SPECIFICATIONS
- C. SOIL STABILIZER FABRIC SHALL BE MIRAFI 500X.

### PART 3 - EXECUTION

LOCAL BUILDING INSPECTORS SHALL BE NOTIFIED NO LESS THAN 48 HOURS IN ADVANCE OF CONCRETE POURS. UNLESS OTHERWISE SPECIFIED BY JURISDICTION.

### 2. PREPARATION

- A. CLEAR TREES, BRUSH AND DEBRIS FROM LEASE AREA, ACCESS DRIVE WITH TURN—AROUND AND UNDER GROUND UTILITY EASEMENTS AS REQUIRED FOR CONSTRUCTION.
- B. PRIOR TO OTHER EXCAVATION AND CONSTRUCTION, GRUB ORGANIC MATERIAL TO A MINIMUM OF SIX (6) INCHES BELOW GRADE.

  C. UNLESS OTHERWISE INSTRUCTED BY VERIZON WIRELESS, TRANSPORT ALL REMOVED TREES, BRUSH AND DEBRIS FROM THE PROPERTY TO AN AUTHORIZED
- LANDFILL.

  D. PRIOR TO PLACEMENT OF FILL OR BASE MATERIALS, ROLL THE SOIL.

  E. WHERE UNSTABLE SOIL CONDITIONS ARE ENCOUNTERED, LINE THE AREAS
  WITH STABILIZER MAT PRIOR TO PLACEMENT OF FILL OR BASE MATERIAL.

### 3. INSTALLATION

- A. GRADE OR FILL THE LEASE AREA AND ACCESS DRIVE WITH TURNAROUND AS REQUIRED IN ORDER THAT UPON DISTRIBUTION OF SPOILS, RESULTING FROM EXCAVATIONS, THE RESULTING GRADE WILL CORRESPOND WITH SAID SUB-BASE COURSE. ELEVATIONS ARE TO BE CALCULATED FROM BENCHMARK, FINISH
- COURSE. ELEVATIONS ARE 10 BE CALLOLATED FROM BENJAMARK, FINISH GRADES, OR MIDICATED SLOPES.

  B. GLEAR EXCESS SPOILS, IF ANY, FROM JOB SITE AND DO NOT SPREAD BEYOND THE LIMITS OF PROJECT AREA UNILESS AUTHORIZED BY VERIZON WRELESS CONSTRUCTION MANAGER AND AGED TO BY LANDOWNER.

  C. BRING THE ACCESS DRIVE WITH TURNAROUND TO BASE COURSE ELEVATION TO
- FACILITATE CONSTRUCTION AND OBSERVATION DURING CONSTRUCTION OF THE
- D. AVOID CREATING DEPRESSIONS WHERE WATER MAY POND
- THE CONTRACT SHALL INCLUDE GRADING, BANKING, AND DITCHING, UNLESS OTHERWISE INDICATED.
- F. WHEN IMPROVING AN EXISTING ACCESS DRIVE, GRADE THE EXISTING DRIVE TO REMOVE ANY ORGANIC MATTER AND SMOOTH THE SURFACE BEFORE PLACING FILL OR STONE
- G. PLACE FILL OR STONE IN SIX (6) INCH MAXIMUM LIFTS, AND COMPACT BEFORE
- PLACING NEXT LIFT.

  THE TOP SUPFACE COURSE, SHALL EXTEND A MINIMUM OF ONE (1) FOOT BEYOND THE SITE FENCE (UNLESS OTHERWISE NOTED) AND SHALL COVER THE AREA AS INDICATED.

  APPLY RIPPAP TO THE SIDE SLOPES OF ALL FENCED SITE AREAS, PARKING
- AREAS, AND ALL OTHER SLOPES GREATER THAN 2:1.
  APPLY RIPRAP TO THE SIDES OF DITCHES OR DRAINAGE SWALES.
- K. RIPRAP ENTIRE DITCH FOR SIX (6) FEET IN ALL DIRECTIONS AT CULVERT
- L. APPLY SEED, FERTILIZER, AND STRAW COVER TO ALL OTHER DISTURBED AREAS, DITCHES, AND DRAINAGE SWALES, NOT OTHERWISE RIPRAPPED.

  M. UNDER NO CIRCUMSTANCES WILL DITCHES, SWALES, OR CULVERTS BE PLACED SO THAT THEY DIRECT WATER TOWARDS, OR PERMIT STANDING WATER IMMEDIATELY ADJACENT TO EQUIPMENT PAD OR EQUIPMENT. IF DESIGNS OR ELEVATIONS
- ARE IN CONFLICT WITH THIS, ADVISE CONSTRUCTION MANAGER IMMEDIATELY, N. IN DITCHES WITH SLOPES GREATER THAN 10%, MOUND DIVERSIONARY
  HEADWALLS IN THE DITCH AT CULVERT ENTRANCES. POSITION THE HEADWALL
  AT AN ANGLE NO GREATER THAT 60° OFF THE DITCH LINE. RIPRAP THE UPSTREAM SIDE OF THE HEADWALL AS WELL AS THE DITCH FOR SIX (6) FEET ABOVE THE CULVERT ENTRANCE.
- O APPLY SEED AND FERTILIZER TO SURFACE CONDITIONS WHICH WILL ENCOURAGE ROOTING. RAKE AREAS TO BE SEEDED TO EVEN THE SURFACE AND LOOSEN THE SOIL
- P. SOW SEED IN TWO DIRECTIONS IN TWICE THE QUANTITY RECOMMENDED BY THE SEED PRODUCER.
- SEED PRODUCER.

  Q. ENSURE GROWTH OF SEEDED AND LANDSCAPED AREAS, BY WATERING, UP TO THE POINT OF RELEASE FROM THE CONTRACT. CONTINUE TO REWORK THE BARE AREAS UNTIL COMPLETE COVERAGE IS OBTAINED.

### 4. FIFLD QUALITY CONTROL

COMPACT SOILS TO MAXIMUM DENSITY IN ACCORDANCE WITH ASTM D-1557.

AREAS OF SETTLEMENT WILL BE EXCAVATED AND REFILLED AT CONTRACTOR'S EXPENSE. INDICATE PERCENTAGE OF COMPACTION ACHIEVED ON AS-BUILT

### 5. PROTECTION

- A. PROTECT SEEDED AREAS FROM EROSION BY SPREADING STRAW TO A UNIFORM LOOSE DEPTH OF 1-2 NOHES, STAKE AND THE DOWN AS REQUIRED. USE OF EROSION CONTROL MESH OR MULCH NET WILL BE AN ACCEPTABLE ALTERNATE.

  B. ALL TREES PLACED IN CONJUNCTION WITH A LANDSCAPE CONTRACT WILL BE
- WRAPPED, TIED WITH HOSE PROTECTED WIRE, AND SECURED TO 2" x 2" x 4'-0' WOODEN STAKES EXTENDING TWO-FEET INTO THE GROUND ON FOUR SIDES OF OF THE TREE.
- C. PROTECT ALL EXPOSED AREAS AGAINST WASHOUTS AND SOIL EROSION. PLACE STRAW BALES AT THE INLET APPROACH TO ALL NEW OR EXISTING CULVERTS.
  WHERE THE SITE OR ROAD AREAS HAVE BEEN ELEVATED IMMEDIATELY ADJACENT TO THE RAIL LINE, STAKE EROSION CONTROL FABRIC FULL LENGTH IN THE SWALE TO PREVENT CONTAMINATION OF THE RAIL BALLAST. ALL EROSION CONTROL METHODS SHALL CONFORM TO APPLICABLE BUILDING CODE

### SECTION 02830 - FENCING AND GATE(S)

### PART 1 -GENERAL

- 1. WORK INCLUDED
- SEE PLAN FOR SITE AND LOCATION OF FENCE AND GATE(S).
- 2. QUALITY ASSURANCE QUALITY ASSURANCE ALL STEEL MATERIALS UTILIZED IN CONJUNCTION WITH THIS SPECIFICATION WILL BE GALVANIZED OR STAINLESS STEEL. WEIGHT OF ZINC COATING ON THE FABRIC SHALL NOT BE LESS THAN 12 CUNCES PER SQUARE FOOT OF MATERIAL COVERED. POSTS SHALL BE, HOT-DIPPED IN GRADE "E" ZINC, 18 OUNCES PER SQUARE FOOT. 3. SEQUENCING
- IF THE SITE AREA HAS BEEN BROUGHT UP TO SURFACE COURSE ELEVATION (PRIOR TO THE FENCE CONSTRUCTION), FENCE POST EXCAVATION SPOILS MUST BE CONTROLLED TO PRECLUDE CONTAMINATION OF SAID SURFACE COURSE.
- A. MANUFACTURER'S DESCRIPTIVE LITERATURE.
  B. CERTIFICATE OR STATEMENT OF COMPLIANCE WITH THE SPECIFICATIONS.

### PART 2 - PRODUCTS

### 1. FENCE MATERIAL

- A. ALL FABRIC WIRE, RAILS, HARDWARE, AND OTHER STEEL MATERIALS SHALL BE HOT-DIPPED GALVANIZED.
- B. FABRIC SHALL BE SEVEN-FOOT HIGH OR TO MATCH EXISTING FENCE TWO" CHAIN LINK MESH OF NO. 9 GAUGE (0.148") WIRE. THE FABRIC SHALL HAVE A KNUCKLED FINISH FOR THE TOP SELVAGES.
- ABRIC SHALL CONFORM TO THE SPECIFICATIONS OF ASTM A-392 CLASS 1
- C. BARBED WIRE SHALL BE DOUBLE-STRAND, 12-1/2 GAUGE TWISTED WIRE, WITH 14-GAUGE, 4-POINT ROUND BARBS SPACED ON FIVE CENTERS.

  D. ALL POSTS SHALL BE SCHEDULE 40 BECHANICAL SERVICE PIPE AND SHALL BE TYPE 1 ASTM A-128 AND OF THE FOLLOWING DIA.
  - LINE 2 1/2" SCHEDULE 40 (3" O.D.)
    CORNER 3" SCHEDULE 40 (3 1/2" O.D.) 4" SCHEDULE 40 (4 1/2" O.D.
- E. GATE POSTS SHALL BE EXTENDED 12 INCHES, INCLUDING DOME CAP, TO
- E GATE POSTS STALL BE EXTENDED 12 INCHES, WILCOUND DOME CAP, 10
  PROVIDE FOR ATTACHMENT OF BARBED WIRE.

  F. ALL TOP AND BRACE RAILS STALL BE 15/8" DIA. DIA. SCHEDULE 40
  MECHANICAL SERVICE PIPE.

  G. GATE FRAMES AND BRACES STALL BE 2" DIA. SCHEDULE 40
  MECHANICAL SERVICE PIPE. FRAMES STALL HAVE WELDED CORNERS.

  H. GATE FRAMES STALL HAVE A PULL—HEIGHT VERTICAL BRACE, AND A FULL—WDTH
  HORZONTAL BRACE, SECURED IN PLACE BY USE OF GATE BRACE CLAMPS.
- I. GATE HINGES SHALL BE MERCHANTS METAL MODEL 64386 HINGE ADAPTER WITH MODEL 6409, 188-DEGREE ATTACHMENT.
- J. THE GUIDE (LATCH ASSEMBLY) SHALL BE HEAVY INDUSTRIAL DOUBLE GATE
- LAIDH, SEE DEIAIL.

  K. LATCHES AND STOPS SHALL BE PROVIDED FOR ALL GATES.

  PLINICER ROD COMPLETE WITH RECEPTIOR TO BE PROVIDED AT THE INACTIVE LEAF OF ALL DOUBLE GATE INSTALLATIONS.

  M. ALL STOPS SHALL HAVE KEEPERS CAPABLE OF HOLDING THE GATE LEAF IN THE O'PEN POSTION)
- N. A NO. 7 GAUGE ZINC COATED TENSION WIRE SHALL BE USED AT THE BOTTOM OF THE FABRIC, TERMINATED WITH BAND CLIPS AT CORNER AND GATE POSTS.

  O. A SX. BY 1/2" DIA. EYEBOLT TO HOLD TENSION WIRE SHALL
- RE PLACED AT LINE POSTS P. STRETCHER BARS SHALL BE 3/16" BY 3/4" OR HAVE EQUIVALENT CROSS-SECTIONAL AREA.
- Q. ALL CORNER GATE AND PANELS SHALL HAVE A 3/8" TRUSS ROD WITH TURNBUCKLES.
- R. ALL POSTS EXCEPT GATE POSTS SHALL HAVE A COMBINATION CAP AND BARBED WIRE SUPPORTING ARM. GATE POSTS SHALL HAVE A DOME CAP.
  S. OTHER HARDWARE INCLUDES BUT MAY NOT BE LIMITED TO TIE CLIPS, BAND
- CLIPS AND TENSION BAND CLIPS.

  T. BARBED WIRE GATE GUARDS SHALL BE FITTED WITH DOME CAPS.
- U. BARBED WIRE SUPPORT ARMS SHALL BE PRESSED STEEL COMPLETE WITH SET BOLT AND LOCK WIRE IN THE ARM. V. ALL CAPS SHALL BE MALLEABLE IRON, DOME OR ACORN SHAPED AS REQUIRED BY PIPE SIZE.
- W. WHERE THE USE OF CONCERTINA HAS BEEN SPECIFIED, 24" DIA. COIL. BARBED TAPE, STAINLESS STEEL, CYCLONE FENCE MODEL GOP TO TYPE III SHALL BE FURNISHED. IT SHALL BE SUPPORTED ABOVE THE TOP RAIL BY USE OF SIX (6) WIRE BARBED WIRE ARMS POSITIONED ATOP EACH LINE/CORNER POST.

### PART 3 - EXECUTION

TO CONFIRM PROPER DEPTH AND DIA. OF POST HOLE EXCAVATIONS. ALL POST HOLES WILL BE EXCAVATED AS PER CONSTRUCTION DOCUMENTS.

### 2 INSTALLATION

- A. FOUNDATIONS SHALL HAVE A MINIMUM SIX (6) INCH CONCRETE COVER UNDER POST.
- B ALL FENCE POSTS SHALL BE VERTICALLY PLUMB; ONE QUARTER (1/4) INCH C. AT CORNER POSTS, GATE POSTS, AND SIDES OF GATE FRAME, FABRIC SHALL BE ATTACHED WITH STRETCHER AND TENSION BAND—CLIPS AT FIFTEEN(15) INCH
- D. AT LINE POSTS, FABRIC SHALL BE ATTACHED WITH BAND-CLIPS AT FIFTEEN (15) INCH INTERVALS
- INVOLVINITIES ATTACHED TO BRACE RAILS, TENSION WIRE AND TRUSS RODS WITH TIE-CLIPS AT TWO (2) FOOT INTERVALS.
- F. A MAXIMUM GAP OF ONE MICH WILL BE PERMITTED BETWEEN TIE CHAIN LINE FABRIC AND THE FINAL GRADE.
  G. GATE SHALL BE INSTALLED SO LOCKS ARE ACCESSIBLE FROM BOTH SIDES.
- H. GATE HINGE BOLTS SHALL HAVE THEIR THREADS PEENED OR WELDED TO
- PREVENT UNAUTHORIZED REMOVAL CONCRETE TO BE A MINIMUM OF 4,000 PSI AT 7 DAYS. CEMENT SHALL EXCEED
- ASTM C150, TYPE IIIA. 3. PROTECTION
  UPON COMPLETION OF ERECTION, INSPECT FENCE MATERIAL AND PAINT FIELD CUTS
  OR GALVANIZING BREAKS WITH ZINC-BASED PAINT, COLOR TO MATCH THE GALVANIZED

## APPLICABLE STANDARDS ASTM-A120 SPECIFICATION FOR PIPE, STEEL BLACK AND HOT-DIPPED ZINC

COATED (GALVANIZED) WELDED AND SEAMLESS, FOR ORDINARY USES. ASTM-A123 ZINC (HOT-DIP GALVANIZED) COATING ON IRON AND STEEL PRODUCTS.
ASTM-A153 STANDARD SPECIFICATION FOR ZINC COATING (HOT-DIP)

ON IRON AND STEEL HARDWARE ASTM-A392 SPECIFICATION FOR ZINC-COATED STEEL CHAIN LINK FENCE FABRIC. ASTM-A491 SPECIFICATION FOR ALUMINIUM-COATED STEEL CHAIN LINK

ASTM-A525 STANDARD SPECIFICATION FOR STEEL SHEET ZINC COATED (GALVANIZED) BY THE HOT-DIPPED PROCESS. ASTM-A570 SPECIFICATION FOR HOT-ROLLED CARBON STEEL SHEET AND STRIP.

STRUCTURAL QUALITY.

ASTM-A535 SPECIFICATION FOR ALUMINIUM COATED STEEL BARBED WIRE. FEDERAL SPECIFICATION RR-F-191- FENCING, WIRE AND POST METAL (AND GATES,

## **DIVISION 3: CONCRETE**

CHAIN LINK FENCE FABRIC, AND ACCESSORIES)

SECTION 03000 -BASIC CONCRETE MATERIALS AND METHODS

### PART 1 - GENERAL

1. WORK INCLUDED FORMVORK, REINFORCEMENT, ACCESSORIES, CAST-IN-PLACE CONCRETE, FINISHING, AND CURRIE.

- 2. INSPECTIONS A. CONTRACTOR IS RESPONSIBLE FOR SCHEDULING BUILDING DEPARTMENT
- INSPECTIONS REQUIRED FOR HIS SCOPE OF WORK.

  ALL REINFORCING STEEL SHALL BE INSPECTED AND APPROVED BY THE VERIZON WIRELESS CONSTRUCTION MANAGER PRIOR TO PLACEMENT OF CONCRETE.
- C. THE VERIZON WIRELESS CONSTRUCTION MANAGER SHALL BE NOTIFIED NO LESS THAN 48 HOURS IN ADVANCE OF CONCRETE POURS.

  3 QUALITY ASSURANCE
- QUALITY ASSURANCE

  A CONSTRUCT AND ERECT CONCRETE FORMWORK IN ACCORDANCE WITH
  ACI 301 AND ACI 318.

  B. PERFORM CONCRETE REINFORCING WORK IN ACCORDANCE WITH ACI 301,
  ACI 318, AND ASTM A184.
- C. PERFORM CAST-IN-PLACE CONCRETE WORK IN ACCORDANCE WITH ACI 301, ACI 318, AND ACI 117-90. D. OPEN FOUNDATION TRENGHES SHALL BE INSPECTED BY VERIZON WIRELESS CONSTRUCTION MANAGER PRIOR TO PLACEMENT OF CONCRETE.

  4. SUBMITTALS
  - Submittals Submit Concrete MIX and Renforong Steel Shop Drawings for Approval by Yerzon Wreless Construction Manager/Pagnree The Shop Drawings Shall be Submitted in the Form of Two (2) Concrete MIX Design Information Sheets and Two (2) Blueline Drawings for Reinforong Steel

### PART 2 - PRODUCTS

### 1. REINFORCEMENT MATERIALS

- A. REINFORGENT STEEL, ASTM A615, 60 ksi YELD GRADE, DEFORMED BILLET STEEL BARS, PLAIN FINISH. B. WELDED STEEL WIRE FABRIC ASTM A185 PLAIN TYPE, IN FLAT SHEETS, PLAIN FINISH.
- C. CHAIRS, BOLSTERS, BAR SUPPORTS, SPACERS. SIZED AND SHAPED FOR SUPPORTS OF REINFORCING.
- D. FABRICATE CONCRETE REINFORCING IN ACCORDANCE WITH ACI 315, ACI 318, ASIM A184.

  2. CONCRETE MATERIALS.

C. WATER: CLEAN AND NOT DETRIMENTAL TO CONCRETE

- CONGRETE MATERIALS

  A. CEMENT: ASTN C150, PORTLAND TYPE

  B. FINE AND COURSE AGGREGATES: ASTN

  AGGREGATE SHALL NOT EXCEED: ONE (1) NICH SIZE SUITABLE FOR

  INSTALLATION METHOD UTILIZED OR ONE—THIRD CLEAR DISTANCE BEHIND OR BETWEEN REINFORCING.
- AIR ENTRAINING ADMIXTURE: ASTM C260 E. BONDING AGENT: LATEX EMULSION FOR BONDING NEW TO OLD CONCRETE AS MANUFACTURED BY DAYTON SUPERIOR

## MANUFACTURED BY DATTON SUPERIOR. NON-SHRINK GROUT: PREMIXED COMPOUND CONSISTING OF NONMETALLIC AGGREGATE. CEMENT, WATER REDUCING AND PLASTICISING AGENTS. CONTINUED ON SHEET SP-2





CERTIFICATION: PRELIMINARY CONSTRUCTION NOT FOR

RELEASE DATE 08-11-22 PRELIMINARY SITE PLAN 09-22-22 PRELIMINARY SITE PLAN 11-09-22 LEASE EXHIBIT 12-09-22 LEASE EXHIBIT 12-29-22 LEASE EXHIBIT 01-30-22 90% CDs

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DRAWN BY:

## **FULL RELO** SMITH & MAIN **CELL SITE**

SITE ADDRESS:

SITE NAME:

ST CHARLES, IL 60174 SHEET TITLE:

IL-64

SPECIFICATIONS

A&E PROJECT NO.:

SHEET NO.: **VZW SP-1** 

- A. CONCRETE MATERIALS SHALL CONFORM TO THE APPROPRIATE A.C.I.
- REQUIREMENTS FOR EXPOSED STRUCTURAL CONCRETE.

  B. MIX AND DELIVER CONCRETE IN ACCORDANCE WITH ASTM C94, ALT. 3. C. PROPORTIONS OF CONCRETE MATERIALS SHALL BE SUITABLE FOR THE INSTALLATION METROU UTILIZED. AND SHALL RESULT IN DURBALE CONCRETE FOR LOCAL ANTICIPATED AGGRESSIVE ACTIONS. THE DURBALITY REQUIREMENTS OF A 316 CHAPTER 4 SHALL BE SATISTED BASED ON THE CONDITIONS DEPOCIED AT THE SITE. PROVIDE CONCRETE AS FOLLOWS:
  - COMPRESSIVE STRENGTH: 4000 psi AT 7 DAYS.
     SEE TOWER MANUFACTURER DRAWINGS FOR CAISSON CONCRETE COMPRESSIVE STRENGTH
  - 2. SLUMP: 3 INCHES

#### PART 3 - EXECUTION

- I. INSERTS, BUREDDED COMPONENTS AND OPENINGS

  A THE CONTRACTOR SHALL COORDINATE AND CROSS-CHECK ARCHITECTURAL,
  BUILLING & ELECTRICAL DEMANIOS FOR OPENINGS, SLEEPES, ANCHORS,
  HANGERS, AND OTHER TIEMS RELATED TO CONCRETE TORK AND SHALL ASSUME
  FULL RESPONSIBILITY FOR THE PROPER LOCATION BEFORE PACING CONCRETE.
  - B. PROVIDE FORMED OPENINGS WHERE REQUIRED FOR WORK TO BE EMBEDDED IN AND PASSING THROUGH CONCRETE MEMBERS.
- C. COORDINATE WORK OF OTHER SECTIONS IN FORMING AND SETTING OPENING, SLOTS, RECESSES, CHASES, SLEEVES, BOLTS, ANCHORS, AND OTHER INSERTS. D. INSTALL CONCRETE ACCESSORIES STRAIGHT, LEVEL AND PLUMB.
- REINFORCEMENT PLACEMENT
   A. PLACE REINFORCEMENT, SUPPORTED AND SECURED AGAINST DISPLACEMENT.
  - B. ENSURE REINFORCING IS CLEAN, FREE OF LOOSE SCALE, DIRT, OR OTHER FORFIGN COATINGS
  - WELDING IS PROHIBITED ON REINFORCING STEEL AND EMBEDMENTS. D MINIMUM CONCRETE COVER FOR REINFORCING SHALL BE 3 INCHES UNLESS
- E. CONCRETE COVER FROM TOP OF FOUNDATION TO ENDS OF VERTICAL
- REINFORCEMENT SHALL NOT EXCEED 3 INCHES NOR BE LESS THAN 2 INCHES. 3. PLACING CONCRETE
- B. ALL CONCRETE.

  B. ALL CONCRETE WORK SHALL ADHERE TO THE LATEST A.C.I. STANDARDS FOR WINTER POURING AND CURING PROCEDURES IF SEASONAL CONDITIONS APPLY
- A. AFTER PLACEMENT, PROTECT CONCRETE FROM PREMATURE DRYING. B. MAINTAIN CONCRETE WITH MINIMAL MOISTURE LOSS AT RELATIVELY CONSTANT TEMPERATURE FOR A PERIOD NECESSARY FOR HYDRATION OF CEMENT AND
- ILMP-KRATURE FOR A PERIOD NECESSARY FOR HYDRATION OF CEMENT.

  PROVIDE HAND RUBBED SMOOTH FINISH TO ALL EXPOSED VERTICAL FORMED CONCRETE SURFACES. 6. FIELD QUALITY CONTROL
- A. SUBMIT THREE (3) CONCRETE TEST CYLINDERS TAKEN FOR EVERY 15 CUBIC YARD OR LESS. SUBMIT CONCRETE TESTS TO THE PROJECT MANAGER IN ACCORDANCE WITH ASTM, C-31 AND C-39.
- B. SUBMIT ONE (1) ADDITIONAL TEST CYLINDER TAKEN DURING COLD WEATHER POURS, AND CURED ON JOB SITE UNDER SAME CONDITIONS AS CONCRETE C. SUBMIT ONE (1) SLUMP TEST - TAKEN FOR EACH SET OF TEST CYLINDERS
- D. THE GENERAL CONTRACTOR SHALL BE SOLELY RESPONSIBLE FOR ALL COSTS INCURRED ASSOCIATED WITH CONCRETE TESTING. 7. DEFECTIVE CONCRETE
- MODIFY OR REPLACE CONCRETE NOT CONFORMING TO REQUIRED LINES, DETAILS OR ELEVATIONS AT COST OF GC, AS DIRECTED BY ARCHITECT/ENGINEER.

### DIVISION 5: METALS

### SECTION 05000 - METALS

## PART 1 - GENERAL

- SECTION INCLUDES: STRUCTURAL STEEL FRAMING MEMBERS, BASE PLATES, PLATES, BARS AND GROUTING UNDER BASE PLATES.
- SUDMITTALS:
   SHOP TRAININGS: INDICATE SIZES, SPACING, AND LOCATIONS OF STRUCTURAL MEMBERS, OPENINGS, CONNECTIONS, CAMBERS, LOADS, AND WELDED SECTIONS.
   QUALITY ASSURANCE
- A. FABRICATE STRUCTURAL STEEL MEMBERS IN ACCORDANCE WITH AISC SPECIFICATIONS FOR THE DESIGN, FABRICATION AND ERECTION OF STRUCTURAL STEEL FOR BUILDINGS.

  B. PERFORM DESIGN UNDER DIRECT SUPERVISION OF A PROFESSIONAL
- STRUCTURAL ENGINEER LICENSED IN THE STATE.

### PART 2 - PRODUCTS

### 1. MATERIALS:

- A. STRUCTURAL STEEL MEMBERS: ASTM A572, GRADE 50 B. STRUCTURAL TUBING: ASTM A500, GRADE B ASTM A53, TYPE E OR S, GRADE B D. BOLTS, NUTS, AND WASHERS: ASTM A325 F. ANCHOR BOLTS: ASTM A307
- F. WELDING MATERIALS: AWS D1.1, TYPE REQUIRED FOR
- MATERIALS BEING WELDED NON-SHRINK TYPE, PREMIXED COMPOUND CONSISTING OF NONMETALLIC AGGREGATE, G. GROUT: CEMENT WATER REDUCING AND PLASTICIZING ADDITIVES, CAPABLE OF DEVELOPING A MINIMUM COMPRESSIVE STRENGTH
- OF 7000 psi AT 28 DAYS. H SHOP AND TOUCH-UP PRIMER: SSPC 15 TYPE 1 RED OXIDE
- TOUCH-UP PRIMER FOR GALV. SURFACES:
- ZINC RICH TYPE

- CONTINUOUSLY SEAL JOINTED MEMBERS BY CONTINUOUS WELDS. GRIND EXPOSED
- A. PREPARE STRUCTURAL COMPONENT SURFACES IN ACCORDANCE WITH SSPC SP\_1 TO SP\_10 PROCEDURES
- C. STRUCTURAL STEEL MEMBERS SHALL BE HOT DIPPED GALVANIZED.

### PART 3 - EXECUTION

- 1. EXAMINATION AND PREPARATION:
  - VERIFY THAT THE FIELD CONDITIONS ARE ACCEPTABLE.
- 2. FRECTION: A. ALLOW FOR ERECTION LOADS. PROVIDE TEMPORARY BRACING TO MAINTAIN FRAMING IN ALIGNMENT UNTIL COMPLETION OF ERECTION AND INSTALLATION
- OF PERMANENT BRIDGING AND BRACING.
- B. FIELD WELD COMPONENTS INDICATED ON SHOP DRAWINGS.
  C. DO NOT FIELD CUT OR ALTER STRUCTURAL MEMBERS WITHOUT APPROVAL
- D. AFTER ERECTION, TOUCH-UP WELDS, ABRASIONS, AND SURFACES NOT SHOP PRIMED OR CALVANIZED WITH TOUCH-UP PRIMERS AS SPECIFIED UNDER SECTION 05000, -METALS, PART 2 - PRODUCTS, H & I. SURFACES TO BE IN CONTACT WITH CONCRETE NOT INCLUDED.

4. CONDUIT:

FIELD QUALITY CONTROL: FIELD INSPECTION OF MEMBERS, CONNECTIONS, WELDS AND TORQUING.

### **DIVISION 16: ELECTRICAL**

### SECTION 16050 - BASIC ELECTRICAL MATERIALS AND METHODS

- CONTRACTOR SHALL REWIEW THE CONTRACT DOCUMENTS PRIOR TO ORDERING THE ELECTRICAL EQUIPMENT AND STARTING THE ACTUAL CONSTRUCTION. CONTRACTORS SHALL ISSUE A WRITTEN NOTICE OF ALL FRONDS TO THE ARCHITECT LISTING ANY DISCREPANCESOR CONFLICTING INFORMATION.
   ELECTRICAL PLANS, DETAILS, AND DIAGRAMS ARE DIAGRAMMATIC ONLY. VERIFY EXACT
- LOCATIONS AND MOUNTING HEIGHTS OF ELECTRICAL EQUIPMENT WITH OWNER PRIOR
- TO INSTALLATION.

  3. EACH CONDUCTOR OF EVERY SYSTEM SHALL BE PERMANENTLY TAGGED IN EACH PANELBOARD, PULLBOX, JUNCTION BOX, SWITCH BOX, ET. THE TYPE OF TAGGING METHODS SHALL BE IN COMPANIANCE WITH COUGHDATIONAL SAFETY YAM HEALTH ADMINISTRATION (O.S.H.A.).

  ALL MATERIAS AND EQUIPMENT SHALL BE NEW AND IN GOOD WORKING CONDITION WHEN INSTALLED AND SHALL BE OF THE BEST GRADE AND OF THE SAME HIROUGHOUT FOR EACH CASE OR GROUP OF GUIPMENT. MATERIALS SHALL BE INTERPLICATED. IN THE SAME WERE APPLICABLE MATERIALS SHALL BET WITH APPROVAL OF ALL OVERNING BOODS: HANNON, SINSCIPICINA, MATERIALS SHALL BE MANUFACTURED.

  HINDUSCOUNTS HANNON SINSCIPICINAL SHALL BET WITH APPROVAL OF ALL OVERNING BOODS: HANNON, SINSCIPICINAL SHALL BE MANUFACTURED. HINDUSCOUNTS HAND SHALL BE ADMINISTRATION SHALL BE MANUFACTURED.

  HINDUSCOUNTS HANNON SINSCIPICINAL SHALL BE MEDIAL BE STABLESHED BY ANS, NEW, NEW, NEW AND HANNON SINSCIPICINAL SHALL BE SHALL BE MEDIAL BY AND HANNON SINSCIPICINAL SHALL BE SHALL BE MEDIAL BY AND HANNON SINSCIPICINAL BY AND HANNON SINSCIPICIN
- 5. ALL CONDUIT SHALL HAVE A PULL CORD.
  6. PROVIDE PROJECT MANAGER WITH ONE SET OF COMPLETE ELECTRICAL "AS INSTALLED" DRAWINGS AT THE COMPLETION OF THE JOB, SHOWING ACTUAL DIMENSIONS,
- ROUTINGS, AND CIRCUITS.

  7. ALL CIRCUIT BREAKERS, FUSES AND ELECTRICAL EQUIPMENT SHALL HAVE AN INTERRUPTING SHORT CIRCUIT CURRENT TO WHICH THEY MAY BE SUBJECTED, AND A MINIMUM OF 10,000 A.I.C.
- 8. THE ENTIRE ELECTRICAL INSTALLATION SHALL BE GROUNDED AS REQUIRED BY IBC, NEC AND ALL APPLICABLE CODES.
- 9. PATCH, REPAIR AND PAINT ANY AREA THAT HAS BEEN DAMAGED IN THE COURSE OF THE ELECTRICAL WORK.

  10. PLASTIC PLATES FOR ALL SWITCHES, RECEPTACLES, TELEPHONE AND BLANKED OUTLETS SHALL HAVE ENGRAVED LETTERING WHERE INDICATED ON THE DRAWINGS.
  WEATHERPROOF RECEPTACLES SHALL HAVE SIERRA #WPD-B LIFT COVERS PLATES.

## SECTION 16400 - SERVICE AND DISTRIBUTION

- 1. WIRE AND CABLE CONDUCTORS SHALL BE COPPER, 600V, TYPE TH-IN OR TH-INN, WITH A MIN. 32T OF JIZ AWG, COLOR COOPED. ALL REC'INTER DROP'S SHALL BE STRANGED TO ACCEPT CRAIP CONNECTIORS.

  2. ALL CHEMICAL GROUND RODS SHALL BE "UL" APPROVED.

  3. METER SOCKT AMPERES, VOLTAGE, MUNBER OF PHASES SHALL BE AS NOTED ON THE DRAWNOS. MANUFACTURED BY MILBANK OR APPROVED EQUAL, AND SHALL BE UTILITY COMPANY APPROVED.
- COMUNI: A RIGID CONDUIT SHALL BE U.L. LABEL GALVANIZED ZINC COATED WITH GALVANIZED ZINC INTERIOR AND SHALL BE USED WHEN INSTALLED IN OR UNDER CONCRETE SLABS, IN CONTACT WITH THE EARTH, LUNGER PUBLIC ROUMAN'S, IN MASONRY WALLS OR EXPOSED ON BUILDING EXTERIOR. RIC CONDUIT IN CONTRICT WITH EARTH SHALL BE 1/2 LAPPED WARPED WITH HINTS WRAP PROCESS NO 3
- B. ELECTRICAL METALLIC TUBING SHALL HAVE U.L. LABEL, FITTING SHALL BE GLAND RING COMPRESSION TYPE C. FLEXIBLE METALLIC CONDUIT SHALL HAVE U.L. LISTED LABEL AND MAY BE USED
- WHERE PERMITTED BY CODE FITTINGS SHALL BE "JAKE" OR "SOLIFETE" TYPE ALL FLEXIBLE CONDUITS SHALL HAVE FULL LENGTH GROUND WIRE.

  D. ALL UNDERGROUND CONDUIT SHALL BE AS NOTED ON THE DRAWINGS AT A
- MINIMUM DEPTH OF 42" BELOW GRADE.
- MINIMUM DEPTH OF 42" BELOW GRADE.

  5. CONTRACTOR TO COORDINATE WITH JUILITY COMPANY FOR CONNECTION OF TEUPORARY AND PERMANENT POWER TO THE SITE. THE TEMPORARY POWER AND ALL HOCKUP COSTS ARE TO BE PAID BY THE CONTRACTOR.

  6. ALL ELECTRICAL EQUIPMENT SHALL BE LABELED WITH PERMANENT ENGRAVED PLASTIC.
- LABELS WITH WHITE ON BLUE BACKGROUND LETTERING (MINIMUM LETTER HEIGH SHALL BE 1/4-INCH). NAMEPLATES SHALL BE FASTENED WITH STAINLESS STEEL SCREWS, NOT ADHESIVE
- 7. UPON COMPLETION OF WORK, CONDUCT CONTINUITY, SHORT CIRCUIT, AND FALL POTENTIAL GROUNDING TESTS BY AN INDEPENDENT TESTING SERVICE ENGAGED BY THE CONTRACTOR SHALL BE SUBMITTED FOR APPROVAL. SUBMIT TEST REPORTS TO PROJECT MANAGER. CLEAN PREMISES OF ALL DEBRIS RESULTING FROM WORK AND LEAVE WORK IN A COMPLETE AND UNDAMAGED CONDITION

### 8. GROUNDING ELECTRODE SYSTEM

- A. PREPARATION
  - FREFACTION

    1. SURFACE PREPARATION:
    ALL CONNECTIONS SHALL BE MADE TO BARE METAL. ALL PAINTED

    SURFACES SHALL BE FIELD INSPECTED AND MODIFIED TO ENSURE PROPER

    CONTACT. NO WASHERS ARE ALLOWED BETWEEN THE ITEMS BEING
  - COVINCE. NO WASHERS AND AUDICULED BETWEEN HE TEMS BERNING ROUNDED. ALL CONNECTIONS ARE TO HAVE A NON-OXIDIZING AGENT APPLIED PRIOR TO INSTALLATION.

    2. GROUND BAR FREPARATION.
    ALL COPPER GROUND BARS SHALL BE CLEAVED, POUSHED AND A NON-OXIDIZING AGENT APPLIED. NO FINGERPRINTS OR DISCOLORED
- COPPER WILL BE PERMITTED. 3. SLEEVES: ALL GROUNDING CONDUCTORS SHALL RUN THROUGH PVC SLEEVES
- WHEREVER CONDUCTORS RUN THROUGH WALLS, FLOORS OR CEILINGS. IF CONDUCTORS MUST RUN THROUGH EMT. BOTH ENDS OF CONDUIT SHALL BE GROUNDED. SEAL BOTH ENDS OF CONDUIT WITH SILICONE CAULK.
  B. GROUND BARS
- 1. ALL GROUND BARS SHALL BE 1/4—INCH THICK TINNED COPPER PLATE AND OF SIZE INDICATED ON DRAWINGS.
- 2. ALL CONNECTIONS TO THE GROUND BAR SHALL OBSERVE THE FOLLOWING
- SEQUENCE A ROLT-HEAD

  - A. BULT-HEAD B. 2-HOLE LUG C. TINNED COPPER BUSS BAR D. STAR WASHER E. NUT
- C FYTERNAL CONNECTIONS
- 1. ALL BURIED GROUNDING CONNECTIONS SHALL BE MADE BY THE EXOTHERMIC WELD PROCESS. CONNECTIONS SHALL INCLUDE ALL CABLE TO CABLE, SPLICES, TEE'S, CROSSES, ETC. ALL CABLE TO GROUND RODS, GROUND ROD SPLICES AND LIGHTNING PROTECTION SYSTEMS ARE TO BE AS INDICATED. ALL MATERIALS USED (MOLDS, WELDING METAL, TOOLS, ETC.) SHALL BE BY "CADWELD" AND INSTALLED PER MANUFACTURER'S RECOMMENDED PROCEDURES.
- 2. ALL ABOVE GRADE GROUNDING AND BONDING CONDUCTORS SHALL BE CONNECTED BY TWO HOLE CRIMP TYPE (COMPRESSION) CONNECTIONS (EXCEPT FOR THE ACEG AND GROUND ROD) MECHANICAL CONNECTIONS. FITTINGS OR CONNECTIONS THAT DEPEND SOLELY ON SOLDER SHALL NOT BE USED. ALL CABLE TO CABLE CONNECTIONS SHALL BE HIGH PRESSURE DOUBLE CRIMP TYPE CONNECTIONS. CONNECTIONS TO STRUCTURAL STEEL SHALL BE EXOTHERMIC WELDS.
- D. GROUND RODS ALL GROUND RODS SHALL BE 5/8-INCH DIAMETER X 10'-0" LONG "COPPERWELD" OR APPROVED EQUAL, OF THE NUMBER AND LOCATIONS INDICATED. GROUND RODS SHALL BE DRIVEN FULL LENGTH VERTICAL IN UNDISTURBED FARTH.

### E. GROUND CONDUCTORS

- ALL GROUND CONDUCTORS SHALL BE STANDARD TINNED SOLID BARE COPPER ANNEALED, AND OF SIZE INDICATED ON DRAWINGS UNLESS NOTED OTHERWISE. F HIGS
- 1. LUGS SHALL BE 2-HOLE, LONG BARREL, STRAND COPPER UNLESS OTHERWISE SPECIFIED IN THE CONTRACT DOCUMENTS. LUGS SHALL BE THOMAS AND
- BETTS SERIES #548 BE OR EQUIVALENT A. 535 MCM DLO 54880BE B. 262 MCM DLO 54872B C. #1/0 DLO 54862BE 54866B
- D. #4/0 THWN AND BARE E. #2/0 THWN 54862BE 54207BF
- 2. WHEN THE DIRECTION OF THE CONDUCTOR MUST CHANGE, IT SHALL BE DONE GRADUALLY. THE CURVATURE OF THE TURN SHALL BE DONE IN ACCORDANCE WITH THE FOLLOWING CHART:
- GROUNDING CONDUCTOR SIZE RADIUS TO INSIDE EDGE NO. 6 AWG TO NO. 4 AWG 6 INCHES NO. 2 AWG TO NO. 1/O AWG NO. 2/O AWG TO 4/O MCM 8 INCHES G. GROUND RING TO 750 MCM 24 INCHES
- COUND INNS.

  THE EXTERNAL GROUND RING ENCIRCUNG THE TOWER (IF APPLICABLE) AND
  BETWEN THE EQUIPMENT PAD ANCHORS SHALL BE WIMMUM
  NO. 2 A.W.G. SOLD TINNED BARE COPPER CONDUCTOR IN DIRECT CONTACT
  WITH THE EARTH AT THE DEPTH NDICATED ON THE DRAWNINGS. CONDUCTOR
  BENDS SHALL HAVE, A MINIMUM BEDINGR FADILIS OF EIGHT (8) NOTE.
- 2. ALL EXTERNAL GROUND RINGS ARE TO BE JOINED TOGETHER AND ALL CONNECTIONS MUST BE CADWELDED. NO LUGS OR CLAMPS WILL BE ACCEPTED

- GROUND EACH GATE POST, CORNER POST AND GATE AS INDICATED ON THE DRAWINGS. FENCING WITHIN 6' OF PAD SHOULD BE TIED TO THE GROUND RING AT EVERY OTHER FENCE POST (8') .GROUND CONNECTIONS TO FENCE POSTS AND ALL OTHER CONNECTIONS FOR THE GROUND GRID SYSTEM SHALL BE MADE BY EXOTHERMIC WELD PROCESS, AND INSTALLED PER MANUFACTURER'S RECOMMENDATIONS AND PROCEDURES, AND SPRAYED WITH COLD-GALVANIZED PAINT.
- 9. LE.E.E. FALL POTENTIAL TESTS CONTRACTOR TO CONDUCT GROUND RESISTANCE TEST IN THE FORMAT AS

### A. FOR RAW LAND SITE

'OR RAW LAND SITE

. ROQUID TESTS SHALL BE PERFORMED AS INDICATED ON DRAWINGS.
A BIDDLE GROUND CHIEFE OR THE METHOD OF USING TWO AUXILIARY
GROUND ROOK GO BESCREED IN LEELE STANDARDS NO. 81-1983, A
PART 1) MAY BE USED. THE LEELE METHOD REQUIRES THE USE OF A
C. TEST CURRENT. THE AUXILIARY TEST ROOS MUST BE SUFFICIENTLY
FAR AWAY FROM THE ROO UNDER TEST SO THAT THE REGORDS IN WHICH
HEAR RESSTRACE IS LOCALIZED ON TO VERLEY. THE TEST POINT
WILL BE THE GROUND ROO AND WILL CONSIST OF THE THEE FORT FALL
OF POLIFICIAL MEGORY TEST METHOD, USING THE BIDDLE NULL-BALANCE EARTH TESTER (MEGGER #250220-2 OR EQUIVALENT)

- - TESSIATATE OF 10 UNISO OR LESS UN A DIRT DAT.

    2. SECOND TEST SHALL BE WITH THE FORDING PROS CONNECTED, WITH DRY SOL AND WHEN NO STANDING WATER HAS BEEN PRESENT FOR THE PAST TEN (10) DAYS. THE MAXIOM ALLOWABLE READING IS 5 OHS TO GROUND. IF THE RESISTANCE OF THE ENTIRE SYSTEM EXCEEDS 5 OHMS, NOTIFY THE CONTRACTOR AND OWNERS REPRESENTATIVE SO THAT ADDITIONAL AND/OR DEPER ROOS CAN BE INSTALLED.

  - OMER FIRST T—SHALL BE WITH THREE GROUND ROOS INSTALLED (MINIMUM), EQUALLY SPACED AROUND THE TOWER FOUNDATION, BUT HOT COMNECTED TO THE EQUIPMENT PAD EXTERNAL GROUND RING. FUNNEN HIME TO CONNECT (TEMPORARY CLAMP) ALL THREE GROUND ROOS TOGETHER TO CONNECT (TEMPORARY CLAMP) ALL THREE GROUND ROOS TOGETHER TO ANKE A SYSTEM IETS AFFEE FLORE ROOI IS INDIVIDUALLY TESTED. FOR HIME AND ANKE A SYSTEM IETS AFFEE FLORE ROOI IS INDIVIDUALLY TESTED. FOR HIME AND ANKE A STEMP INTERFERENCE AND ONNER'S REPRESENTATIVE SO THAT THE ROO CAM BE ROWEN DEEPER UNTIL THE ROOI CAM BE ROWEN DEEPER UNTIL
  - DAY.

    SECOND TEST SHALL BE WITH THE GROUND RODS CONNECTED, WITH DRY SOL AND WHEN NO STANDING WATER HAS BEEN PRESENT FOR THE PAST TEN (10) DAYS, THE MAXIMUM, ALUMBLE READING IS 6 HIMLS TO GROUND. IF THE RESISTANCE OF THE ENTIRE SYSTEM EXCEDS 5 OHMS THE ELECTRICAL CONTRACTOR AND OWNERS REPRESENTATIVE SHOULD BE NOTHED SO THAT EITHER ADDITIONAL AND/OR DEEPER RODS CAN BE NOTIFIED SO THAT EITHER ADDITIONAL AND/OR DEEPER RODS CAN BE
- D. FOLIPMENT PAD AND TOWER QUIPMENT PAD AND TOMER

  A FITER THE COUPMENT PAD AND TOMER GROUND RESISTANCE TEST IS

  COMPLETED, CONTRACTOR SHALL TIE EQUIPMENT PAD EXTERNAL GROUND

  RING AND TOMER EXTERNAL GROUND RING TOGETHER. AFTER REST AND

  SECOND TEST ALL CONNECTIONS MUST BE MADE USING EXOTHERMIC WELD.

  IN DIUGS OR CLAMPS WILL BE ACCEPTED.

  A FITER ALL THE EXTERNAL GROUND ENKISS ARE TIED TOGETHER, COMPLETE

  MADMIM ALLOWABLE LEADING IS 5 OHMS TO GROUND.

  THE MADMIM ALLOWABLE LEADING IS 5 OHMS TO GROUND.
- MAXIMUM ALLOWABLE LEADING IS 5 OHMS TO GROUND.

  10. GROUNDING RESISTANCE TEST REPORT
  UPON COMPLETION OF THE TESTING FOR EACH SITE, A TEST REPORT SHOWING
  RESISTANCE, TO HOUSE WITH AUXILIARY POTENTIAL ELECTRODES AT FIVE (5) FEET
  AND TEN (10) FEET INTERVALS UNTIL THE AVERAGE RESISTANCE STARTS
  INGREASING AND ALSO NOTE THAT 10-15 PHOTOS MUST BE TAKEN TO PROOF
  ENTIRE EXTERNAL GROUND RING SYSTEM BEFORE BACKPILL. TWO (2) SETS OF
  TEST BOOLAMINTS ARE OF THE ROEPERIDENT TESTINGS SERVICE TO BE BOUND AND
  SUBMITTED WITHIN ONE (1) WEEK OF WORK COMPLETION.

### SECTION 16503 - POLES, POSTS, AND STANDARDS (SINGLE MAST AND SELF SUPPORTING TOWERS)

- A. LIGHTNING ROD AND EXTENSION PIPE INCLUDING ALL APPURTENANCES, TO BE FURNISHED BY OWNER. IF REQUIRED.
- B. PROVIDE TEMPORARY LIGHTING FOR TOWER AS PER FAA REGULATIONS DURING
- PROVIDE LEMPORARY LIGHTING FUR TUMER AS PER FAM RESOLUTIONS DOMING CONSTRUCTION, IF REQUIRED.
  GROUNDING:
  GROUND TOWER WITH A MINIMUM OF #2 AWS TINNED SOUD BARE COPPER CONDUCTOR CADWELDED TO TOWER BASE PLATE. TWO (2) GROUNDING LEADS PER TOWER BASE PLATE. NO EXOTHERMIC WELDS SHALL BE ATTACHED DIRECTLY TO THE MONOPOLE

## SECTION 16745 - TELECOMMUNICATIONS WIRING COMPONENTS (COAXIAL ANTENNA CABLE)

- E-NEMAL A. ALL MATERIALS, PRODUCTS OR PROCEDURES INCORPORATED INTO WORK SHALL BE NEW AND OF STANDARD COMMERCIAL QUALITY.

  B. CERTAIN MATERIALS AND PRODUCTS WILL BE SUPPLIED BY THE OWNER (REFER TO GENERAL CONDITIONS FOR THE LIST OF OWNER FURNISHED EQUIPMENT, MATERIALS AND SUPPLIES FOR THESE ITEMS). THE CONTRACTOR IS
- RESPONSIBLE FOR PICKUP AND DELIVERY OF ALL SUCH MATERIALS
  C. ALL OTHER MATERIALS AND PRODUCTS SPECIFIED IN THE CONTRACT DOCUMENTS SHALL BE SUPPLIED BY THE CONTRACTOR.

  2. MATERIALS:

## A. COAXIAL CABLE:

TOWER SHAFT

- COAMAL CABLE:

  I. INSTALL COAMAL CABLE AND TERMINATIONS BETWEEN ANTENNAS AND EQUIPMENT PER MANUFACTURERS'S RECOMMENDATIONS WITH COAMAL CABLES SUPPORTED AT NO MORE THAN 3"-0". CO., WEATHERPROOF ALL COMMECTORS BETWEEN THE ANTENNA AND EQUIPMENT PER MANUFACTURERS' REQUIREMENTS. TERMINATE ALL COAMAL CABLE HRREE (5) FEET IN EXCESS OF EQUIPMENT LOCATION UNLESS OFFENIXES STATED.

  2. ALL COAM RIN LENGTHS GREATER THAN 1"5" FEET AND 1"4" FEET SHALL BE 1"-5/8".

  ALL COAM RIN LENGTHS GREATER THAN 1"5" FEET AND 1"4" FEET SHALL BE 1"-5/8".

  ALL COAM RIN LENGTHS GREATER THAN 1"5" FEET AND 1"4" FEET SHALL BE 1"5".

  BENEFIT ON THE PEET SHALL BE 1"5" SHALL BE 1"5".
- 3. Antenna and coaxial cable grounding kits are to be installed on straight runs of coaxial cable grounding kits are to be installed on straight runs of coaxial cable (not within bends)

  4. Coaxial cable dentification
  - A. TO PROVIDE EASY IDENTIFICATION AND UNIFORM MARKING OF ANTENNA CABLING, PLASTIC TAGS SHALL BE USED AT THE
  - FOOTION THAN STREET OF THE COAX NEAREST THE ANTENNA (HERE HE COAXIA CABLE AND JUMPER ARE CONNECTED).

    2. SECOND LOCATION IS INSIDE THE COUPMENT PAD NEAR THE WAVECUIDE ENTRY PORT.
- B. USE ANDREW CABLE TIES (PT.# 27290) TO SECURE IDENTIFICATION TAGS.
- esting Tenant shall provide an independent testing agency to perform Coaxial sweep test & report. The contractor is to provide one climber / Qualified personnel to assist in any repairs and weatherproofing once THE TEST IS COMPLETE. THE CONTRACTOR IS TO PROVIDE VERIZON WIRELESS WITH A MINIMUM OF 48 HOURS NOTICE PRIOR TO THE TIME OF THE SWEEP TEST.







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SITE NAME:

**FULL RELO** SMITH & MAIN **CELL SITE** 

SITE ADDRESS:

IL-64 ST CHARLES, IL 60174

SHEET TITLE: SPECIFICATIONS


A&E PROJECT NO.:

SHEET NO.:

**VZW SP-2** 





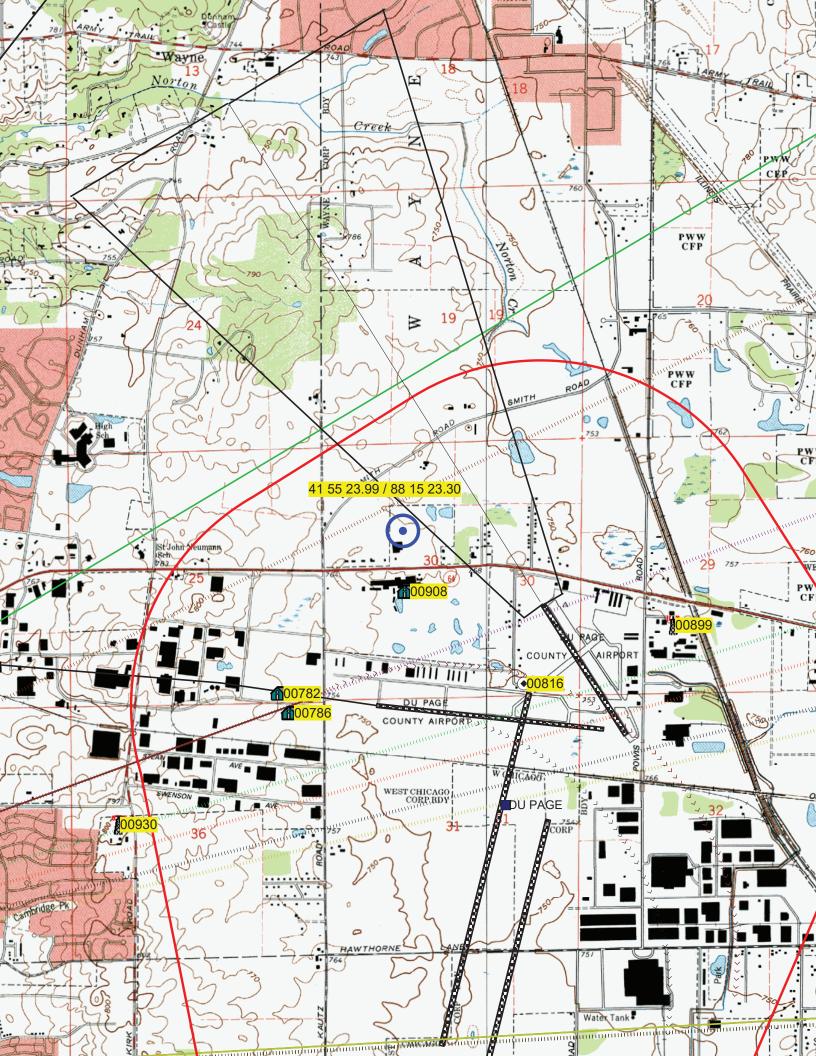



# Airspace Consulting, Inc.

www.airspace-ken.com

Site ID: DuPage October 6, 2022

**Notice to the FAA is Required** 

To Whom It May Concern:

On October 6, 2022, I personally conducted an evaluation of a proposed telecommunications site for Dolan Reality Advisors, LLC. The study was to determine if the proposed structure would create any adverse effect on navigable airspace. The site is located near Chicago, Illinois at 41° 55' 23.99" North and 88° 15' 23.30" West (NAD 83). The site elevation from the topo map is approximately 761' above mean sea level (AMSL). The proposed structure height is 150' above ground level (AGL) or 911' AMSL. Part 77 of the Federal Air Regulations and Part 17 of the FCC Rules and Regulations were used as the primary reference for this evaluation.

The closest public use or DOD runway is Runway 15 at DuPage County Airport. The distance to the runway is 0.54 nautical miles on a true bearing of 297.12° from the runway edge.

The proposed 150' AGL (911' AMSL) structure would exceed FAR Part 77.9 (b) Notice Requirement by 122'. Notice of Proposed Construction or Alteration Form 7460-1 must be filed with the FAA and a favorable FAA determination must be received prior to beginning construction.

The proposed 150' AGL structure would penetrate airspace protected for the VFR traffic pattern. The maximum height the FAA is likely to approve at this site is 148' AGL (909' AMSL). At 909' AMSL the FAA should approve the proposed structure without an extended study. Marking and/or lighting should not be required..

AM broadcast stations and private use landing facilities are not a factor for this site. For additional information or questions about this study, contact my office anytime.

Sincerely,

Ken Patterson