HISTORIC PRESERVATION COMMISSION AGENDA ITEM EXECUTIVE SUMMARY **Agenda Item** COA: 107-109 E Main St. Title/Address: **Proposal: Exterior Renovation Petitioner:** City of St. Charles SINCE 1834 Please check appropriate box (x) **PUBLIC HEARING**

AGENDA ITEM CATEGORY:

X	Certificate of Appropriateness (COA)	Façade Improvement Plan
	Preliminary Review	Landmark/District Designation
	Discussion Item	Commission Business

MEETING

9/5/18

X

ATTACHMENTS:

Application

Agenda Item from Government Services Committee Meeting

Exterior Work Information

Pictures

EXECUTIVE SUMMARY:

The City has purchased the property at 107-109 E. Main St., also known as the former George's Sport Building. In the Fall of 2017, the City hired Schramm Construction to complete interior work on the building.

At the August 27, 2018 Government Services Committee Meeting, the next phase of the project was approved to start moving forward. That next phase includes many exterior renovations, some of the ones proposed are listed below:

North Main St. Elevation:

- Clean and tuckpoint existing masonry wall
- Repair or replace metal roof over windows
- Remove facing above store front windows and install new signboard
- Remove and replace all windows
- Remove two existing doors

South (courtyard) Elevation:

- Remove all windows and doors for replacement
- Remove section of wall for new door
- Remove stairs and build new ramp along the side of adjacent building

RECOMMENDATION / SUGGESTED ACTION:

Provide feedback and recommendations on approval of the COA.

APPLICATION FOR COA REVIEW





COMMUNITY & ECONOMIC	DEVELOPMENT DEPARTMENT / CITY OF ST. CHARLES	(630) 377-4443 ST. CHARLE		
To be filled out by City Sta				
Permit #:	Date Submitted: 8 /30/18 COA#	Admin. Approval:		
APPLICATION INFOR	RMATION			
Address of Property:	107-109 E. MAIN ST. (FORME	E GEOFGE'S SPORT)		
Use of Property:	Commercial, business name:			
	☐ Residential ☐ Other:			
Project Type:				
Exterior Alter Windows Doors Siding - Ty Masonry F Other Awnings/Sigi	New Construction	☐ Demolition ☐ Primary Structure ☐ Garage/Outbuilding ☐ Other ☐ Relocation of Building		
Description:				
Applicant Information Name (print):	CITY OF ST. CHARLES	Applicant is (check all that apply):		
Address:	Z E. MAIN ST.	➤ Property Owner		
Phone:	630.377.4916	☐ Business Tenant ☐ Project contractor		
Email:	PSUMP @ STCHAPLESIL . GOV	☐ Architect/Designer		
Property Owner Inform	mation (if not the Applicant)			
Name (print):				
Address:				
Signature:				
APPLICANT/AUTHORIZE	ED AGENT SIGNATURE			
I have read and under	hall be in accordance with the plans, specifications and cond restand the Historic Preservation COA General Conditions.			
Signature:	TER SUHP, DIRECTOR OF PUBLIC	30/2018 WORKS		

AGENDA ITEM FROM 8/27/18 GOVERNMENT SERVICES COMMITTEE MEETING

	AGEND	A ITEM EXECUTIVE SUMMARY Agenda Item number: 4.d						
ST. CHARLES SINCE 1834	Title:	Recommendation to Approve Agreement for Design, Construction Documents and Construction Services for the Renovation to City Owned Building at 107-109 East Main Street (Former George's Sport) to Schramm Construction						
	Presenter:	Peter Suhr						
Meeting: Governn	nent Services	Committee Date: August 27, 2018						
Proposed Cost: \$4	4,350	Budgeted Amount: \$900,000 Not Budgeted:						
Executive Summa	ary (if not bu	dgeted please explain):						
in 2012 with intent to building was in fair of Department is response. Recognizing the con	o utilize the be condition, how nsible for the outinued deterio	107-109 Main Street otherwise known as the former George's Sport Building milding or land as a compliment to the adjacent Arcada Theatre. In 2012, the vever has slowly continued to deteriorate over time. The Public Works care and maintenance of City owned buildings including George's Sport. Trating conditions of the building, Public Works recently retained Schramm ded demolition work on the interior of the building and roof replacement in						
the Fall of 2017.	orm mach nec	ded demontion work on the interior of the building and roof replacement in						
preparation for a pot their consulting arch identified in the attac for continued exterior mechanical, electrical	ential tenant of itect, Paul Lar ched proposal or improvemental, plumbing a	ight, the focus is on providing continued improvements to the building in adaptive reuse of the space. Working with staff, Schramm Construction and akenau, have prepared the next appropriate scope of work to be considered as In general, the work proposed includes design and construction documents at and interior buildout of "white box" spaces including structural, and fire protection upgrades. The proposed work also includes continued interior of the building which is needed to assess the structural components of						
	oject costs for	are complete this Fall, the City will be in a position to bid and construct the construction is preliminary estimated between \$800,000 - \$950,000 and will idding.						
Attachments (plea	ase list):							
*Schramm Constru	action Propos	al						
Recommendation	/Suggested A	Action (briefly explain):						
	enovation to	greement for Design, Construction Documents and Construction City Owned Building at 107-109 East Main Street (Former George's						

PHASE 1 ALTERATIONS TO 107-109 E. MAIN STREET ST. CHARLES, ILLINOIS

PROJECT JURISDICTION, ZONING AND USES: ZONING JURISDICTION - CITY OF ST CHARLES, ILLINOIS ZONING CLASSIFICATION - CBD-1 CENTRAL BUSINESS DISTRICT USE: S-1 (MODERATE HAZARD STORAGE) BASEMENT A-2 (ASSEMBLY) FIRST FLOOR B (BUSINESS) SECOND FLOOR

BUILDING CODES, ORDINANCES AND REGULATIONS: ILLINOIS ENERGY CONSERVATION CODE - USING IECC 2015 (INTERNATIONAL ENERGY CONSERVATION CODE) WITH STATE OF ILLINOIS AMENDMENTS 2015 IEBC (INTERNATIONAL EXISTING BUILDING CODE) 2015 IBC (INTERNATIONAL BUILDING CODE)

2015 INTERNATIONAL MECHANICAL CODE 2015 INTERNATIONAL FUEL GAS CODE 2014 NATIONAL ELECTRIC CODE NFPA 70 2014 STATE OF ILLINOIS PLUMBING CODE 2015 INTERNATIONAL FIRE CODE 1997 ILLINOIS ACCESSIBILITY CODE

NFPA 101 LIFE SAFETY CODE LOCAL REGULATIONS AND AMENDMENTS TO ALL CODES CLIMATIC AND GEOGRAPHIC DESIGN CRITERIA:

WIND LOAD = 25 PSF SEISMIC DESIGN CATAGORY = B CONCRETE SUBJECT TO: SEVERE WEATHERING FROST LINE DEPTH = 42" OUTDOOR WINTER DESIGN TEMPERATURE = -5° F

AIR FREEZING INDEX: 2,000

TRIM INFILL AT

DOORS TYP

CONC MALL

GRADE

(COURTYARD) ELEVATION

MEAN ANNUAL TEMPERATURE: 48.5° F

PENETRATING RATED CONSTRUCTION

GROUND SNOW LOAD = 30 PSF (POUNDS PER SQ FT)

FIRE RATINGS AND SEPARATION DESIGN CRITERIA: 1. EXISTING EXTERIOR FIRE RATINGS TO REMAIN - NOT DETERMINED 2. INTERIOR FLOOR AND WALL CONSTRUCTION TO PROVIDE

1 HR MIN RATING PLUS SMOKE BARRIERS AT THE FOLLOWING A. BETWEEN ALL TENANTS B. BETWEEN FIRST AND SECOND FLOOR USES (A-2 TO B)

(NOT REQ'D BASEMENT TO 1ST FLOOR - SAME TENANT) C. STAIRWAY ENCLOSURES D. CORRIDOR WALLS PER CITY AMENDMENT (MAY INCLUDE GLASS) E. ALL MECHANICAL/PLUMBING SHAFTS 3. CONTRACTOR TO FIRESTOP AND FIRE CAULK ALL OPENINGS

FIRE SPRINKLERS / FIRE PROTECTION / DRAFTSTOPPING: I. CONTRACTOR TO DESIGN AND PROVIDE AUTOMATIC FIRE PROTECTION PER NFPA 13 AS REQUIRED BY THE LOCAL JURISDICTION, INCLUDING A NEW MATER SERVICE WITH BACK-FLOW PREVENTER.

2. DRAFTSTOPPING SHALL BE PROVIDED AS REQUIRED IN FLOOR CONSTRUCTION WHEN THE CEILING IS SUSPENDED BELOW THE JOISTS, OR CONSTRUCTED OF OPEN WEB JOISTS. DRAFTSTOPPING SHALL DIVIDE THE FLOOR AREA INTO 1,000 SQ FT MAXIMUM AREAS AND SHALL USE APPROVED MATERIALS SUCH AS 1/2" GYPSUM BOARD AND SEALANT.

3. FIRESTOPPING SHALL BE PROVIDED AS REQUIRED TO CUT OFF CONCEALED DRAFT OPENINGS (HORIZ AND VERT), BETWEEN STORIES, AND TOP STORY AND ROOF BY FIRESTOPPING WITH APPROVED MATERIALS AT CEILINGS, FLOORS, SOFFITS, DROP CEILINGS, STAIRS, PIPES AND OTHER OPENINGS. HORIZONTAL CAVITIES 10 FEET OR WIDER SHALL BE FIRESTOPPED.

CONSTRUCTION TYPE: EXISTING CONSTRUCTION TYPE IIIB

(2 HR RATED EXT BEARING WALLS, NO RATING REQ'D ON FLOORS, ROOF OR INTERIOR BEARING ELEMENTS EXCEPT AS REQ'D FOR FIRE SEPARATION LISTED SEPARATELY) NON-COMBUSTIBLE EXTERIOR WALLS / INTERIOR ELEMENTS, FLOORS AND ROOF OF ANY PERMITTED MATERIAL EXISTING PARTY WALL FIRE RATING TO REMAIN

STRUCTURAL DESIGN LOADS - RISK CATAGORY III: EXISTING FLOORS TO BE UPGRADED DUE TO NEW USES USE A-2 FLOORS INCL ENTRY VESTIBULE = 100 PSF LL + DL USE B FLOORS = 50 PSF LL + DL

STAIRS = 100 PSF LL + DL ROOF - EXISTING CAPACITY UNDETERMINED WIND LOAD FOR NEW EXTERIOR WALLS/GLAZING ONLY = 25 PSF GUARDRAILS AND HANDRAILS = 50 LB PER LIN FT MIN AND 200 LB LOAD IN ANY DIRECTION AND AT ANY POINT ALONG THE TOP (50 LB POINT LOAD ON INFILL COMPONENTS)

STRUCTURAL MATERIALS: ALL VALUES ARE THE MINIMUM REQUIRED

USE B CORRIDORS = 80 PSF LL + DL

FLOOR/CEILING JOISTS, HEADERS, RAFTERS: CANADIAN SPF #1/#2: E = 1.4 MILLION PSI / FV = 135 PSI Fb = 875 PSI BASE (1,006 PSI REPETITIVE MEMBERS) STUDS: (REPETITIVE MEMBERS)

CANADIAN SPF STUD GRADE: E=1.2 MILLION PSI Fb=675 PSI / Fv=135 PSI / Fc=725 PSI (WITH GRAIN) US SOUTHERN PINE STUD GRADE: E=1.4 MILLION PSI Fb=750 PSI / Fv=175 PSI / Fc=925 PSI (WITH GRAIN) MANUFACTURED MATERIAL: WEYERHAEUSER I-LEVEL OR ARCHITECT APPROVED EQUAL (FOLLOW ALL MANUFACTURER'S INSTRUCTIONS)

LVL BEAMS (INT) PSL BEAMS (INT) Fb=2,900 PSI Fb=2,400 PSI Fv=290 PSI Fv=190 PSI Fc=750 PSI Fc=750 PSI Fc=425 PSI E=2.0 MILLION PSI E=2.0 MILLION PSI E=1.9 MILLION PSI

CONCRETE: 3,000 PSI FOUNDATIONS AND INTERIOR FLATWORK 4,000 PSI EXTERIOR FLATWORK (AIR ENTRAINED FROM 5% TO 7%) SOILS: DESIGN BASED ON 1,500 PSF MINIMUM BEARING

<u>ENERGY CODE REGULATIONS AND RATINGS REQUIRED:</u> I. THESE PLANS HAVE BEEN PREPARED TO MEET OR EXCEED THE ENVELOPE REQUIREMENTS OF THE 2015 IECC AS REQUIRED BY THE STATE OF ILLINOIS PRESCRIPTIVE REQUIREMENTS. 2. MINIMUM PRESCRIPTIVE INSULATION R-VALUES ROOF AND WALLS: EXISTING TO REMAIN

3. NEW WINDOWS MAXIMUM U-FACTOR 0.45 AND SHGC OF 0.40 4. NEW ENTRY DOORS MAXIMUM U-FACTOR 0.77 AND SHGC 0.40 5. CONTRACTOR TO INSTALL A PERMANENT ENERGY CERTIFICATE VERIFYING THE INSTALLED RATINGS, ETC ON THE ELECTRIC DISTRIBUTION PANEL

. DO NOTE SCALE DRAWINGS. USE DIMENSIONS LISTED OR CLARIFY WITH ARCHITECT IF FIELD DIMENSIONS DIFFER.


- 2. NOTIFY ARCHITECT OF ANY DIMENSIONAL DISCREPANCIES OR CONFLICTING INFORMATION ON DRAWINGS AT ONCE FOR
- 3. CONTRACTOR SHALL BE RESPONSIBLE FOR ALL MEANS AND METHODS OF CONSTRUCTION, AND ALL SAFETY MEASURES REQUIRED BY OSHA OR OTHER GOVERNING AGENCIES.
- 4. FOR WINDOWS WHOSE SILL IS MORE THAN 72" ABOVE FINISHED GRADE OR A SURFACE BELOW, THE LOWEST PART OF THE OPENING SHALL BE 36" MINIMUM ABOVE THE ROOM FLOOR LINE OR IT SHALL HAVE A FALL PROTECTION DEVICE OR OPENING LIMITED TO 4" MAXIMUM.
- 5. GLAZING SHALL COMPLY WITH IBC CODE CHAPTER 24 INCLUDING SAFETY GLASS IN ANY DOOR AND WITHIN 24" OF A DOOR (IF THE BOTTOM EDGE IS 60" OR LESS ABOVE THE FLOOR); AT STAIRWAYS AND RAILINGS; AND IN ANY AREA REQUIRED BY THE CODE EVEN IF NOT SPECIFICALLY NOTED OR SHOWN ON DRAWINGS
- 6. STAIRWAYS SHALL COMPLY WITH IBC CODE CHAPTER 10 WITH A MAXIMUM RISER HEIGHT OF 7" AND A MINIMUM TREAD DEPTH OF 11" PLUS A NOSING OF 3/4" TO 1 1/4". TREADS WITH NO NOSING SHALL BE A MINIMUM DEPTH OF 12". HEADROOM ABOVE A STAIR SHALL NOT BE LESS THAN 6'-8" MEASURED VERTICALLY FROM THE NOSINGS OR LANDING.
- 7. RAMPS SHALL COMPLY WITH IBC CODE SECTION 1012 WITH A MAXIMUM SLOPE OF 1" IN 12" AND MAXIMUM RISE OF 30".
- 8. HANDRAILS SHALL COMPLY WITH IBC CODE SECTION 1014 AND SHALL BE PROVIDED ON BOTH SIDE OF ALL STAIRS AND RAMPS, SHALL BE CONTINUOUS THE ENTIRE RUN AND LOCATED AT A HEIGHT OF 34" TO 38", SHALL EXTEND 12" SLOPING BEYOND THE BOTTOM RISER AND LEVEL FOR 12" BEYOND THE UPPER RISER, AND SHALL INCLUDE RETURNS TO THE WALLS. HANDRAILS SHALL HAVE A DIAMETER OF 1 1/4" TO 2", AND CLEARANCE TO THE WALL OF 1 1/2" MIN.
- 9. GUARD RAILS SHALL COMPLY WITH IBC CODE SECTION 1015 AND SHALL BE PROVIDED ON ALL WALKING SURFACES MORE THAN 30" ABOVE THE GRADE OR OTHER FLOOR, INCLUDING AT THE OPEN SIDES OF STAIRS AND RAMPS. GUARD RAILS SHALL NOT BE LESS THAN 42" TALL, AND SHALL NOT ALLOW PASSAGE OF A 4" SPHERE.
- 10. CONTRACTOR TO PROVIDE ADDRESS NUMBERS ACCEPTABLE TO THE JURISDICTION.

DRAWING SHEET LIST A1.1 COVER SHEET & EXTERIOR ELEVATIONS A2.1 DEMOLITION PLANS A3.1 FOUNDATION AND BASEMENT PLAN A4.1 FIRST AND SECOND FLOOR PLANS A5.1 SECTIONS AND DETAILS


ADJACENT BUILDING BEYOND 3'-6" MIN HT MTL -GUARDRAIL #5 BARS 12" LONG 12" *OC* EMBED INTO EXIST WALL 6" W EPOXY

42" HIGH MIN 1 1/4" STD PIPE (1.7" OD) TOP RAIL 4" MAX OPNG 3/4" SQ STL VERTICAL INFILL M 4" SPACE BETWN MAX 1" TOP AND BOTT RAILS OF INFILL PNLS COPE AND WELD TO POSTS - 4" MAX OPNG 1 1/4" STD PIPE (1.7" OD) POSTS EQUALLY SPACED WELD AND GRIND ALL JNTS ON RAIL LENGTH AND 4'-3" FINISH W EPOXY BASED OC MAX W SOLID BAR IN

BOTTOM 8" OF PIPE AND EMBEDDED INTO CONC 5'

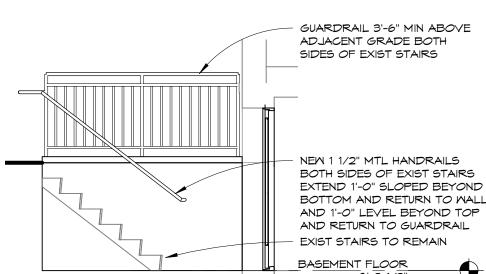

3 COURTYARD RAMP ELEVATION

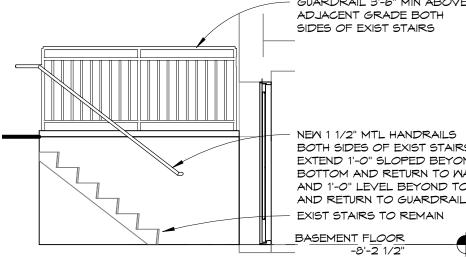

ISSUED FOR DESIGN REVIEW

These plans were drawn by me or under my direct supervision, and to the best of my knowledge comply with all applicable building codes listed (seal must be affixed for permit)

license expires 11/30/2018

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REVISION SCHEDULE DATE DESCRIPTION

8/29/2018 SSUE DATE DRAWN BY HECKED BY 18011 ROJECT NUMBER

COVER SHEET & EXTERIOR ELEVATIONS



ARCHITECTURE P.C.

Creative designs that endure
1121 CHESHIRE AVENUE
NAPERVILLE, ILLINOIS 60540
630-202-8261

PHASE 1 BUILDING ALTERATIONS AT
107-109 E. MAIN STREET ST. CHARLES,
OWNER - THE CITY OFIST. CHARLES, ILLINOIS
CONTRACTOR - SCHRAMM CONSTRUCTION CORP
520 SMENSON AVE, ST. CHARLES ILLINOIS 60114

These plans were drawn by me or under my direct supervision,

and to the best of my knowledge comply with all applicable building codes listed (seal must be affixed for permit)

signed______license expires 11/30/2018
drawings _______
dated ______
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REVISION SCHEDULE

ID DATE DESCRIPTION

ISSUE DATE 8/29/2018


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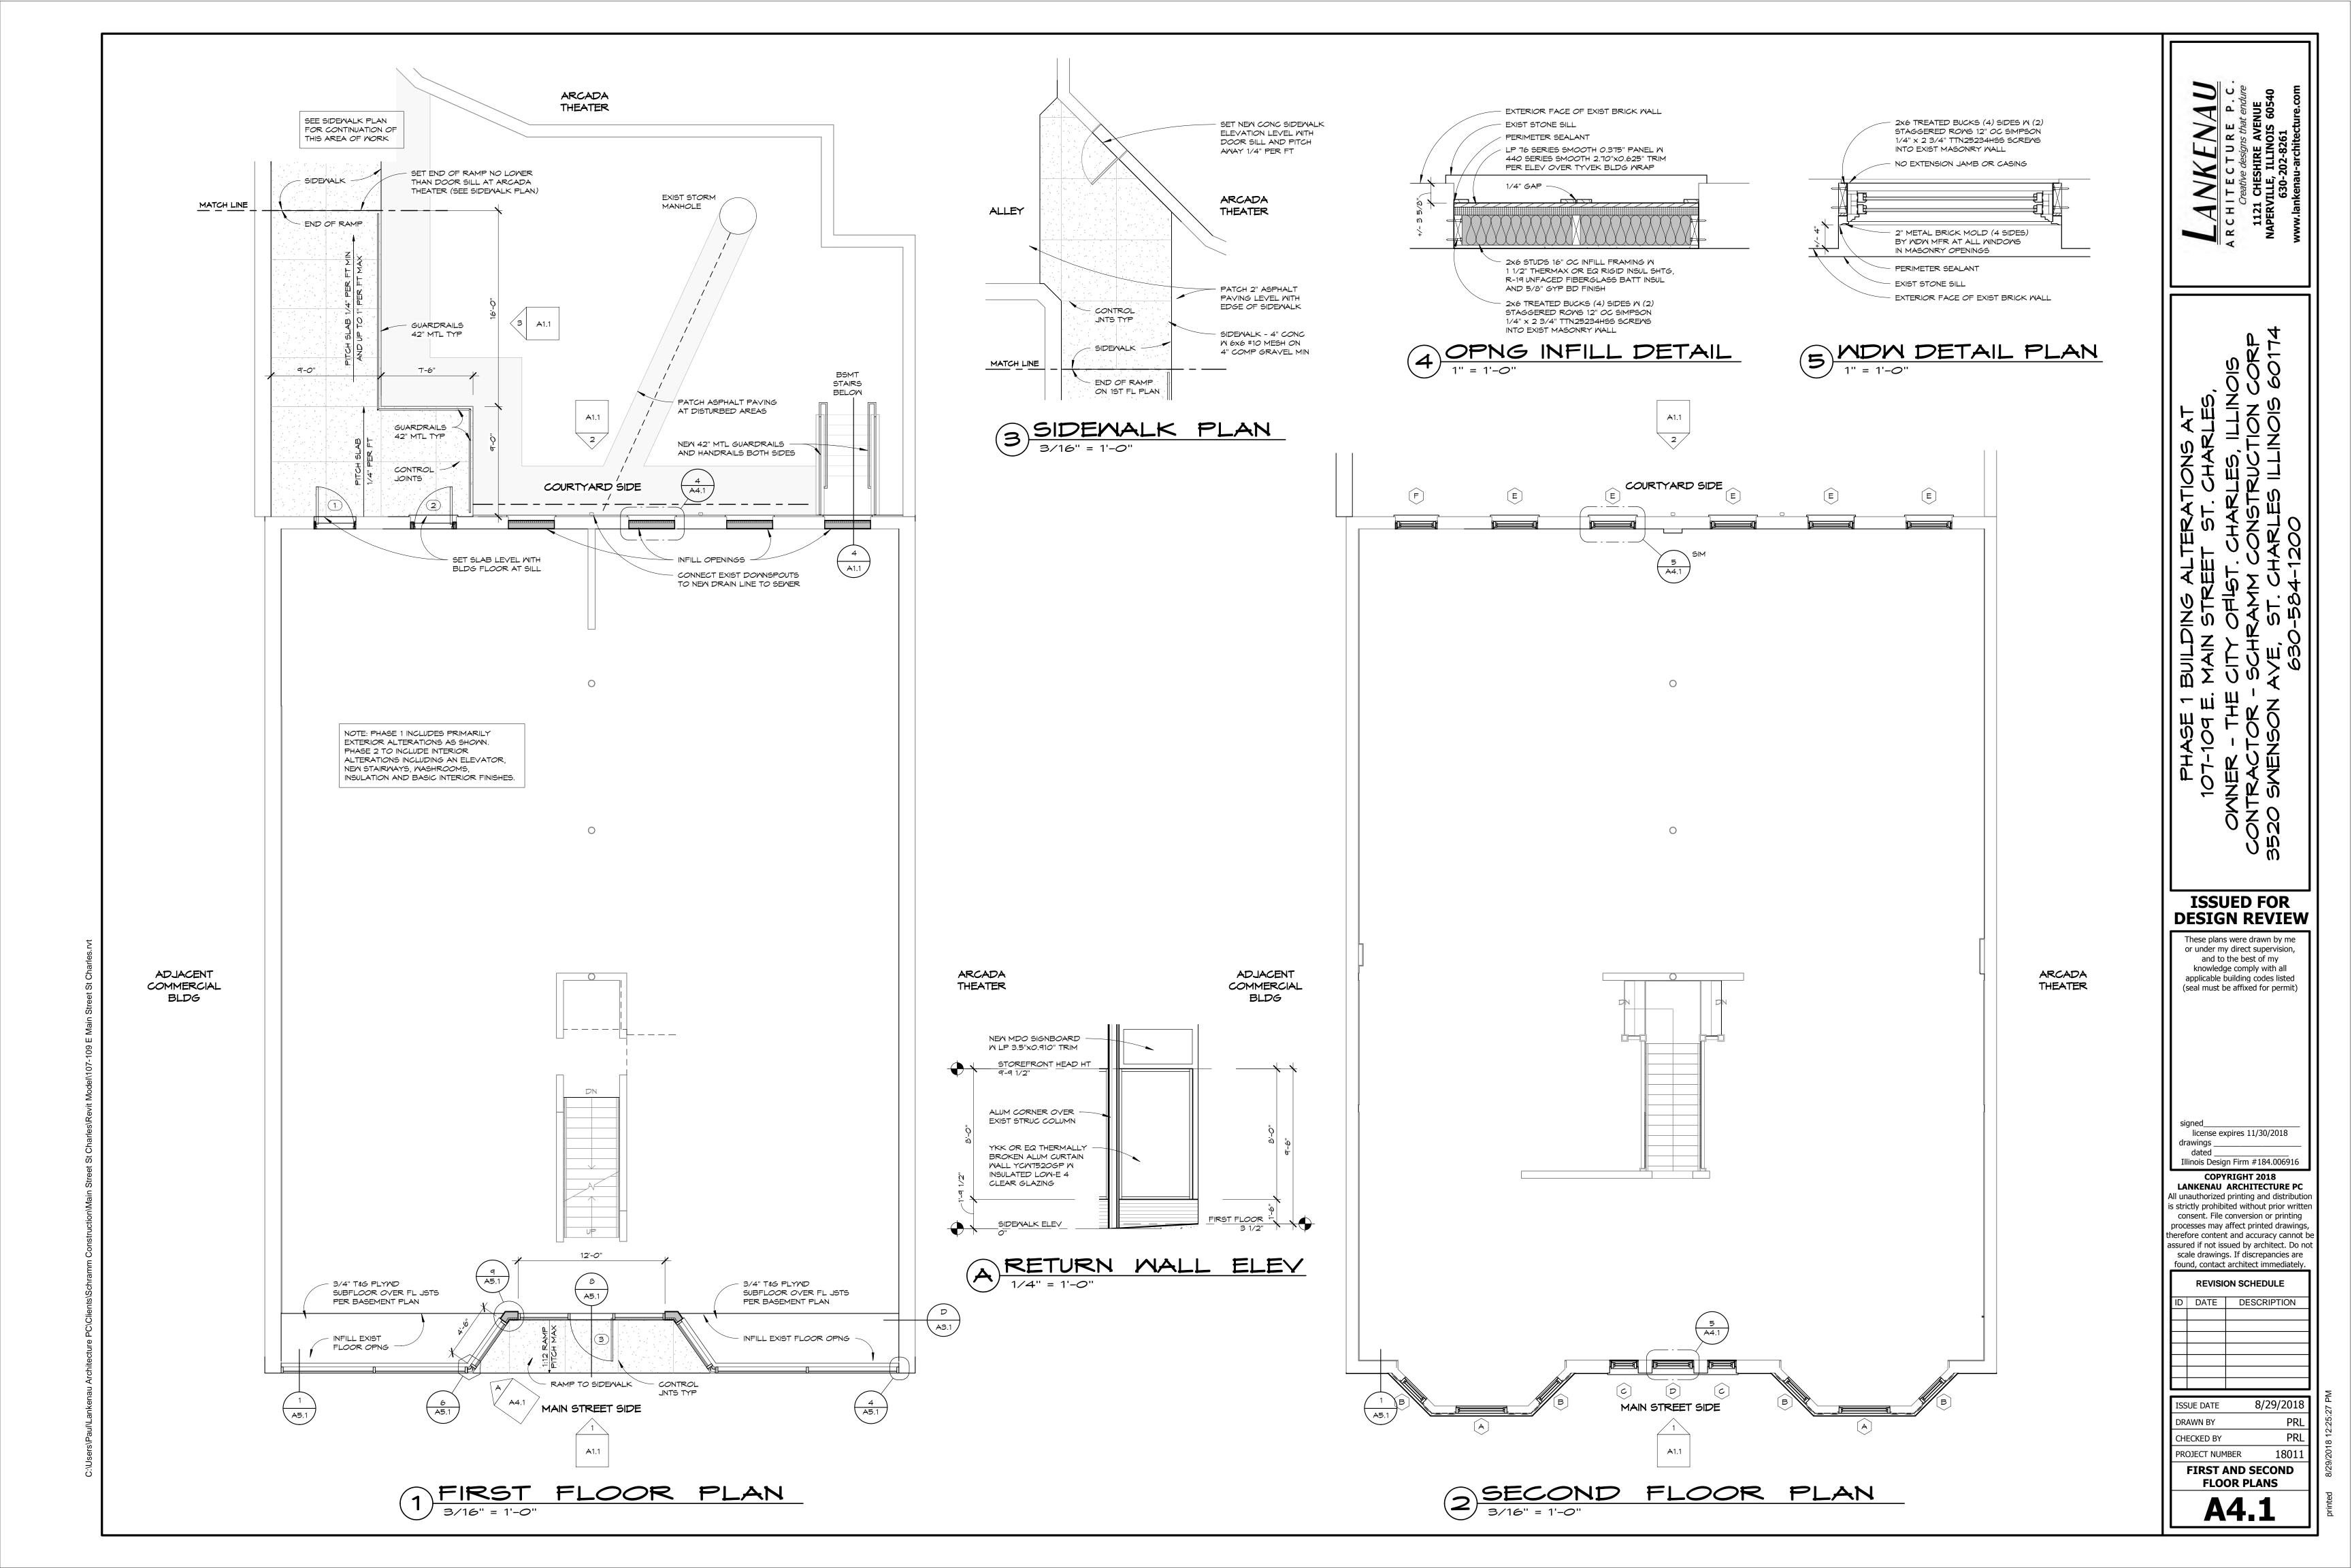
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PROJECT NUMBER 18011

DEMOLITION PLANS


A2.1




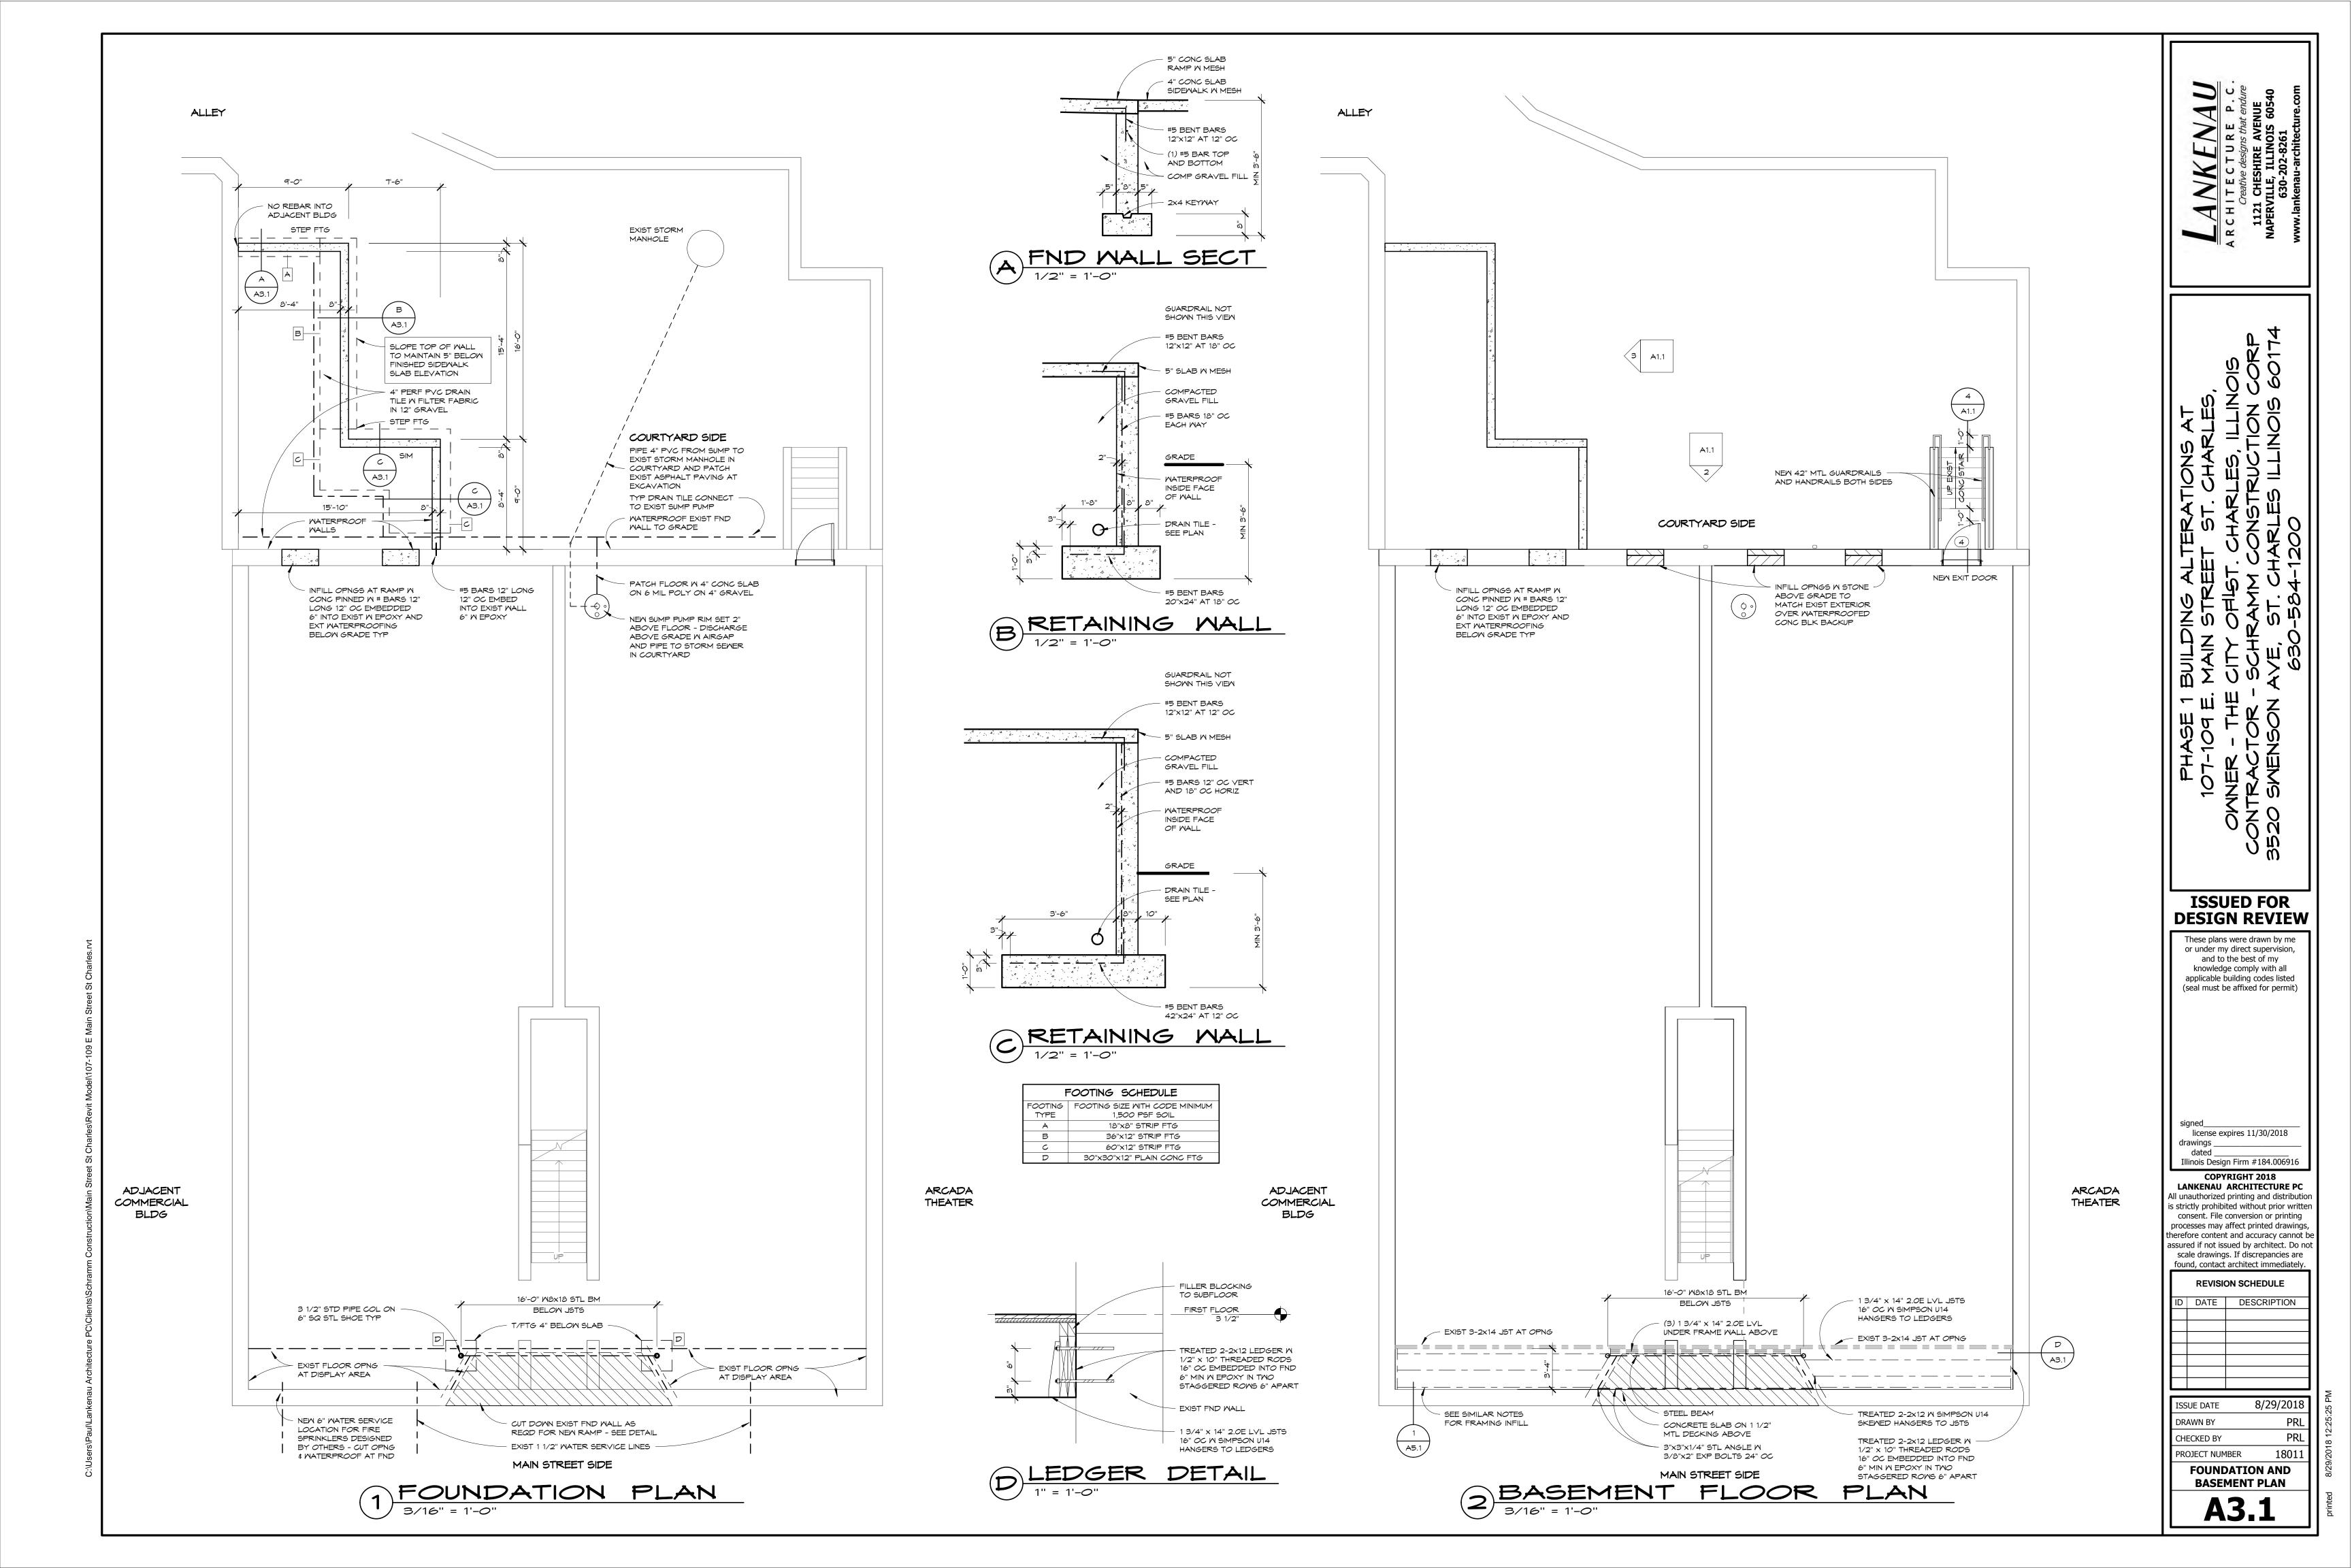

	MINDOM SCHEDULE							
	< TYPE	MANUFACTURER	MODEL	SIZE		BRK MLD	GLAZING	
MARK				MIDTH	HEIGHT	2" OGEE	TYPE	COMMENTS
A	ALUM CLAD MD	ANDERSEN	E SERIES DH	4'-2"	6'-8"		LOW E4 INSUL	4" MAX LIMITED OPNG BOTT SASH
В	ALUM CLAD MD	ANDERSEN	E SERIES DH	2'-6"	6'-8"		LOW E4 INSUL	4" MAX LIMITED OPNG BOTT SASH
C	ALUM CLAD MD	ANDERSEN	E SERIES DH	2'-0 3/4"	6'-5 3/4"	Yes	LOW E4 INSUL	4" MAX LIMITED OPNG BOTT SASH
D	ALUM CLAD MD	ANDERSEN	E SERIES DH	3'-1 3/4"	6'-5 3/4"	Yes	LOW E4 INSUL	4" MAX LIMITED OPNG BOTT SASH
E	ALUM CLAD MD	ANDERSEN	E SERIES DH	3'-5 3/4"	5'-9 3/4"	Yes	LOW E4 INSUL	4" MAX LIMITED OPNG BOTT SASH
F	ALUM CLAD MD	ANDERSEN	E SERIES DH	3'-1 3/4"	5'-9 3/4"	Yes	LOW E4 INSUL	TEMP GLASS
G	ALUM CLAD MD	ANDERSEN	E-SERIES FIXED	3'-2 1/2"	1'-10"		LOW E4 INSUL	TEMP GLASS

MINDOM SUPPLIER AND CONTRACTOR TO FIELD MEASURE AND VERIFY EACH MINDOM MITH EXISTING OPENINGS PRIOR TO ORDERING

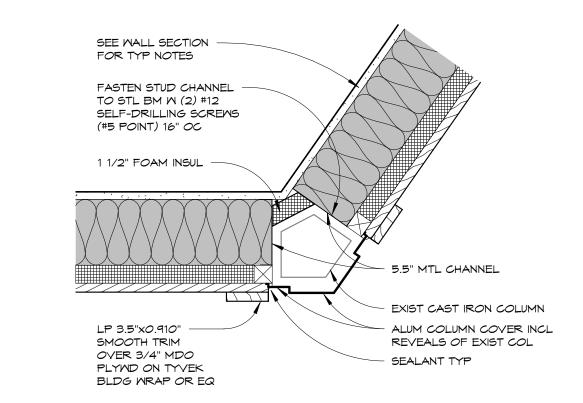

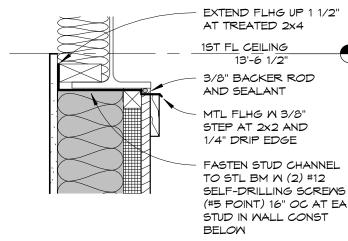

2 DETAIL AT BEAM
1 1/2" = 1'-0"

R-21 MIN CLOSED CELL INSUL FOAMED-IN-PLACE AT EXIST STL BM


THROUGH-WALL FLHG AND SEALANT

13'-6 1/2"


LP 3.5"x0.910" SMOOTH TRIM OVER 3/4" MDO PLYMD ON

TYVEK BLDG WRAP OR EQ




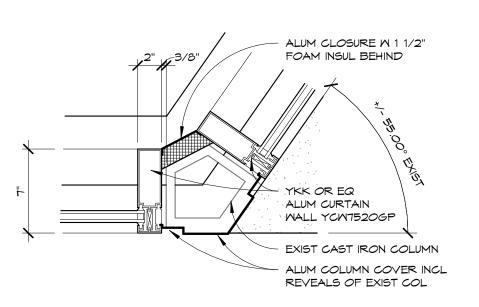


COLUMN DETAIL

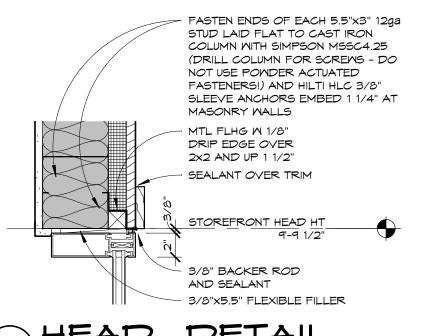




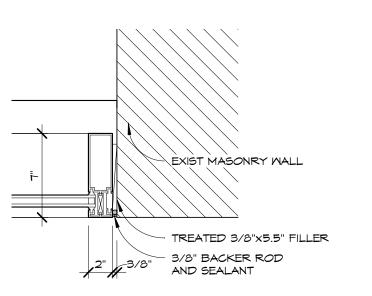




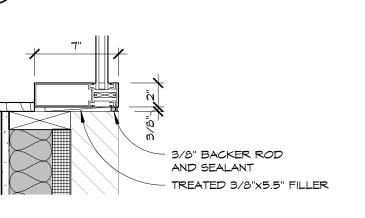


3 SILL DETAIL
1 1/2" = 1'-0"

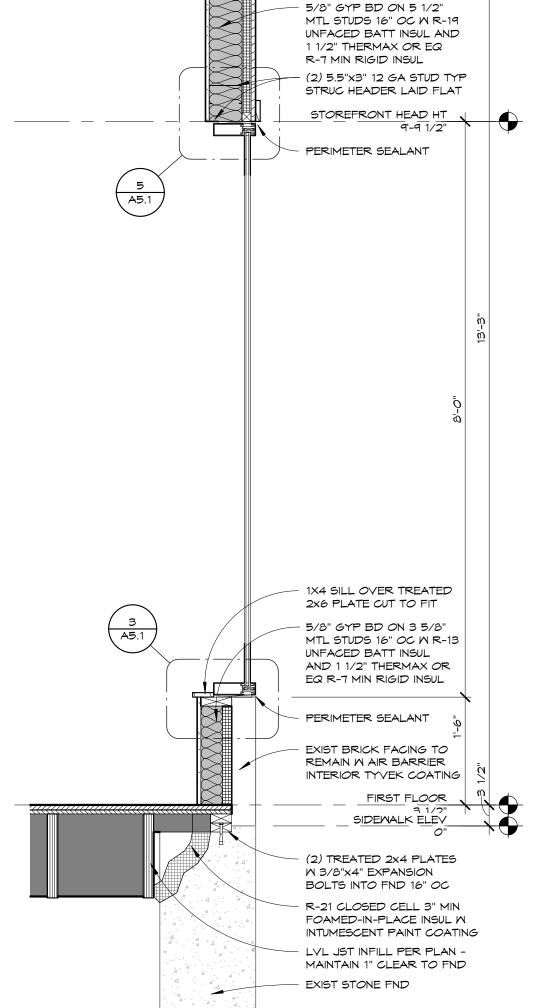

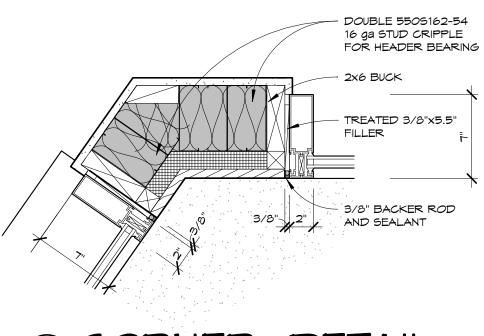



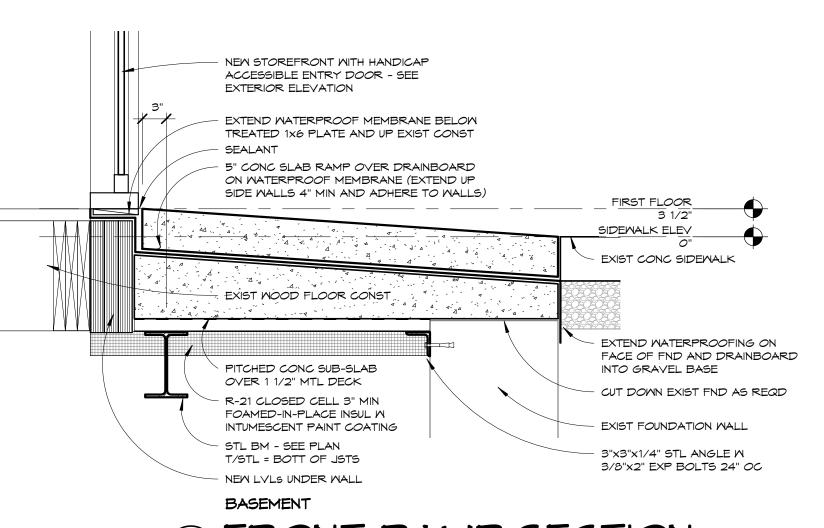

8 FRONT RAMP SECTION

1 FRONT WALL SECTION

PRL PRL

D DATE DESCRIPTION

ISSUED FOR

DESIGN REVIEW

These plans were drawn by me or under my direct supervision,

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drawings .

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PROJECT NUMBER

DETAILS

A5.1

8/29/2018 18011 **SECTIONS AND**





