	AGEND	A IT	EM EXECUTIVE SUMMARY	Agenda Item number: IIC4		
ST. CHARLES SINCE 1834	Title:	Mo Maj Dev	Motion to approve an Ordinance Granting Approval of a Map Amendment, Special Use for Planned Unit Development, and PUD Preliminary Plan for Pride of Kane County.			
	Presenter:	Rita	Rita Tungare			
Meeting: City Cou	ıncil	Da	te: December 7, 2020			
Proposed Cost: N/	A		Budgeted Amount: N/A	Not Budgeted:		
<b>Executive Summa</b>	ry (if not bu	dgete	d please explain):			
The attached ordina County project: Ma Development, and Con November 9, 20	ance will appropriate Amendment PUD Prelimit D20 the Plant roject (Map failed to pass	oroved on to inary ining & American a	the zoning and subdivision applicate the BR- Regional Business District Plan.  Development Committee voted orderent, Special Use for PUD and P4-5 vote.	tions for the Pride of Kane :; Special Use for Planned Unit n the zoning applications		
Attachments (plea	,					
Ordinance Approvi						
Recommendation	Suggested A	Action	n (briefly explain):			

Motion to approve an Ordinance Granting Approval of a Map Amendment, Special Use for Planned Unit Development, and PUD Preliminary Plan for Pride of Kane County.

## City of St. Charles, Illinois Ordinance No. 2020-Z-

## An Ordinance Granting Approval of a Map Amendment, Special Use for Planned Unit Development and PUD Preliminary Plan for Pride of Kane County

WHEREAS, on or about April 7, 2020, CIMA Developers, LP (the "Applicant") filed petitions for: 1) Map Amendment from RE-1 Single-Family Estate District to BR Regional Business District; 2) Special Use for Planned Unit Development; and 3) PUD Preliminary Plan, all for the real estate legally described on Exhibit "A" attached hereto and incorporated herein (the "Subject Property"), for the purpose of developing a gas fueling facility, convenience store, and car wash; and,

WHEREAS, Notice of Public Hearing on said petitions for Map Amendment and Special Use for Planned Unit Development was published on or about June 18, 2020 in a newspaper having general circulation within the City, to-wit, the Daily Herald newspaper, as required by the statutes of the State of Illinois and the ordinances of the City; and,

WHEREAS, pursuant to said Notice, the Plan Commission conducted a public hearing on or about July 7, 2020, July 21, 2020 and August 4, 2020 on said petitions in accordance with the statutes of the State of Illinois and the ordinances of the City; and,

WHEREAS, at said Public Hearing, the Applicant presented testimony in support of said petitions and all interested parties had an opportunity to be heard; and,

WHEREAS, the Plan Commission recommended approval of said Map Amendment, Special Use for Planned Unit Development and PUD Preliminary Plan petitions on or about August 4, 2020; and,

WHEREAS, the Planning & Development Committee of the City Council reviewed said petitions on or about August 10, 2020 and September 14, 2020, and, on or about November 9, 2020, voted on a motion to recommend approval of said petitions, and said motion to recommend approval failed; and,

WHEREAS, the City Council of the City of St. Charles has received the recommendations of the Plan Commission and Planning & Development Committee and has considered the same.

NOW, THEREFORE, BE IT ORDAINED BY THE CITY COUNCIL OF THE CITY OF ST. CHARLES, KANE AND DUPAGE COUNTIES, ILLINOIS, as follows:

1. The preambles set forth hereinabove are incorporated herein as substantive provisions of this Ordinance as though fully set out in this Section 1.

- 2. That passage of this Ordinance shall constitute approval of the petition for a Map Amendment for the Subject Property from the RE-1 Single-Family Estate District to the BR Regional Business District, and the Findings of Fact for Map Amendment attached hereto and incorporated herein as Exhibit "B" are expressly adopted by the corporate authorities of the City.
- 3. That passage of this Ordinance shall constitute approval of a Special Use for Planned Unit Development pursuant to the provisions of Title 17 of the St. Charles Municipal Code, as amended, and based upon the Applicant's petitions and the evidence presented at the Public Hearing, the City Council hereby finds that the Special Use for Planned Unit Development is in the public interest and adopts the Criteria for Planned Unit Developments, set forth on Exhibit "C", which is attached hereto and incorporated herein.
- 4. That passage of this Ordinance shall constitute approval of the PUD Preliminary Plan, incorporated herein as Exhibit "D", such that the following documents and illustrations are hereby approved, reduced copies of which are attached hereto, subject to satisfactory resolution of all outstanding staff review comments and compliance with such conditions, corrections, and modifications as may be required by the Director of Community & Economic Development and the Director of Public Works to comply with the requirements of the St. Charles Municipal Code:
  - Preliminary Plat of Subdivision; WT Group; revisions dated 6/3/2020
  - Preliminary Engineering Plans; WT Groups; revisions dated 6/8/2020 [Sheets C-2.0, C-8.0, C-9.0 revised 6/29/2020]
  - Landscape Plan; Heller & Associates; revisions dated 8/3/2020
  - Lighting Plan; LSI; revisions dated 6/16/2020
  - Building Elevations; Arch7; not dated
  - Canopy Elevations; dated 6/18/2020
  - Signage Plan: Parvin-Clauss Sign Company: revisions dated 6/19/2020
- 5. The Subject Property shall be developed only in accordance with all ordinances of the City as now in effect and as hereafter amended (except as specifically varied herein), and subject to the terms, conditions and restrictions set forth herein, as follows:
  - a. Zoning: The Subject Property shall be subject to the requirements of the BR Regional Business District, as amended, and all other applicable requirements of the St. Charles Zoning Ordinance, as amended, except as specifically varied in the "PUD Deviations" attached hereto and incorporated herein as Exhibit "E".
  - b. Stormwater Management: Per Title 18 of the St. Charles Municipal Code, "Stormwater", Section 18.04.010 Stormwater Management Ordinance Adopted Modifications, Subsection P', the Subject Property was exempted from the 2019 revisions to the Kane County Stormwater Ordinance. The Subject Property may be developed in conformance with the approved PUD Preliminary Plan irrespective of the expiration of said exemption.
- 6. That after the adoption and approval hereof, the Ordinance shall (i) be printed or published in book or pamphlet form, published by the authority of the Council, or (ii) within thirty (30) days after the adoption and approval hereof, be published in a newspaper published in and with a general circulation within the City of St. Charles.

Ordinance No. 2020-Z-Page 3

PRESENTED to the City Council of the City of St. Charles, Kane and DuPage Counties, Illinois this  $7^{th}$  day of December 2020.

PASSED by the City Council of the City of St. Charles, Kane and DuPage Counties, Illinois this  $7^{\text{th}}$  day of December 2020.

APPROVED by the Mayor of the City of St. Charles, Kane and DuPage Counties, Illinois this 7<sup>th</sup> day of December 2020.

minois tins / day of December 2020.	
	Raymond P. Rogina, Mayor
Attest:	
Charles Amenta, City Clerk	
Vote:	
Ayes:	
Nays:	
Absent:	
Abstain:	
Date:	

### **EXHIBIT "A"**

### **LEGAL DESCRIPTION**

THAT PART OF THE NORTHWEST OUARTER OF SECTION 25, TOWNSHIP 40 NORTH, RANGE 8 EAST OF THE THIRD PRINCIPAL MERIDIAN, DESCRIBED AS FOLLOWS: BEGINNING AT A POINT IN THE SOUTH LINE OF SAID OUARTER SECTION, 3.49 CHAINS WEST OF THE SOUTHEAST CORNER OF THE NORTHWEST QUARTER THEREOF; THENCE NORTH 8 DEGREES EAST 20.94 CHAINS; THENCE NORTH 77 DEGREES WEST 14.23 CHAINS; THENCE SOUTH 8 DEGREES WEST 20.58 CHAINS; THENCE NORTH 89 DEGREES EAST 3.35 CHAINS; THENCE SOUTH 3.66 CHAINS TO THE SOUTH LINE OF THE NORTHWEST QUARTER OF SAID SECTION 25; THENCE EAST ON SAID SOUTH LINE 10.52 CHAINS TO THE POINT OF BEGINNING (EXCEPT THAT PART NORTH OF THE CENTER LINE OF ROUTE 64 AND EXCEPT THAT PART WEST OF THE EAST LINE OF KIRK ROAD AND ALSO EXCEPT THAT PART DESCRIBED AS FOLLOWS: BEGINNING AT THE POINT OF INTERSECTION OF THE EASTERLY LINE OF KIRK ROAD (COUNTY HIGHWAY NO. 77) AS DESCRIBED IN DOCUMENT 1107922 WITH A LINE DRAWN PARALLEL WITH AND 50.0 FEET SOUTHERLY OF THE CENTER LINE OF ILLINOIS STATE ROUTE NO. 64 (MEASURED AT RIGHT ANGLES THERETO); THENCE ON AN ASSUMED BEARING OF SOUTH 7 DEGREES, 44 MINUTES, 17 SECONDS WEST ALONG SAID EASTERLY LINE 60.0 FEET; THENCE NORTH 43 DEGREES, 53 MINUTES, 42 SECONDS EAST 83.76 FEET TO SAID PARALLEL LINE; THENCE NORTH 1 DEGREE, 01 MINUTES, 58 SECONDS WEST 50.0 FEET TO SAID CENTER LINE; THENCE SOUTH 88 DEGREES, 58 MINUTES, 02 SECONDS WEST ALONG SAID CENTER LINE 42.29 FEET TO SAID EASTERLY LINE EXTENDED; THENCE SOUTH 7 DEGREES, 44 MINUTES, 17 SECONDS WEST ALONG SAID EASTERLY LINE EXTENDED 50.59 FEET TO THE POINT OF BEGINNING, ALSO EXCEPT THAT PART OF THE SOUTHEAST OUARTER OF THE NORTHWEST QUARTER IN SECTION 25 TOWNSHIP 40 NORTH, RANGE 8, EAST OF THE THIRD PRINCIPAL MERIDIAN, DESCRIBED AS FOLLOWS: BEGINNING AT THE NORTHWEST CORNER OF SAID LOT 5, UNIT 1, THE "ST. CHARLES" ILLINOIS INDUSTRIAL DEVELOPMENT OF THE CENTRAL MANUFACTURING DISTRICT; PROCEED NORTHERLY ON THE NORTHERLY EXTENTION OF THE WEST LINE OF SAID LOT 5, 109.41 FEET, TO A POINT ON THE SOUTHEASTERLY RIGHT OF WAY LINE OF NORTH AVENUE (RT. 64); THENCE NORTHEASTERLY ON SAID RIGHT OF WAY LINE WHICH FORMS AN EXTERIOR ANGLE OF 216 DEGREES 09 MINUTES 25 SECONDS WITH THE LAST DESCRIBED LINE, 21.19 FEET TO A POINT ON A LINE 12.50 FEET EASTERLY OF AND PARALLEL WITH THE NORTHERLY EXTENTION OF THE WEST LINE OF SAID LOT 5; THENCE SOUTHERLY ON SAID PARALLEL LINE WHICH FORMS AN INTERIOR ANGLE OF 36 DEGREES 09 MINUTES 25 SECONDS WITH THE LAST DESCRIBED LINE, 124.63 FEET TO A POINT ON THE NORTH LINE OF SAID LOT 5; THENCE WESTERLY ON SAID NORTH LINE, WHICH FORMS AN INTERIOR ANGLE OF 98 DEGREES 33 MINUTE 48 SECONDS WITH THE LAST DESCRIBED LINE, 12.64 FEET, TO THE POINT OF BEGINNING), IN THE TOWNSHIP AND CITY OF ST. CHARLES, KANE COUNTY, ILLINOIS.

### **EXHIBIT "B"**

### FINDINGS OF FACT FOR MAP AMENDMENT

1. The existing uses and zoning of nearby property.

The intended use is consistent with the other retail business uses along Kirk Rd. and along E. Main St.

2. The extent to which property values are diminished by the existing zoning restrictions.

Property values will not be affected. The intended use is consistent with all nearby uses.

3. The extent to which the reduction of the property's value under the existing zoning restrictions promotes the health, safety, morals or general welfare of the public.

The property value will not be diminished, and in fact will provide an added amenity and convenience to the surrounding city and community.

4. The suitability of the property for the purposes for which it is presently zoned, i.e. the feasibility of developing the property for one or more of the uses permitted under the existing zoning classification.

The subject property's current zoning does not allow for our intended use.

5. The length of time that the property has been vacant, as presently zoned, considered in the context of the land development in the area where the property is located.

This property has been vacant for a substantial amount of time.

6. The evidence, or lack of evidence, of the community's need for the uses permitted under the proposed district.

The intended use is consistent with development trends and all neighboring uses.

7. The consistency of the proposed amendment with the City's Comprehensive Plan.

Our intended use is consistent with the Comprehensive Plan.

8. Whether the proposed amendment corrects an error or omission in the Zoning Map.

Per Title 17 of the City Code, unless otherwise requested, land being annexed is automatically zoned RE-1 Single-Family Estates District. BR zoning is requested to accommodate the proposed commercial development.

## 9. The extent to which the proposed amendment creates nonconformities.

The proposed development will only require paving setback and off-site sign deviations. Other than that, the development will comply with zoning requirements.

## 10. The trend of development, if any, in the general area of the property in question.

The intended use is consistent with the other retail business uses.

### EXHIBIT "C"

### CRITERIA FOR PLANNED UNIT DEVELOPMENTS

- i. The proposed PUD advances one or more of the purposes of the Planned Unit Development procedure stated in Section 17.04.400.A:
  - 1. To promote a creative approach to site improvements and building design that results in a distinctive, attractive development that has a strong sense of place, yet becomes an integral part of the community.
  - 2. To create places oriented to the pedestrian that promote physical activity and social interaction, including but not limited to walkable neighborhoods, usable open space and recreational facilities for the enjoyment of all.
  - 3. To encourage a harmonious mix of land uses and a variety of housing types and prices.
  - 4. To preserve native vegetation, topographic and geological features, and environmentally sensitive areas.
  - 5. To promote the economical development and efficient use of land, utilities, street improvements, drainage facilities, structures and other facilities.
  - 6. To encourage redevelopment of sites containing obsolete or inappropriate buildings or uses.
  - 7. To encourage a collaborative process among developers, neighboring property owners and residents, governmental bodies and the community.

We believe that the proposed development advances many of the purposes of the Planned Unit Development as outlined and stated in Section 17.04.400.A.

The architectural building design will provide a unique and distinctive look that will include "barn" like features that will capture the historic essence of the property.

New sidewalks are proposed along the entire west and north property lines to connect existing sidewalk structures along Kirk Rd. and Main St. to help promote pedestrian traffic and physical activity.

This property has remained undeveloped for a very long time and the proposed development allows for and encourages and promotes economic growth and efficient land use.

This development includes a reciprocal easement agreement with the neighboring property owner (Main Street Commons) which allows for cross-access service roads and shared stormwater detention.

- ii. The proposed PUD and PUD Preliminary Plans conform to the requirements of the underlying zoning district or districts in which the PUD is located and to the applicable Design Review Standards contained in Chapter 17.06, except where:
  - A. Conforming to the requirements would inhibit creative design that serves community goals, or
  - B. Conforming to the requirements would be impractical and the proposed PUD will provide benefits that outweigh those that would have been realized by conforming to the applicable requirements.

Factors listed in Section 17.04.400.B shall be used to justify the relief from requirements:

- 1. The PUD will provide community amenities beyond those required by ordinance, such as recreational facilities, public plazas, gardens, public are, pedestrian and transit facilities.
- 2. The PUD will preserve open space, natural beauty and critical environmental areas in excess of what is required by ordinance or other regulation.
- 3. The PUD will provide superior landscaping, buffering or screening.
- 4. The buildings within the PUD offer high quality architectural design.
- 5. The PUD provides for energy efficient building and site design.
- 6. The PUD provides for the use of innovative stormwater management techniques.
- 7. The PUD provides accessible dwelling units in numbers or with features beyond what is required by the Americans with Disabilities Act (ADA) or other applicable codes.
- 8. The PUD provides affordable dwelling units in conformance with, or in excess of, City policies and ordinances.
- 9. The PUD preserves historic buildings, sites or neighborhoods.

The following factors below per Section 17.04.400.B are highlighted to justify relief from certain zoning requirements:

- The PUD will provide superior landscaping and buffering as allowed by the site parameters.
- The buildings within the PUD will be unique and distinctive in nature, capturing historic features.
- The buildings will be built with energy efficiency guidelines and site design.
- The development will be designed with shared detention with Main Street Commons.

Zoning deviations for the following are being requested: paving setbacks, off-site signage, convenience store building signage, freestanding sign setback, building foundation landscape, carwash stacking requirement.

iii. The proposed PUD conforms with the standards applicable to Special uses (section 17.04.330.C.0):

A. Public Convenience: The Special Use will serve the public convenience at the proposed location.

Yes. The proposed development will serve as a public convenience and an added amenity. The development will offer fueling, convenience store, quick service restaurant and carwash.

B. Sufficient Infrastructure: That adequate utilities, access roads, drainage and/or necessary facilities have been, or are being, provided.

Yes. The proposed development has sufficient infrastructure required to develop. Utilities, added service roads, and adequate on-site and off-site detention are being provided.

C. Effect on Nearby Property: That the Special Use will not be injurious to the use and enjoyment of other property in the immediate vicinity for the purposes already permitted, nor substantially diminish or impair property values within the neighborhood.

The development is consistent and compatible with surrounding land uses and will not affect nearby property in any way.

D. Effect on Development of Surrounding Property: That the establishment of the Special Use will not impede the normal and orderly development and improvement of the surrounding property for uses permitted in the district.

The development will not impede the normal and orderly development and improvement of the surrounding property and will complete the needed development at that particular property location in a manner that is consistent and compatible with surrounding and neighboring property.

E. Effect on General Welfare: That the establishment, maintenance or operation of the Special Use will not be detrimental to or endanger the public health, safety, comfort or general welfare.

No. The proposed development will not pose any detriment to or endanger the public health, safety, comfort or general welfare.

F. Conformance with Codes: That the proposed Special Use conforms to all existing Federal, State and local legislation and regulation and meets or exceeds all applicable provisions of this Title, except as may be varied pursuant to a Special Use for Planned Unit Development.

Yes. The development will be built to conform to all applicable codes and ordinances and meets all applicable provisions, except as may be varied pursuant to a Special Use for PUD.

# iv. The proposed PUD will be beneficial to the physical development, diversity, tax base and economic well-being of the City.

Yes. The proposed development will provide an added and substantial tax base to the City, improving the overall economic well-being of the City.

## v. The proposed PUD conforms to the purposes and intent of the Comprehensive Plan.

Yes. The proposed development is in conformance with the goals, objectives and policies of the adopted City of St. Charles Comprehensive Plan.

## EXHIBIT "D"

# PUD PRELIMINARY PLAN (45 pages)

NOTARY PUBLIC

MY COMMISSION EXPIRES: \_\_\_\_


BASIS OF BEARINGS IS TRUE NORTH BASED ON ILLINOIS STATE PLANE COORDINATE SYSTEM, ILLINOIS FAST 1201 ZONE.

# PRELIMINARY PLAT OF SUBDIVISION PRIDE OF KANE COUNTY





PIN NUMBER: 09-25-100-036

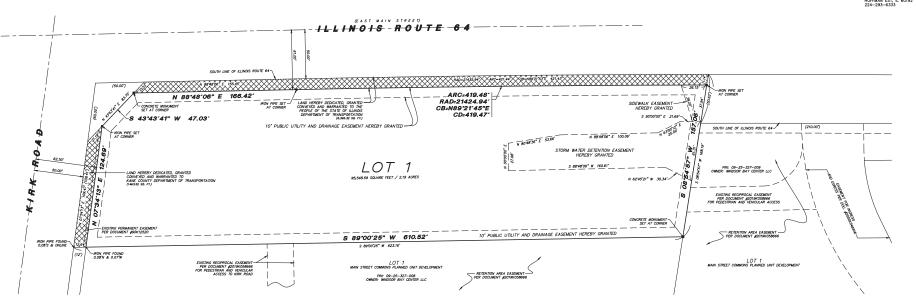

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ATED THIS DAY OF A.D	STATE OF ILLINGS ) SCOUNTY OF KANE )	SPECIAL ASSESSMENT CERTIFICATE
Y:	APPROVED THIS DAY OF, A.D BY THE COUNCIL OF THE CITY OF ST. CHARLES.	STATE OF
DDDESS:	MAYOR	I, DO HEREBY CERTIFY THAT THERE ARE NO DELINQUENT OR UNPAID CURRENT OR FORFEITED SHEQUAL ASSESSMENTS OR ANY DEFERRED INSTALLABRYS THEREOF THAT HAVE BEEN APPORTIONED AGAINST THE TRACT OF LAND INCLUDED IN THE PLAT.
	CITY CLERK	COLLECTOR OF SPECIAL ASSESSMENTS
		DATED AT ST. CHARLES, ILLINOIS, THIS DAY OF, A.D
NOTARY CERTIFICATE		
TATE OF) SS SOUNTY OF)	DIRECTOR OF COMMUNITY DEVELOPMENT CERTIFICATE	
IERBY CERTIFY THAT	STATE OF	PLAN COMMISSION CERTIFICATE STATE OF ILLINOS ) SCULTY OF KANE ) SAPPROVED BY THE PLAN COMMISSION OF THE CITY OF ST. CHARLES.

DATED AT \_\_\_\_\_\_, ILLINOIS, THIS \_\_\_\_\_ DAY OF \_\_\_\_\_, .D. 20\_\_\_.

DIRECTOR OF COMMUNITY DEVELOPMENT

ILLINOIS DEPARTMENT OF TRANSPORTATION CERTIFICATE

THIS PLAT HAS BEEN APPROVED BY THE ILLINOIS DEPARTMENT OF TRANSPORTATION WITH RESPECT TO ROJOMAY ACCESS PURSUANT OF §2 OF "AN ACT TO REVISE THE LAW IN RELATION TO PLATS," AS AMENDADA, PLATA THAT HERS THE REQUIREMENTS CONTAINED IN THE DEPARTMENTS "PCLUCY ON PERMITS FOR ACCESS DRIVEWAYS TO STATE HIGHWAYS" WILL BE REQUIRED BY THE DEPARTMENTS.

ANTHONY J. QUIGLEY P.E. REGION ONE ENGINEER

ILLINOIS DEPARTMENT OF TRANSPORTATION DEDICATION DESCRIPTION TO BE CREATED AFTER REVIEW

SUB-1

GROUP

5

PLAT OF SUBDIVISION
PRIDE OF KANE COUNTY
33W573 EAST MAIN STREET
SAINT CHARLES, ILLINOIS

ELECTRICAL \ PLUMBING \ TELECOMMUNICATION \ STRUCTURAL \ ACCESSIBILITY CONSULTING \ D

CIMA DEVELOPERS 30W180 BUTTERFIELD ROAD WARRENVILLE, IL 60555

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# PRELIMINARY PLAT OF SUBDIVISION PRIDE OF KANE COUNTY

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IN.	NUMBER:	
9-	25-100-036	

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GROUP

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PLAT OF SUBDIVISION
PRIDE OF KANE COUNTY
33W573 EAST MAIN STREET
SAINT CHARLES, ILLINOIS

ERFIELD ROAD LE, IL 60555 DEVELOPERS 180 BUTTERFIELD ARRENVILLE, IL 606

ISSUE

CLIENT

SUB-2

COUNTY RECORDER'S CERTIFICATE
STATE OF ILLINOIS )
COUNTY OF KANE )
THE UNDERSIGNED AS THE RECORDER OF DEEDS FOR KANE COUNTY DO HEREBY CERTIFY THAT INSTRUMENT
NUMBER WAS FILED FOR RECORD IN THE RECORDER'S OFFICE OF KANE COUNTY, ILLINOIS ON THE DAY OF A.D. 20 AT O'CLOCK _M.
THE DAT OF A.D. 20 AT O'CLOCK _M.
RECORDER OF DEEDS
D. C. OF DRIVE THE COLUMN
PLEASE PRINT/TYPE NAME
COUNTY ENGINEER'S CERTIFICATE
STATE OF ILLINOIS )
SS COUNTY OF KANE )
·
THIS PLAT HAS BEEN APPROVED BY THE KANE COUNTY ENGINEER WITH RESPECT TO ROADWAY ACCESS TO PURSUANT TO ILCS CHAPTER 765 PARAGRAPH 205/2. DATED THIS DAY
0F A.D. 20
COUNTY ENGINEER
DATED AT, ILLINOIS, THIS DAY OF, .D. 20
COUNTY CLERK'S CERTIFICATE STATE OF ILLINOIS )
SS
COUNTY OF KANE )
ANNUAL ALEMAN AND ANNUAL ANNUAL AND
I,, COUNTY CLERK OF KANE COUNTY, ILLINOIS, DO HEREBY CERTIFY THAT THERE ARE NO DELINQUENT GENERAL TAXES, NO UNPAID FORFEITED TAXES, AND NO REDEEMABLE TAX
SALES AGAINST ANY OF THE LAND INCLUDED IN THIS PLAT.
I, FURTHER CERTIFY THAT I HAVE RECEIVED ALL STATUTORY FEES IN CONNECTION WITH THIS PLAT.
GIVEN UNDER MY HAND AND SEAL OF THE COUNTY CLERK OF KANE COUNTY, ILLINOIS.
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THIS DAY OF, A.D.,20
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COUNTY OF KANE )
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NUMBER WAS FILED FOR RECORD IN THE RECORDER'S OFFICE OF KANE COUNTY, ILLINOIS ON THE DAY OF A.D. 20 AT O'CLOCK _M.
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#### SURVEYORS CERTIFICATE

STATE OF ILLINOIS ) SS COUNTY OF COOK )

THIS IS TO STATE THAT I, FRANJO I. MATICIC, ILLINOIS PROFESSIONAL LAND SURVEYORS #035-003556, HAVE SURVEYED AND SUBDIVIDED THE FOLLOWING DESCRIBED PROPERTY:

THIS IS O STATE THAT I, PRANJO I, MATIOC, LINGOF PROFESSIONAL LARGE SURVIVORS (2023—0,00056), HAVE SURVIVORD AND S

I FURTHER CERTIFY THAT THE PLAT HEREON DRAWN IS A CORRECT AND ACCURATE REPRESENTATION OF SAID SURVEY AND SUBDIVISION. ALL DISTANCES ARE SHOWN IN FEET AND DECIMAL PARTS THEREOF.

I FURTHER CERTIFY THAT I WILL SET ALL SUBDIVISION MONUMENTS AND HAVE DESCRIBED THEM ON THIS FINAL PLAT AS REQUIRED BY THE PLAT ACT (765 ILS 205/). THE EXTEROR SUBDIVISION MONUMENTS HAVE BEEN SET AND INTEROR MONUMENTS WILL BEST WIMEN 12 MONTHS OF THE RECORDING OF THIS PLAT (SECTION 1270–56 OF THE ILLINGIS PROFESSIONAL LAND SURVEYOR ACT OF 1989)

GIVEN UNDER OUR HAND AND SEAL THIS \_\_\_\_\_\_ DAY OF \_\_\_\_\_\_ A.D.\_\_\_\_. AT HOFFMAN ESTATES, ILLINOIS.

FOR REVIEW 06/03/20 FRANJO I. MATICIC - PLS #035-003556 EXPIRES 11/30/2020 ILLINOIS PROFESSIONAL DESIGN FIRM LICENSE NO. 184.007570-0015

# THE PRIDE OF KANE COUNTY **33W573 EAST MAIN STREET SAINT CHARLES, ILLINOIS 60174**

	DRAWING INDEX	
SHEET	DESCRIPTION	DATE
T-1.0	TITLE SHEET	06-08-20
C-1.0	SITE DEMOLITION PLAN	06-08-20
C-2.0	SITE GEOMETRIC PLAN	06-08-20
C-3.0	SITE DEVELOPMENT PLAN	06-08-20
C-3.1 - C-3.3	SITE DEVELOPMENT DETAILS	06-08-20
C-4.0 - C-4.1	SITE GRADING PLAN	06-08-20
C-5.0	SITE UTILITY PLAN	06-08-20
C-5.1 - C-5.3	SITE UTILITY DETAILS	06-08-20
C-6.0	STORMWATER POLLUTION PREVENTION PLAN	06-08-20
C-6.1	STORMWATER POLLUTION PREVENTION DETAILS	06-08-20
C-7.0 - C-7.1	PROJECT SPECIFICATIONS	06-08-20
C-8.0	FIRE APPARATUS CIRCULATION PLAN	06-08-20

	SURVEY DRAWING INDEX	
SHEET	DESCRIPTION	DATE
SUR-1	TOPOGRAPHIC SURVEY (PREPARED BY THE W-T GROUP)	03-12-19

SITE BENCHMARK #I - SET CROSS ON SSE BOLT OF HYDRANT LOCATED IN GRASS APPROXI OF MH #6, AS SHOWN ON SHEET SUR-2. ELEVATION=784.75' (NAVD88)

RK #2 - SET CROSS ON CONCRETE SIDEMALK LOCATED APPROXIMATELY 25.3' ESE OF KIRK ROAD AND 22.6' SSM OF ENTRANCE, AS SHOWN ON SHEET SUR-2. ELEVATION=T19.09' (NAVD86)

SITE BENCHMARK #3 - SET CROSS IN WALK LOCATED 35" EAST OF POND AND 200 FEET SOUTH OF ROUTE 64 ON WEST SIDE OF DRIVE, AS SHOWN ON SHEET SUR-3. ELEVATION=189.12" (NAV/D88)



**SECTION 25** 


**TOWNSHIP 40N** RANGE 8E


#### CIVIL ENGINEERING STATEMENT AND SEAL

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TODD ABRAMS - ILLINOIS P.E. # 062-061600 DATE OF EXPIRATION - NOVEMBER 30, 2021 NOTE: SIGNED AND SEALED FOR SHEETS T-LO THROUGH G-7.1





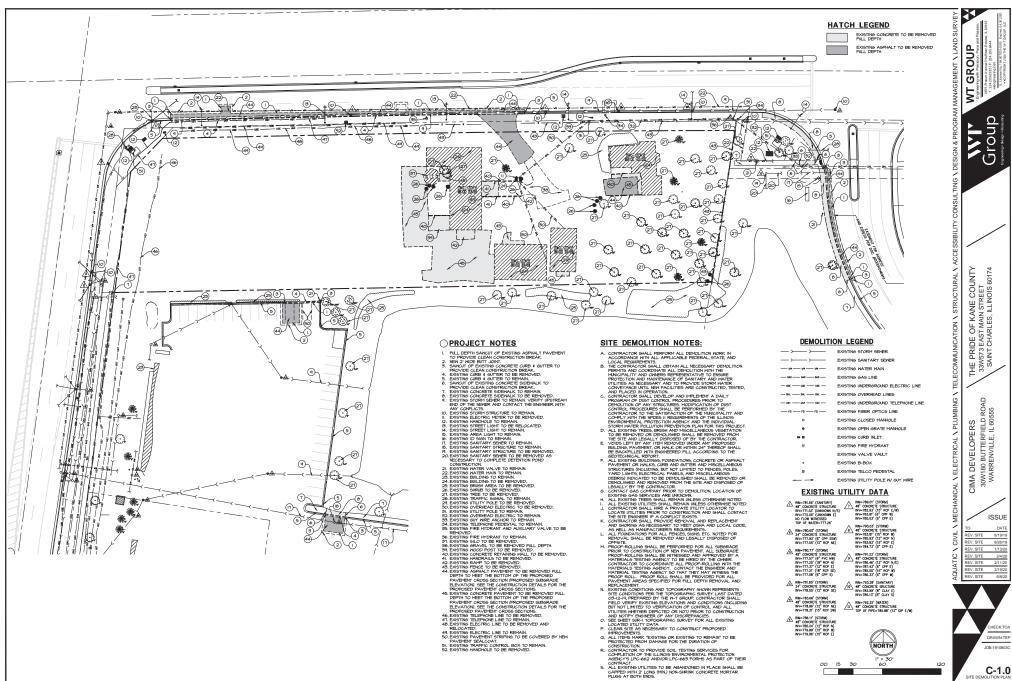

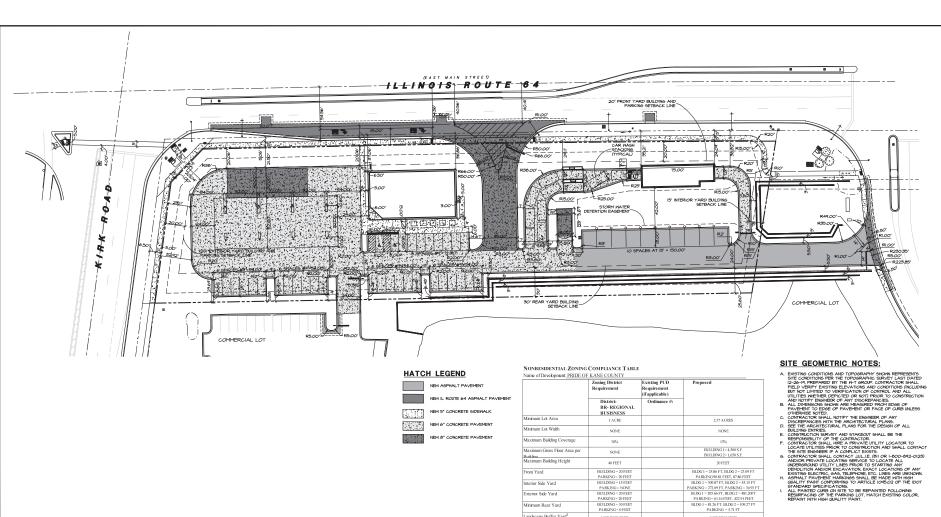Exterior Side Yard Minimum Rear Yard Landscape Buffer Yard

% Overall Landscaped Area

Building Foundation Landscaping

% Interior Parking Lot Landscaping

Interior Parking Lot Shade Trees

# of Parking space

50% HORIZONTAL

DIMENSIONS OF BUILDING WALL

NOT AVAILABLE

CARWASH = 2 PER BAY+10 STACKING SPACES PER BAY RETAIL BUILDING = 4 PER


37% WITH ON SITE STORM

BUILDING 1 = 50% BUILDING 2 = 100%

CARWASH = 10 SPACES + 10 STACKING RETAIL BUILDING = 34



GALL I(800)842-0123 48 HOURS BEFORE YOU DIG CONTRACTOR MUST LOCATE PRIVATE UTILITIES IN AREA OF CONSTRUCTION PRIOR TO PROCEEDING WITH WORK

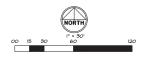

C-2.0

GROUP


THE PRIDE OF KANE COUNTY 33W573 EAST MAIN STREET SAINT CHARLES, ILLINOIS 60174

CIMA DEVELOPERS 30W180 BUTTERFIELD ROAD WARRENVILLE, IL 60555

ISSUE

REV. SITE 8/26/19 REV. SITE 1/13/20


REV. SITE 2/11/20 REV. SITE 2/19/20 REV. SITE 6/8/20 REV. SITE 6/29/20

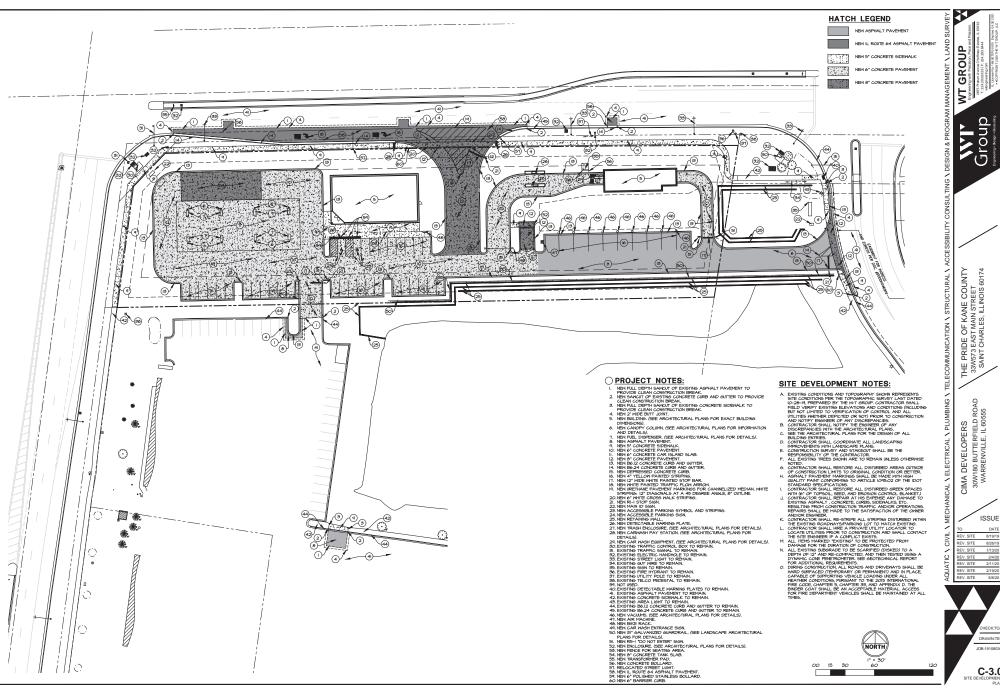





1/13/20


2/4/20

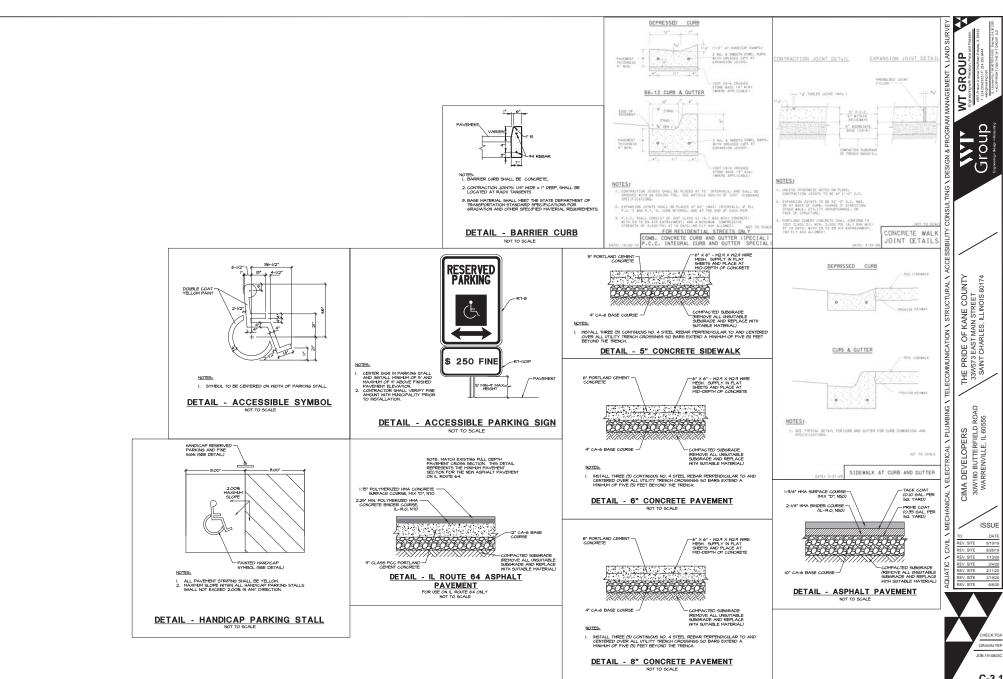

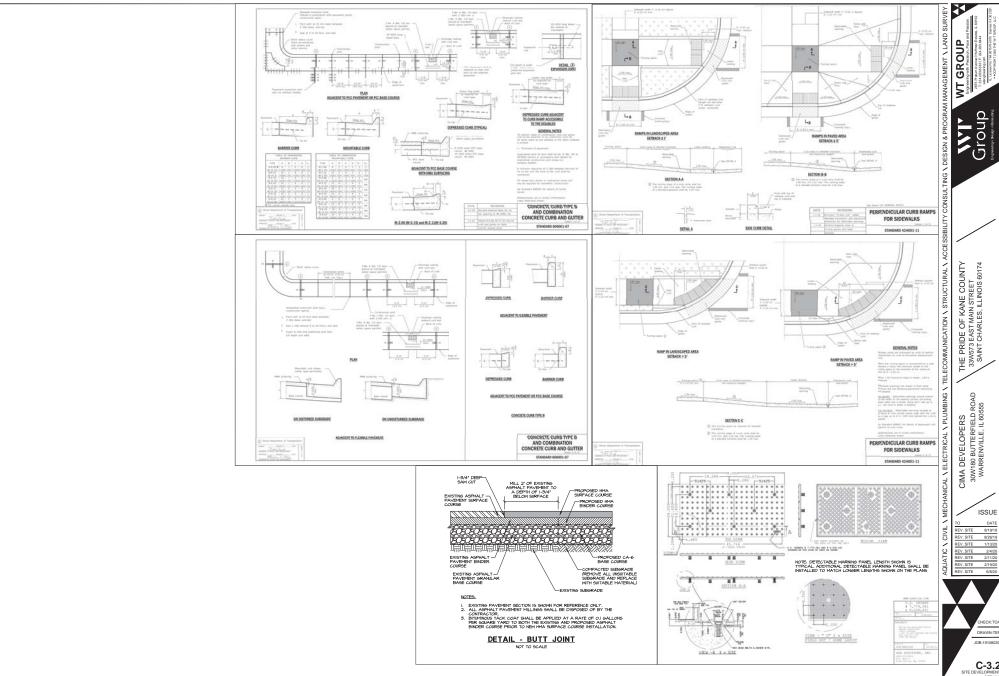

ISSUE

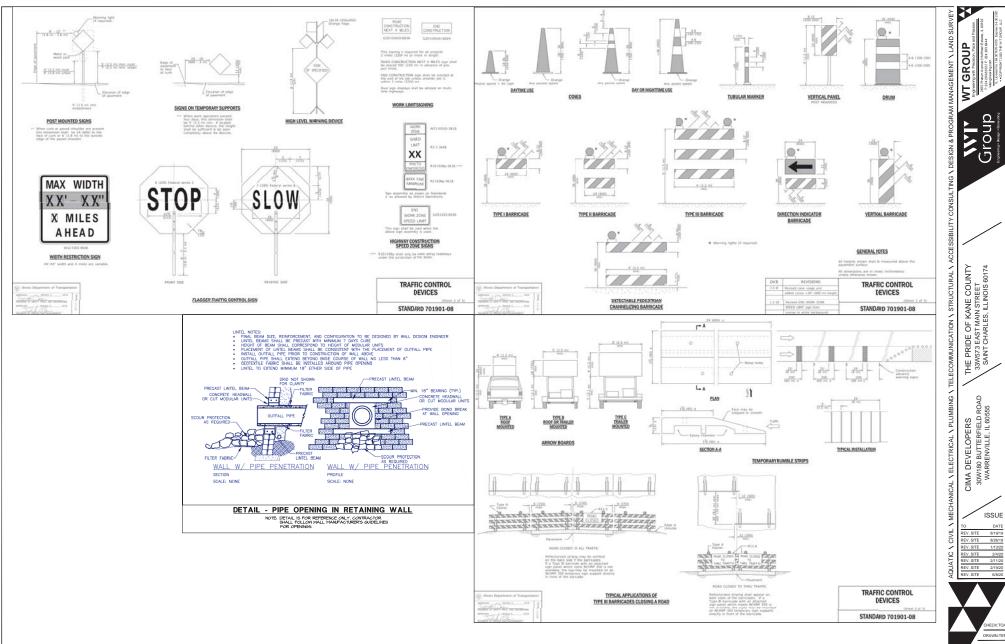

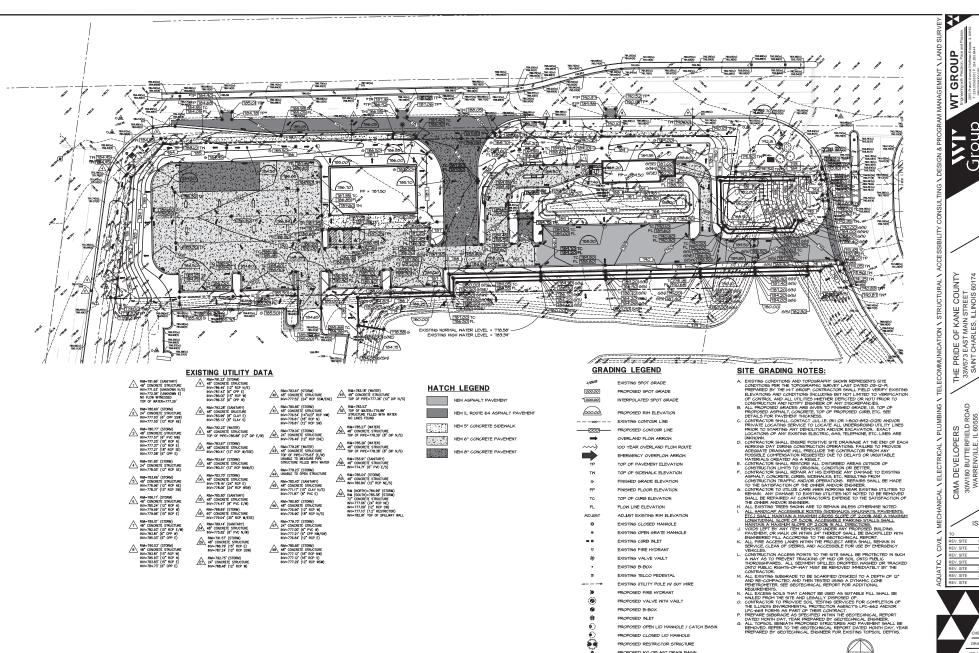

PROPOSED NYLOPLAST DRAIN BASIN

PROPOSED ELARED END SECTION PROPOSED GREASE TRAP

FIELD ROAI CIMA DEVELOPERS 30W180 BUTTERFIELD F WARRENVILLE, IL 605


ISSUE 1/13/2

EV. SITE REV. SITE 2/4/20

JOB:1910803C

NORTH

C-4.0

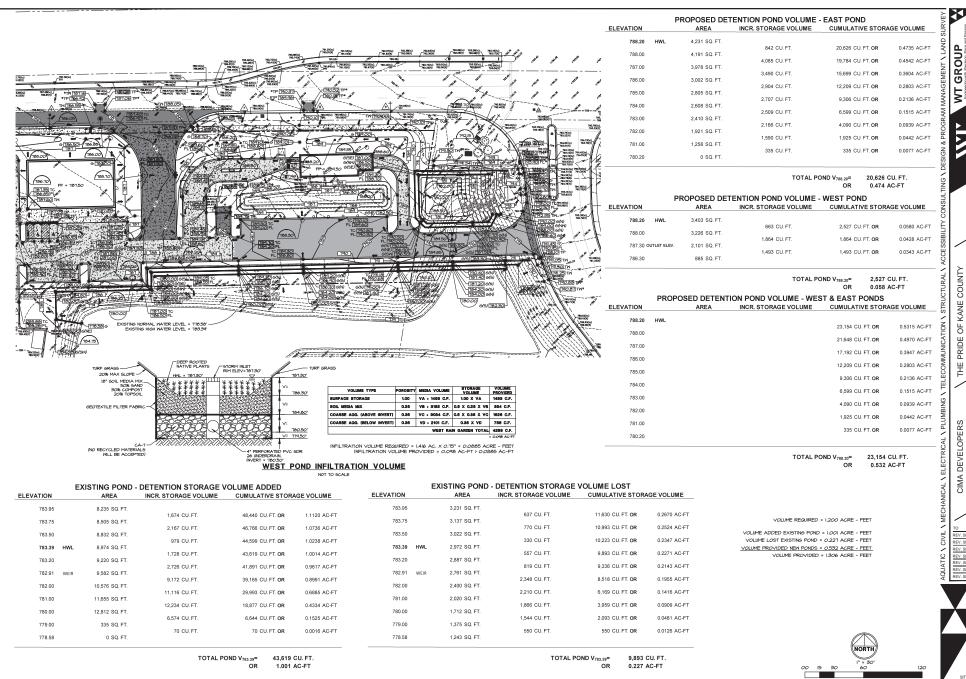

60174 P


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IMA DEVELOPERS 30W180 BUTTERFIELD F WARRENVILLE, IL 605

ISSU REV. SITE 8/19/19 REV. SITE 8/26/19 2/4/2

REV. SITE

C-4.1

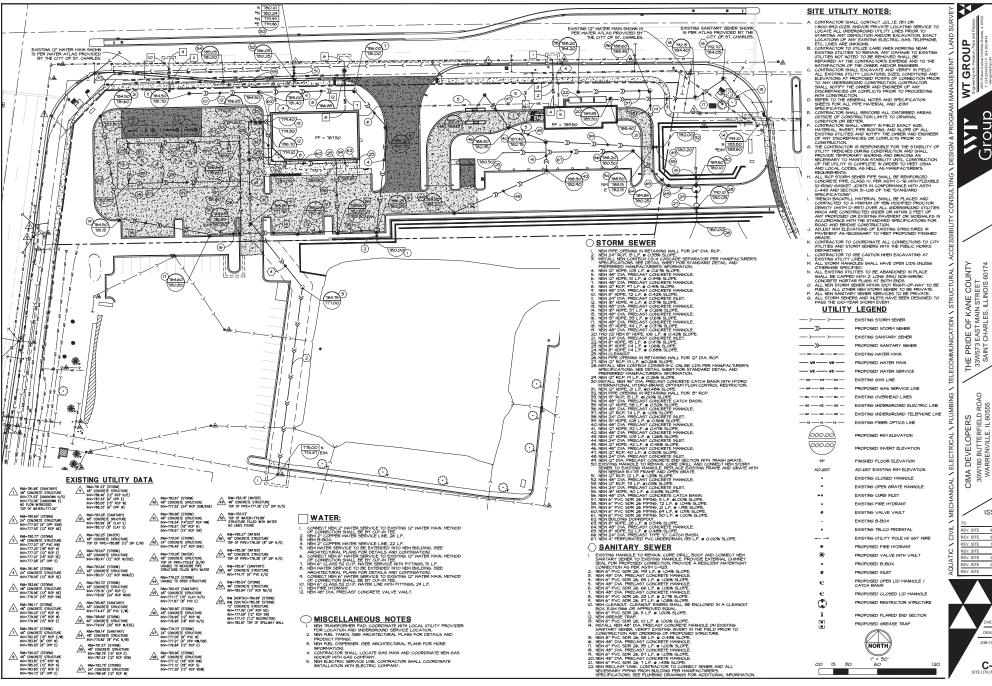

60174 THE PRIDE OF KANE COU 33W573 EAST MAIN STREET SAINT CHARLES, ILLINOIS


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ISSUE REV. SITE 8/19/19 1/13/20 2/4/20 6/9/2

REV. SITE 2/19/2

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C-5.0



MARTERIAL BOOSES

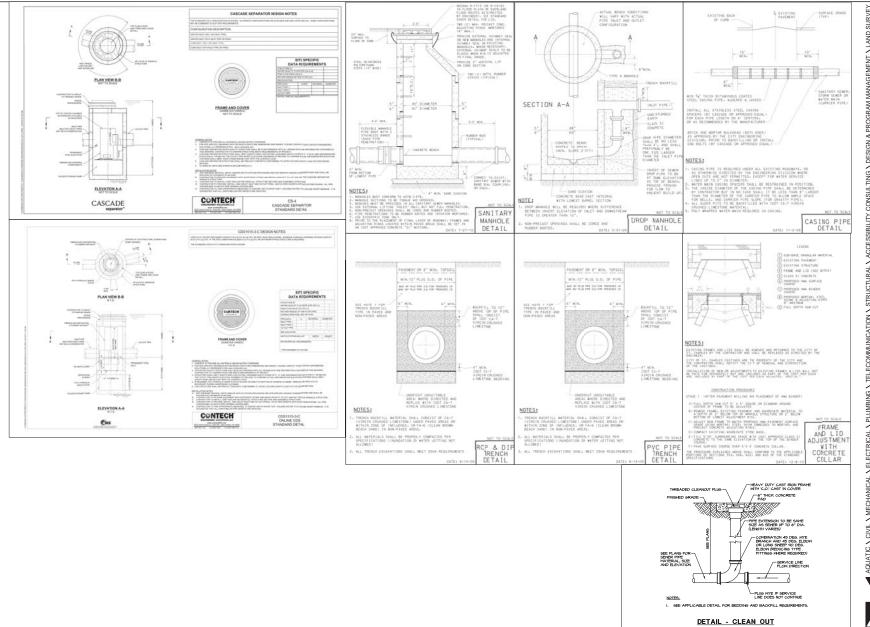SAINT CHARLES, ILL ROSES

SAINT CHARLES, ILL ROSES


SAINT CHARLES, ILL ROSES

SAINT CHARLES, ILL ROSES

GROUP

C-5.1


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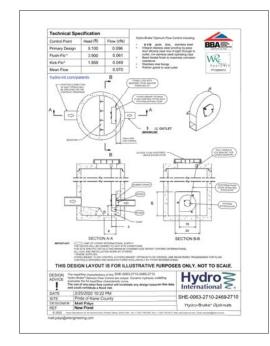
C-5.2

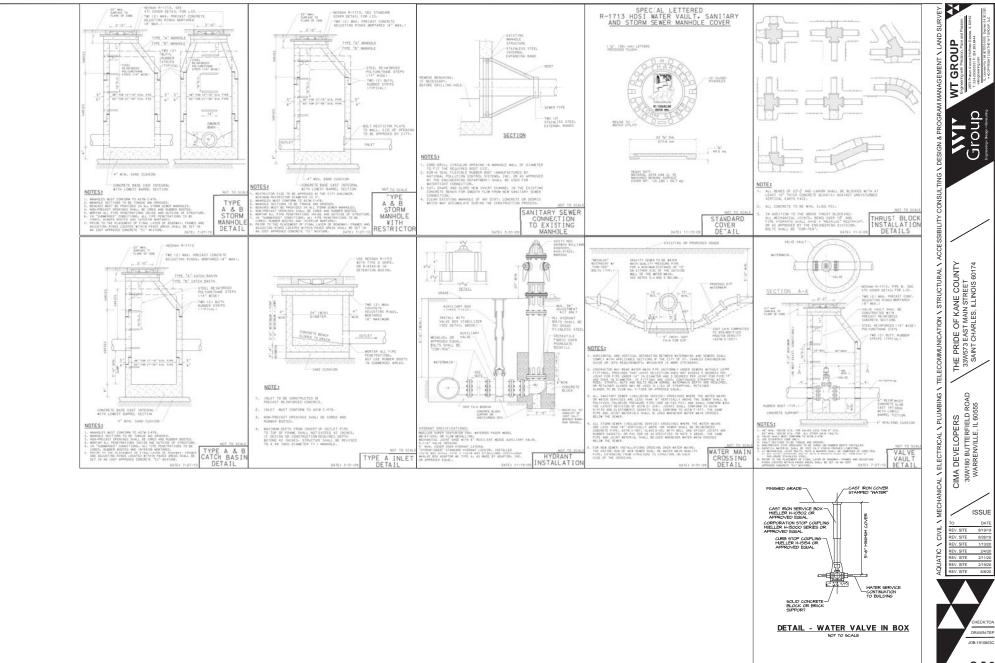
JOB:1910803C

C-5.3



DETAIL - 96" CATCH BASIN #30 WITH RESTRICTOR

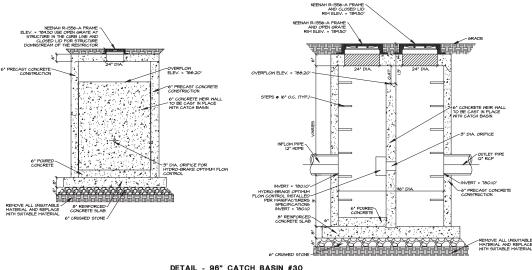

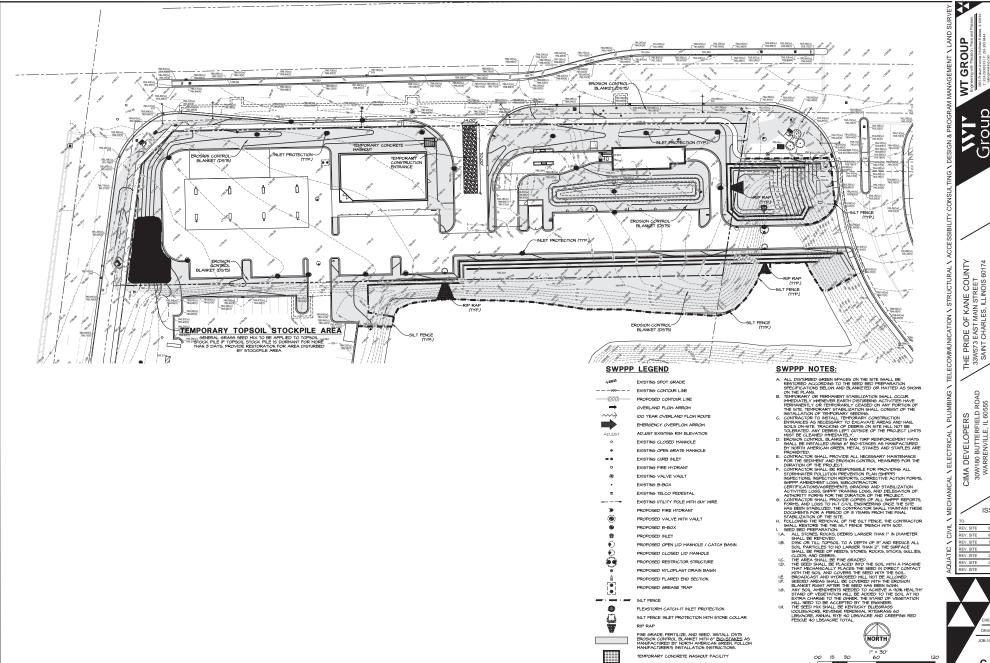


ISSUE

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C-6.0



THE PRIDE OF KANE COUNTY 33W573 EAST MAIN STREET SAINT CHARLES, ILLINOIS 60174 CIMA DEVELOPERS 30W180 BUTTERFIELD ROAD WARRENVILLE, IL 60555

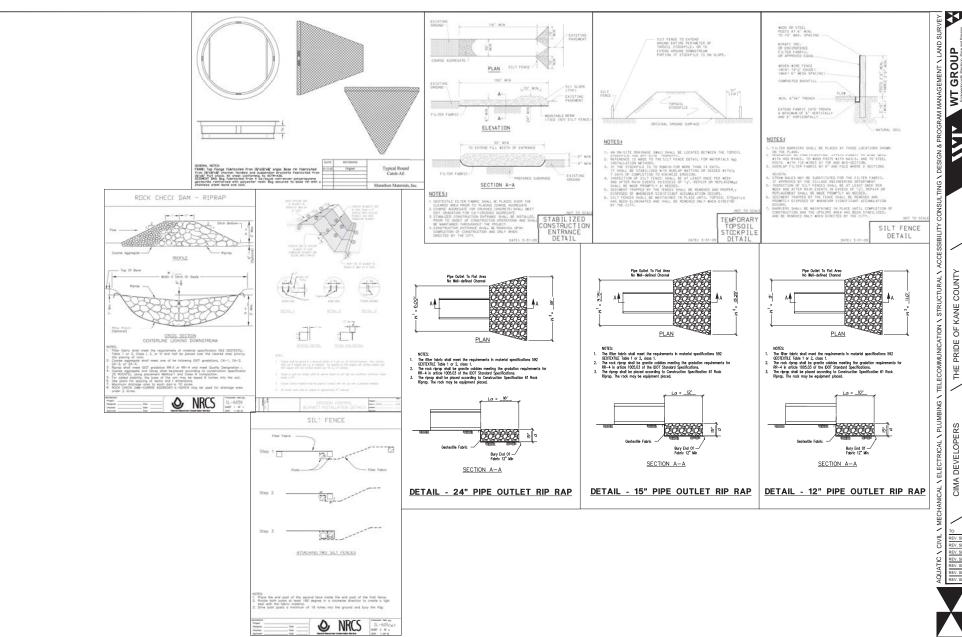ISSUE REV. SITE 8/19/19 REV. SITE 8/26/19 REV. SITE 2/4/20 REV. SITE 2/11/20 REV. SITE 2/19/20 REV. SITE 6/8/20

JOB:1910803C

C-6.1

- I.3. "ILLINOIS URBAN MANUAL," LATEST EDITION
- I.4. BUILDING CODES AND ORDINANCES OF THE LOCAL GOVERNING AUTHORITIES.
- I.5. UNITED STATES DEPARTMENT OF LABOR OCCUPATIONAL SAFETY AND HEALTH ADMINISTRATION (OSHA) REGULATIONS, 24 CFR PART 1426, "SAFETY AND HEALTH REGULATIONS FOR CONSTRUCTION."
- I.6. ILLINOIS DRAINAGE LAW.
- 17 II LINOIS ENVIRONMENTAL BARRIERS ACT
- LB. ILLINOIS ACCESSIBILITY CODE.

- 2. ALL REQUIRED FERMITS FROM THE APPROPRIATE GOVERNING AGENCY(S) SHALL BE OBTANED FOR CONSTRUCTION ALONG OR ACKNOSE ENSINES STREETS OR REPORT OF THE CONSTRUCTION ALONG OR ACKNOSE ENSINES STREETS OR REACHES, SECTION, AND OTHER REQUIRED PROVIDETION OF THE ACKNOSING OR ACKNOSING O
- CONTRACTOR SHALL NOTIFY ALL UTILITY COMPANIES (6AS, ELECTRIC, TELEPHORE, CARLE, ETC.) AND THE LOCAL MANDALITY TO DETERMINE THE CONSTRUCTION OF THE PROPERTY OF THE CONSTRUCTION OF MODER TO ANOTO PETITALNIC CONTRACTORS SHALL CALL THE JOINT UTILITY LOCATION REPORTATION FOR EXCANATIONS (JULIE) AT HIGO-OS-OCIOZIO SET DIALINO SITT IS ULTIMITET. THE RESPONSIBILITY OF THE PLANS OR NOT AND TO HAVE THESE UTILITIES STACED PRIOR TO CONSTRUCTION.

- ALL UTILITY CONNECTIONS TO EXISTING LINES SHALL BE CONSTRUCTED IN ACCORDANCE WITH THE RULES AND REGULATIONS AND TO THE SATISFACTION OF THE APPLICABLE UTILITY OWNER(S).
- CONTRACTOR SHALL FIELD VERIFY ALL DIMENSIONS, COORDINATES AND ELEVATIONS PRIOR TO THE COMMENCEMENT OF CONSTRUCTION AND SHALL IMMEDIATELY NOTIFY THE ENGINEER OF ANY DISCREPANCIES SO THE CONFLICT MAY BE RESOLVED.
- IO. THE SAFE AND ORDERLY PASSAGE OF TRAFFIG AND PEDESTRIANS SHALL BE PROVIDED WERRE CONSTRUCTION OPERATIONS ABUT PUBLIC THROUGH-FARES AND ADJACENT PROPERTY.
- ALL AREAS DISTURBED BY THE SENERAL CONTRACTOR OR SUB-CONTRACTORS SHALL BE RETURNED TO THE ORIGINAL CONDITIONS OR BETTER, EXCEPT WHERE PROPOSED CONSTRUCTION IS INDICATED ON THE PLANS.
- 12. NO BURNING OR INCINERATION OF RUBBISH WILL BE PERMITTED ON SITE.
- IS, PRICE TO INTILL ALCEPTANCE BY THE CHRESTS AND/OR SO-CHRANS
  AUTHORITY ALL INCRES SHALL BE INSECTION AND APPROVED BY THE CHARRY
  AND HANCIPALITY BEINERS OR HIS REPRESENTATIVES. THE CONTRACTOR
  AND HANCIPALITY BEINERS OR FRIEND OF IN BIOMETIES MORNING FROM
  MAY TO THE CONTRACTOR OF THE CONTRACTOR OF THE PRICE OF THE P
- I4. CONTRACTOR SHALL BE RESPONSIBLE FOR PROVIDING SAFE AND ADEQUATE WORKING CONDITIONS THROUGHOUT THE DURATION OF CONSTRUCTION OF THE PROPOSED IMPROVEMENTS.
- CONTRACTOR SHALL KEEP THE PUBLIC STREET PAVEMENTS CLEAN OF DIRT AND DEBRIS AND, WHEN NECESSARY, CLEAN PAVEMENTS AT THE END OF EACH KORKINS DAY.
- ALL CONSTRUCTION STAKING, SCHEDULING AND PAYMENT IS THE RESPONSIBILITY OF THE CONTRACTOR.
- THREE (3) ORIGINAL COPIES OF ALL SHOP DRAWINGS SHALL BE SUBMITTED TO THE ENGINEER FOR (BUT NOT LIMITED TO) THE FOLLOWING ITEMS.

- 17.3. GRANULAR MATERIAL GRADATION
- 17.4. PRECAST CONCRETE STRUCTURES (MANHOLES, INLETS, CATCH BASINS, VAULTS, ETC.)
- 17.5. WATER MAIN MATERIALS (VALVES, FIRE HYDRANTS, ETC.)
- I.B. AFTER COMPLETION OF THE PROPOSED IMPROVEMENTS AND WHEN REQUIRED BY THE GOVERNING AUTHORITY(S), CONTRACTOR SHALL PROVIDE THE OWNER AND DESINEER NATH AS-BULL TAKOOK RECORD PROVINGING, SHOOD AND SEALED BY A PROPESSIONALLY LICENSED ENSINEER OR SURVEYOR AND SHALL INCLIDE AT A HIREMAN (WEREEL APPLICABLE TO THE SCOPE OF PROPRY THE POLLOWING TIEMS.
- 19.1 TOPOGRAPHY AND SPOT GRADE ELEVATIONS OF ALL PROPOSED PERMANENT SITE FEATURES INCLUDING ANY STORM WATER FACILITIES OR MODIFICATIONS TO EXISTING STORM WATER FACILITIES.
- 14.2 HORIZONTAL AND VERTICAL LOCATION AND ALIGNMENT OF ALL PROPOSED ROADWAYS, PARKING LOTS, UTILITIES, BUILDINGS OR OTHER PERMANENT SITE FEATURES.
- 14.3 RIM AND INVERT AND/OR TOP OF PIPE ELEVATIONS FOR ALL PROPOSED UTILITIES.
- 19.4 AS-BULT AND/OR RECORD DRAWING INFORMATION SHALL BE SHOWN ON THE PREVAMED ENGINEERING PLANS ISSUED FOR CONSTRUCTION, ANY AND ALL DEVALUED FROM THESE PAPROXIDE PLANS SHALL BE SHOWN BY MEANS OF STRIKING THEOLOGY THE PROPOSED INFORMATION AND CLEARLY INDICATING THE AS-BULT LOCATIONS AND ELEVATIONS ON THE APPLICABLE PLANS WEETER.

#### SITE GRADING AND PAVING

- ALL SITE MOST, GRADINE, AND PAVING OPPOSITORS, WHICH ITSELENTS OF THIS PRODUCT SHALL BE PROPRIORDED IN ACCORDANCE WITH THE LIMITS OF DEPARTMENT OF TRANSPORTATION STANDARD SPECIFICATIONS FOR ROAD AND BRIDGE CONSTRUCTION. LATEST EDITION IN STANDARD SPECIFICATIONS FOR ROAD HEAD BROAD SCHOOL STRUCTURES AND THE DITTON IN STANDARD SPECIFICATIONS FOR THE DITTON IN STANDARD SPECIFICATION. HE WITH THE CODES AND DISTONANCES OF THE SOVERNING ANTICOTTIES. IN CASE OF COPIELOT, THE MOST STRINGEN CODE SHALL TAKE PRESCEIDERS.
- EARTH EXCLATION BMLL INCLIEF CLEARING STRIPPING AND STOCKPLING TOPSOL, REPOVOUS BESTATES MATERIALS, CONSTRUCTION, OF THE SHAKESHING, KOLLSTRICTISKI, FILLS, FINAL, SHAMBIG AND TRIPPING. TO THE DEPARTMENT OF A CONTROL FINAL FINAL SHAMBIG AND TRIPPING AND THE PROPERTY OF A CONTROL FINAL FINAL SHAMBIG AND STOCKPOOK AND THE STATE OF A CONTROL FOR A CONTROL FINAL SHAMBIG AND THE PROPERTY OF THE PROPER
- EXCAVATED TOPSOIL SHALL BE STOCKPILED ON THE SITE IN AREAS DESIGNATED BY THE PROJECT ENGINEER WITH, SUCH TIME THAT THIS TOPSOIL CAN BE USED FOR INNAL, SEADNIS, LINESS OTHERWISE NOTEON TO THE PLANS A MINIMAN OF 6" TOPSOIL RE-SPREAD AND SEEDING FOR ALL DISTURBED AREAS IS REGULIED.
- THE SOLS INVESTIGATION REPORT FOR THE SITE AND ALL ADDRING THERETO AND SEPORTING DOCUMENTS FOR THIS PROJECT, THE MEDICANE SEPORTING DOCUMENTS FOR THIS PROJECT, THE MECAPROPARTED THIS THE PROJECTION INTO THE PROJECTION FOR THE PRESENCE AND SHALL BE FIGURATED BY ALL CONTRACTORS, THE GRADNIG OPERATIONS ARE TO BE CLOSELY SEPORTION FOR INFECTIOD, PARTICULARLY DINNEY REPROJECT OF BUILDING FOR THE PROJECT OF THE PR
- ALL TESTINS, INSPECTION AND SUPERVISION OF SOIL QUALITY, INSUITABLE SOIL REMOVAL AND ITS REPLACEMENT AND OTHER SOILS RELATED OPERATIONS SHALL BE ENTRELLY THE RESPONSIBILITY OF THE CONTRACTOR.
- . THE CONTRACTOR SHALL USE CARE IN GRADING NEAR TREES, SHRUBS, AND BUSHES WHICH ARE NOT NOTED TO BE REMOVED SO AS NOT TO CAUSE INJURY TO ROOTS OR TRUNKS.
- THE CONTRACTOR SHALL USE CARE IN GRADING OR EXCAVATING NEAR ANY AND ALL EXISTING ITEMS WHICH ARE NOT INDICATED TO BE REMOVED. ANY DAMAGE DONE TO THESE EXISTING ITEMS BY THE CONTRACTOR'S OPERATIONS SHALL BE REPAIRED AT HIS OWN EXPENSE.
- REMOVED DRIVEWAY PAVEMENT, SIDEWALK, CURBS, TREES AND STUMPS SHALL BE DISPOSED OF LEGALLY OFF-SITE AT LOCATIONS DETERMINED BY THE CONTRACTOR.
- IO. PROPOSED ELEVATIONS INDICATE FINSHED GRADE CONDITIONS, FOR ROUSH GRADING ELEVATIONS ALLOW FOR THE THICKNESS OF THE PROPOSED PAVING (ROADS, WALKS, DRIVE, ETC.) SECTION OR TOPSOIL AS INDICATED ON THE PLANS.
- CONTRACTOR SHALL PROVIDE SMOOTH VERTICAL CURVES THROUGH THE HIGH AND LOW POINTS INDICATED BY SPOT ELEVATIONS ON THE PLANS. CONTRACTOR SHALL PROVIDE INFORM SLOPES BETWEEN NEW AND EXISTING GRADES AND AVOID ANY RIDGES AND/OR DEPRESSIONS.
- ALL PROPOSED GRADING, PAVEMENT, APRONS, CURBS, WALKS, ETC. SHALL MATCH EXISTING GRADES FLUSH.
- ALL EXISTING AND PROPOSED TOP OF FRAME ELEVATIONS FOR STORM, SANITARY, MATTER AND OTHER UTILITY STRUCTURES SHALL BE ADJUSTED TO MEET FINISHED GRADE MITHIN THE PROJECT LIMITS.
- 14. ALL CONCRETE POURED SHALL BE:
- I4.I. MINIMM COMPRESSIVE STRENSTH: I4.I.I. 8500 P.S.I. AT I4 DAYS (PER I.D.O.T.) I4.I.2. 4500 P.S.I. AT 26 DAYS (PER A.C.I.)
- 14.2. MAX WATER-GEMENTITIOUS MATERIALS RATIO: 0.44 (AIR-ENTRAINED)
- I4.3. AIR CONTENT: 6%, +/- I.5% AT POINT OF DELIVERY FOR EXPOSED CONCRETE
- 15. WHEN PIBER MESH REINFORCEMENT IS SPECIFIED, IT SHALL CONSIST OF PIBRINATED POLYRROW/LIBE FIBERS BIGHIERED AND DESIGNED FOR USE IN CONCRETE RAYMEDIT, CORPLYING WITH ASTAL OIL (III, TYPE III, TO \$\frac{3}\$ INCHES LONG, FIBERS SHALL BE UNFORMLY DISPESSED IN THE CONCRETE MIXTURE AT THE MANAFACTIORER'S RECORDERINDER ATILE DIT NOT LESS HAND IS LIBE / CUI.
- 16. THE GRADING AND CONSTRUCTION OF THE PROPOSED PAVEMENT IMPROVEMENTS SHALL NOT CAUSE PORDING OF STORM MATER. ALL AREAS ADJACENT TO THESE IMPROVEMENTS SHALL BE GRADED TO ALLOW POSITIVE DRAINAGE AND MATCH EXISTING GRADES FLUSH.
- IT. CONTRACTOR SHALL ENSURE POSITIVE SITE DRAINAGE AT THE END OF EACH MORKING DAY DURING CONSTRUCTION OPERATIONS, FAILURE TO PROVIDE ADEIGNATE DRAINAGE MILL PRECLIDE THE CONTRACTOR FROM MAY POSSIBLE COMPENSATION REQUESTED DUE TO DELAYS OR UNSUITABLE MATERIALS CREATED AS A RESULT.
- Iô. DRIVENAYS SHALL BE CONSTRUCTED SO AS NOT TO IMPEDE THE SURFACE DRAINAGE SYSTEM.
- IR. TRAFFIC CONTROL DEVICES SHALL BE IN CONFORMANCE WITH THE ILLINOIS DEPARTMENT OF TRANSPORTATION STANDARDS AND SHALL BE INSTALLED AND PROVIDED HEBEVER CONSTRUCTION FOR UTILITIES ARE NITHIN STREET AREAS, APPLICABLE ORDINANCES OF THE MINICIPALITY, COUNTY OR STATE SHALL ALSO SOVERN THE TRAFFIC CONTROL REGUIREMENTS.

#### WATER MAINS AND SEWERS HORIZONTAL SEPARATION

- MATER MAINS SHALL BE LOCATED AT LEAST TEN (IO) FEET HORIZONTALLY FROM ANY EXISTING OR PROPOSED DRAIN, STORM SEWER, SANITARY SEWER, COMBINED SEWER, SEWER SERVICE CONNECTION.
- 2. WATER MAINS MAY BE LOCATED CLOSER THAN TEN (IO) FEET TO A SEMER LINE WHEN:
- 2.I. LOCAL CONDITIONS PREVENT A LATERAL SEPARATION OF TEN (IO) FEET;
- THE WATER MAIN INVERT IS AT LEAST EIGHTEEN (IB) INCHES ABOVE THE CROWN OF THE SEMER; AND
- THE WATER MAIN IS EITHER IN A SEPARATE TRENCH OR IN THE SAME TRENCH ON AN UNDISTURBED EARTH SHELF LOCATED TO ONE SIDE OF THE SEVER.
- 5. WEN IT IS INPOSSIBLE TO MEET IJ OR 2) ABOVE, BOTH THE WATER MAIN AND DRAIN OR SERVER WALL BE CONSTRUCTED OF SUP-COLOR MECHANICAL JOINT PRE-SPRESSED CONCRETE IPING, OF PVC PIETE GUIVALIENT TO WATER MAIN STANDARDS OF CONSTRUCTION, THE DRAIN OR SERVER SHALL BE PRESSURE TESTED FOR THE MANIMAN BOTSETIED SECURISHE FEAD PRIOR OF THE MAINTEN FENDER TESTED FOR THE MANIMAN BOTSETIED SECURISHE FEAD PRIOR OF THE MANIMAN BOTSETIED SECURISHED FEAD PRIOR OF THE PRIOR OF THE MANIMAN BOTSETIED SECURISHED FEAD PRIOR OF THE PRIOR OF THE

#### SANITARY SEWERS

- ALL ANTIANY SINCE CONSTRUCTION SHALL BE IN ACCROUNCE INTH THE STANDARD SPECIFICATIONS FOR ANTIRE AND SINCE CONSTRUCTION IN LILINGS; LATEST EDITION, AND ALL SUBSEQUENT REVISIONS THERETO (STANDARD SPECIFICATIONS), AN SPECIAL PROVIDENCE, THE NOTES ON THE COYARDING SHALL SHAL
- ALL SANTARY SEVER PIPE AND STRUCTURES SHALL BE FURNISHED AND INSTALLED IN ACCORDANCE WITH DIVISION III OF THE "STANDARD SPECIFICATIONS."
- ALL SANITARY SEVER PIPE SHALL BE POLYVINYL CHLORIDE (PVC) SDR 26 PIPE PER ASIM D-3034 WITH WATERTIGHT JOINTS CONFORMING TO ASTM D-3212, UNLESS OTHERWISE NOTES.
- 3.1. IMPERE SANITARY SEMER PIPE IS NOTED AS PVC C-400, THE PIPE SHALL BE IN ACCORDANCE WITH AMERICAN MATER MORKS ASSOCIATION (AMMA) C-400 MITH MATERITIOHT, PRESSURE RATED JOINTS CONFORMING TO ASTM D-3199.
- SANITARY SENER CONSTRUCTION SHALL COMMENCE AT THE EXISTING MANHOLE(S) AND/OR CONNECTION POINT(S) INDICATED ON THE PLANS.
- 4.1. A MATERTIGHT PLIJO SHALL BE INSTALLED AND LEFT IN PLACE AT THE POINT OF COMMENCEMENT WITTL THE REMAINDER OF THE PROPOSED SHERS HAVE BEEN CONSTRUCTED, PROPERLY TESTED AND DEEMED READY FOR FINAL ACCEPTANCE.
- ALL SANTARY SENER TRENCH EXCAVATIONS AND PIPE FOUNDATION, BEDDING AND HAINCHING SHALL BE CONSTRUCTED IN ACCORDANCE WITH THE APPLICABLE SECTIONS OF DIVISION II OF THE "STANDARD SPECIFICATIONS."
- 5.1. ALL SANITARY SENERS MIST BE PLACED ON PROPRIETY COMPACTED STOKE DECOMING HISTORIA. SHALL BE A NINIMM OF FOUR MATERIAL SHALL BE CARBON OF THE DECOMING HISTORY SHALL BE CARBON OF THE PIET PER ASTH D-2321. PIET BEDDING MATERIAL SHALL BE CRUSHED GRAVEL OR STOKE MEETING DOT GRADATION CA-II OR CA-II OR STOKE MEETING DOT GRADATION CA-II OR CA-II OR
- 5.2. TRENCH BACKFILL MATERIAL SHALL BE PLACED AND COMPACTED TO A MINIMAM OF 498 MODIFIED PROCITOR DENSITY, PER ASTM D-1957, OVER ALL SANITARY SENERS WHICH ARE CONSTRUCTED UNDER, OR MITHIN TWO (2) FEET OF, ANY PROPOSED OR EXISTING PAYEMENT, PARKING LOTS OR SIDEMALKS.
- DEFORMANCE IS REQUIRED TO RECORD HE LOCATION OF ALL SIMPERS

  THE CONTRACTOR IS REQUIRED TO RECORD HE LOCATION OF ALL SIMPERS
  REPRESENTATIVE. THE CONTRACTOR SHALL LOCATE ALL SIMPERS BY
  HEAGUSEDHER'S TO LOT CORRECTOR OF OTHER REPORTMENT SITE FRATILE AND
  DATE OF THE CONTRACTOR SHALL LOCATE ALL SIMPERS BY
  AND/OR CONSERS REPRESENTATIVE LIFEN FORLECT CONFLICTION. THIS
  BY CONTRACTOR SHALL ASSO INCLUDE THE DEPTH OF PLOYS SEVERS IF THE
  RESPONSIBLE FOR ALL COSTS WHICH AME INCLURED AS A RESULT OF THE
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  RESPONSIBLE FOR ALL COSTS WHICH AME INCLURED AS A RESULT OF THE
  RESPONSIBLE FOR ALL COSTS WHICH AME INCLURED.
- ALL SANTARY SEVER MANHOLES SHALL BE PRECAST CONCRETE AND SHALL BE FURNISHED AND INSTALLED IN ACCORDANCE WITH THE APPLICABLE PORTIONS OF DIVISION II, SECTION 32 OF THE "STANDARD SPECIFICATIONS" AND THE DETAILS IN THE PILANS.
- AND THE DETAILS IN THE FLAME.

  11. A FLORING ETTEL JOINT SHALL BE FLRINSHED AT POINTS OF ENTRY INTO AND ENTRING PROOF MANAGLE STRUCTURES AND SHALL BE OF A DESIGN APPROVED BY THE BENERIES PROOK TO INSTALLATION, THE FLEXIBLE PROPERTY OF THE PROOK TO SHALLAND, THE PROPERTY OF THE PROOF TH
- ALL REGUIRED MANHOLE RIM ADJISTMENTS SHALL BE MADE WITH PRECAST CONCRETE ADJISTING RINGS NOT TO EXCEED A MAXIMM OF EIGHT (8) INCHES IN CYRRALL RIGHIST, A MAXIMM OF TWO (2) ADJISTING RINGS ARE ALLOWED. BUTHLROPE JOINT SEALANT SHALL BE USED ON ALL JOINTS DETIVEDS THE PRECAST ELEMENTS.
- AFTER FINAL ADJISTMENTS HAVE BEEN MADE, ALL JOINTS IN PRECAST STRUCTURES SHALL BE MORTARED, THE MORTAR SHALL BE COMPOSED OF ONE (I) PART CEMENT TO THEE (B) PARTS SAND, BY VOLUME, BASED ON DRY MATERIALS, AND SHALL BE THOROUGHLY METTED BEFORE LAYING.
- IO. WHEN CONNECTING TO AN EXISTING SEMER MAIN BY MEANS OTHER THAN AN EXISTING MYE, TEE, OR MANIOLE, THE FOLLOWING METHOD SHALL BE USED:
- IO.I. CIRCULAR SANI-CUT OF SEMER MAIN BY PROPER TOOLS (SEMER-TAP) MACHINE OR SIMILARI AND PROPER INSTALLATION OF HUB-MYE SADDLE OR HUB-TEE SADDLE.
- II. ALL FLOOR DRAINS SHALL BE CONNECTED TO THE SANITARY SEMER, ALL FOOTING DRAINS AND DOWNSPOUTS SHALL DISCHARGE ONTO THE GROUND OR INTO THE STORM SEMER SYSTEM AS INDICATED ON THE DRAMINGS.
- 12. UPON COMPLETION OF THE SANITARY SEMEN CONSTRUCTION, INCLUDING THE SERVICE LINES, ALL SEMENS SHALL BE TESTED IN ACCORDANCE WITH SECTIONS 9-11,2 AND 9-11.03 OF THE "STANDARD SPECIFICATIONS" AND WITHESSED BY THE LOCAL GOVERNING AUTHORITY OR AUTHORIZED REPRESENTATIVE.

#### WATER MAINS

- MATER MANS

  ALL MATER MAN CONSTRUCTION SHALL BE IN ACCORDANCE MITH THE

  "STANDARD SPECIFICATION FOR HATER AND SHERE CONSTRUCTION IN

  LINIOS', LATER TOTION (STANDARD SPECIFICATION), ANY SPECIAL

  CONSTRUCTION OF THE STANDARD SPECIFICATION OF THE STANDARD SPECIFICATION OF THE STANDARD SPECIFICATION OF THE STANDARD SPECIFICATION.

  AND CONSTRUCTION SHALL THAN PROCESSING. BRONSEED AND SHALL BE

  IN ACCORDANCE MITH DYNSON IV OF THE "STANDARD SPECIFICATION".

  ALL MATER MAN SHALL BE DICTUTE ERROR IPPEC LAND STANDARD SPECIFICATION.

  AND C-IOS, NALESS OTHERWISE MOTED AND STANDARD SPECIFICATION OF THE PROPERTY OF SPECIFICATION.

  AND C-IOS, NALESS OTHERWISE MOTED SHALL BE SECURIOR. TO FOR ITS PROPERTY AND SPECIFICATION.

  AND CONTROL THE MANS IN SPECIFICATION OF THE PROPERTY OF THE ANIMAL PROPERTY OF THE PROPE

- ALL NATES MAINS MIST BE FLACED ON PROPERLY COMPACTED STORE BEDONIE, PIRE BEDONIE MATERIAL, SHALL BE, A MINIMOM OF FOX (4) INCHES THICK WILDER THE BANGEL, OF THE PIRE IMPERIONS MATERIAL CALL DE CASE ORACIL. OF STORE METING INDICATOR OR MORADITOR CASE. THE CASE HACK THE MATERIAL SHALL BE PLACED AND COMPACTED TO A MINIMOM OF 80% MOOFTED PROCTOR DESIGN, THE AND THE JOST, OVER ALL NATES MAINS MINIMOM ARE CONSTRUCTED MORES, OR WITHIN TOO (2) PERFORM ON THE CONTRIBUTED MORES ON WITHIN TOO (2) PERFORM ON THE CONTRIBUTED MORES ON WITHIN TOO (2) PERFORM ON THE CONTRIBUTED MORES ON WITHIN TOO (2) PERFORM ON THE CONTRIBUTED MORES ON WITHIN TOO (2) PERFORM ON THE CONTRIBUTED MORE ON THE CONTRIBUTED MORES ON WITHIN TOO (2) PERFORM ON THE CONTRIBUTED MORE ON THE CONT
- FETT OF ANY PROPOSED OR BUSTING PAMENTAL PARKING LUTE OR

  A THERTON THAN SHALL BE FAZED IN THE BUD OF THE WATER MAIN PIPE
  ATTENDED THAN SHALL BE FAZED IN THE BUD OF THE WATER MAIN PIPE
  ATTENDED THAN OF THE MAIN COMMISSION ALL MATER MAIN SHALL
  BE TESTED IN ACCORDANCE WITH THE FOLLOWING MINIMAL STANDARDS.

  BUT THE TOTAL OF THE SHALL BE THE STANDARD SHOP THE STANDARDS
  BY THE LOCAL GOVERNING AUTHORITY.

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#### WATER SERVICES AND CONNECTIONS

- ALL MATER SERVICE LINES 2" IN DIAMETER OR SMALLER SHALL BE TYPE X'.
  COPPER TUBING COMPORMING TO ASTM 8-56-56. NO COUPLINGS SHALL BE
  PERMITTED BETWEEN THE COMPORATION AND CURB STOPS OR BETWEEN THE
  CURB STOP AND THE BUILDING.
- SERVICE BOXES SHALL BE OF SUFFICIENT LENGTH TO PERMIT THE TOP TO BE INSTALLED FLUXH WITH THE FINISHED GRADE. EACH SERVICE BOX SHALL BE PROVIDED WITH A CAP WITH THE MORD "NATER" CAST IN THE TOP.
- ALL VALVES, VALVE BOXES OR VAILTS SHALL BE CONSTRUCTED IN ACCORDANCE WITH THE PROVISIONS OF DIVISION IV, SECTION 44 OF "THE STANDARD SPECIFICATIONS."

- ALL TEMPORARY CONNECTIONS FOR CONSTRUCTION PURPOSES TO NEWLY INSTALLED OR EXISTING WATER MAINS SHALL BE MADE AND METERED IN ACCORDANCE HITH LOCAL REQUIREMENTS.
- IO, ALL REQUIRED RIM ADJUSTMENTS SHALL BE MADE WITH PRECAST CONCRETE ADJUSTING RINGS NOT TO EXCEED A MAXIMAM OF BIGHT (8) INCHES IN OVERALL RIBGHT, A MAXIMAM OF TWO (2) ADJUSTING RINGS ARE ALLOWED. BUTTLROPE JOINT SEALANT SHALL BE USED ON ALL JOINTS BETWEEN THE PRECAST BLIMPINTS.

#### WATER MAINS AND SEWERS VERTICAL SEPARATION REQUIREMENTS

- HATER HAIDS SHALL BE SEPARATED FROM A SERIER SO THAT ITS NUTRIL IS A MINISH OF THE PROBLEM OF TH
- IT IS IMPOSSIBLE TO OBTAIN THE PROPER VERTICAL SEPARATION AS DESCRIBED IN I ABOVE; OR
- 2.2. THE WATER MAIN PASSES UNDER A SEMER OR DRAIN
- 3. A VERTICAL SEPARATION OF BIGHTEIN (IB) INCHES BETWEEN THE INVERT OF THE SPIER OR BANIA NOT THE CACONS OF THE MATTER MAIN SHALL BE MAINTAINED MERGE A MAINTE MAIN CAROSSES UNDER A SIDER, THE SELECT OR THE MATTER MAIN, AS SHOWN ON THE PLANS OR AS APPROVED BY THE BISINEER.
- CONSTRUCTION SHALL EXTEND ON EACH SIDE OF THE CROSSING UNTIL THE FERTENDICULAR DISTANCE FROM THE WATER MAIN TO THE SEVER OR DRAIN LINE IS AT LEAST TEN (IO) FEET.

#### STORM SEWERS

- ALL RCP STORM SEIVER PIPE I2\* IN DIAMETER AND LARGER SHALL BE REINFORCED CONCRETE PIPE, CLASS IV, PER ASTM G-76 WITH FLEXIBLE (O-RING) GARGET JOINTS IN CONFORMANCE WITH ASTM C-445 AND SECTION SHILDOO OF THE "STANDARD SPECIFICATIONS." ALL IO\* DIAMETER RCP STORM SEVER PIPE SHALL BE REINFORCED CONCRETE PIPE, CLASS V.
- ALL HOPE STORM SEVER PIPE SHALL BE RIGID HIGH DENSITY POLYETHYLENE PIPE WITH CORRUPATED EXTREME AS SHOOTH INTERCEM MEETING ASSISTED AS SHOOTH AND SHOOTH AND THE ASSISTED ASSISTED AS SHOOTH AND THE PIPE WITH CARRIES CARRIES EXPELIENTATION & MADIAGON EXALL HIGHT OF EXCEPT THAT OF PIVE SOR 26 WITH RIGH-ON JOINTS, ALL HOPE STORM SEVER PIPE SHALL ONLY BE FOR PRIVATE USE.
- ALL PVC STORM SEINER PIPE SHALL BE POLYVINYL CHLORIDE SDR 26 PIPE PER ASTM D-3034 MITH MATERTIGHT JOINTS CONFORMING TO ASTM D-3212, UNLESS OTHERWISE MOTERS.
- ALL STORM SENER TRENCH EXCAVATIONS AND PIPE FOUNDATION, BEDDING I HAINCHING SHALL BE CONSTRUCTED IN ACCORDANCE NITH THE APPLICABLE SECTIONS OF DIVISION II OF THE "STANDARD SPECIFICATIONS."
- ALL STORM SENERS MUST BE PLACED ON PROPERLY COMPACTED STONE BEDDINS, PIER BEDDINS MATERIAL, SHALL BE A MINIMO MO FOUR (4) INCHES THICK MODER THE BARREL OF THE PIER AND FOR FVC PIER, MATERIAL, SHALL BE EXTENDED A MINIMOM OF TO OVER THE TOP OF THE PIER PIER ASTENDAL SHALL BE CARDINED MATERIAL. SHALL BE CARDINED MATERIAL, SHALL BE CARDINED MATERIAL, SHALL BE CARDINED GRAVEL OR STONE MEETING IDOT GRADATION CA-T, CA-II OR CA-II.
- 62. TRENCH BACKFILL MATERIAL SHALL BE PLACED AND COMPACTED TO A MINIMAM OF 49% MODIFIED PROCTOR DENSITY, FIRE ASTM D-1851, OVER ALL STORM SEMERS WHICH ARE CONSTRUCTED UNDER, OR WITHIN TWO (2) FEET OF, ANY PROPOSIED OR ENSTING PRAVENTI, PARKING LOTS OR SIDEPALKS.
- ALL REQUIRED STORM STRUCTURE RIM ADJISTMENTS SHALL BE MADE WITH PRECAST CONCRETE ADJISTING RINGS NOT TO EXCEED A MAXIMM OF EIGHT (8) NICHES IN OVERALL HEIGHT, ANAMIMM OF THO (2) ADJISTING RINGS ARE ALLOWED, BUTTLROPE JOINT SEALANT SHALL BE USED ON ALL JOINTS BETWEEN THE PRECAST ELEDENTS.

L WATER SERVICE PIPE AND STRUCTURES SHALL BE FURNISHED AND STALLED IN ACCORDANCE WITH DIVISION IV OF THE "STANDARD ECIFICATIONS."

VALVES SHALL BE AMERICAN FLOW CONTROL SERIES 2500 DUCTLE IRON RESILIENT SEAT EPOXY COATED NEDSE VALVES OR APPROVED EQUAL.

- ALL PRESSURE CONNECTIONS TO THE EXISTING WATER MAIN SHALL BE CONSTRUCTED IN ACCORDANCE WITH SECTION 46 OF THE "STANDARD SPECIFICATION" AND SHALL INCLUDE THE INSTALLATION OF A FULL STAINLESS STEEL TAPPING SADDLE.
- ALL VALVES SHALL BE INSTALLED IN VALVE VAILTS HAVING A MINIMM DIAMETER OF FIVE (5) FEET BELOW THE PRECAST CONCRETE COME SECTION. THE VAILTS SHALL BE CONSTRUCTED OF PRECAST CONCRETE SECTIONS AND SHALL CONFORM TO THE DETAILS SPECIFIED ON THE PLANS, ALL VALVE VAILTS SHALL BE LEAK PRODU

- 2. BOTH THE WATER MAIN AND SEMER SHALL BE CONSTRUCTED OF SLIP-ON OR MECHANICAL JOINT CAST OR DUCTILE IRON PIPE, ASBESTOS-CEMENT PRESSURE PIPE, PRE-STRESSED CONCRETE PIPE, OR PVC PIPE EQUIVALENT TO MATER HAIN STANDARDS OF CONSTRUCTION PHEM.

- ALL STORM SEMER CONSTRUCTION SHALL BE IN ACCORDANCE MITH THE 
  "STADARD SHEUPELATIONS FOR HATTER AND SEMER CONSTRUCTION IN LLINDIS," 
  TRANSCRIPTION STADARDS SHEUPELATIONS FOR KNOW AND BRIDGE OF 
  TRANSCRIPTION STADARDS SHEUPELATIONS FOR KNOW AND BRIDGE OF 
  CONSTRUCTION, LATEST EDITION ("BOT STADARDS SHEUPELATIONS"), ANY SHEGULA 
  PROVISION, THE MOTES ON THE PLANS, AND IN ACCORDANCE HITH THE CODES AND 
  ORDINANCES OF THE GOVERNION AUTORITIES. IN CASE OF CONFLICT, THE MORE 
  STRINGIST COST SHALL TAKET PRECEDENCE.
- ALL STORM SENER PIPE AND STRUCTURES SHALL BE FURNISHED AND INSTALLED IN ACCORDANCE WITH DIVISION Y OF THE "STANDARD SPECIFICATIONS" AND DIVISIONS 500 AND 600 OF THE "IDOT STANDARD SPECIFICATIONS."

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THE PRIDE OF KANE COUNTY 33W573 EAST MAIN STREET SAINT CHARLES, ILLINOIS 60174

ROA 555 LOPERS TELD IL 605 CIMA DEVELOPEI 30W180 BUTTERFII WARRENVILLE, II

ISSUE REV. SITE 8/19/19 1/13/2 REV. SITE 2/4/20

REV. SITE 2/19/2 REV. SITE 6/8/2

IOR-1910803C C-7.0

#### STORMWATER POLLUTION PREVENTION NOTES

- PREVENTION NOTES

  PREVENTION NOTES

  1. COPIES OF THE APPROVED STORM MATER POLITION RENVENTION FLANS
  SHALL BE HARTANED ON THE SITE AT ALL THE® ALCAS WITH THE PREVIT,
  MODERN OF INCLODES LANGE COLON FORM AND RESPECTION FORMS.
  AND ALL DESCRIPTION OF THE SITE ALL THE® ALCAS WITH THE PREVIT,
  ALL DESCRIPTION OF THE SITE ALS BEEN STABLUZED. THE
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- 12. CONTRACTORS SHALL MININATE BAKE BAKTH SARTHACES DURING
  12. CONTRACTORS SHALD MININATE BAKE BAKTH SARTHACES DURING
  13. ALL PISHINAPPE PAREAS SHALD BE SERED OR SODDED WITHIN INREE (3)
  14. DATS OF FIRAL DISTRIBUTION.
  15. DATS OF FIRAL DISTRIBUTION.
  15.

- OBTAIN NPDES AND OTHER APPLICABLE SITE PERMITS AND REVIEW PROJECTS STORMANTER POLLUTION PREVENTION PLAN (SWPPP). CONTRACTOR SHALL BE RESPONSIBLE FOR MAINTAINING AND UPDATING THE SWPPP THROUGHOUT THE DURATION OF CONSTRUCTION AS NECESSARY UNTIL FINAL SITE STABILIZATION IS ACHIEVED.
- 2. INSTALL STABILIZED CONSTRUCTION ENTRANCE.
- INSTALL PROTECTION DEVICES FOR EXISTING DRAINAGE INLET AND OUTLET STIDICTURES, IF APPLICABLE
- 5. FEBRIONE SCIONANCES ROLLINGNI RES, BRIDGI SITE INFECTIOLS ON A RESELT DASSE AND HITHIN TREPIT-FORM COM MORE OF THE BID OF A RAMPALL EXPET THAT IS OS THICH OR GREATER (OR EQUIVALENT SOMPHALL CONSTRUCTION SITE OF THE CONSTRUCTION SITE THAT HAVE FOR THE CONSTRUCTION SITE THAT HAVE FOR THE CONSTRUCTION SITE THAT HAVE FOR THE CONSTRUCTION SITE THAT HAVE SET THAT THAT THE STRUCTURAL CONTROL HEXAURES LOCATIONS MEETS VEHICLES BRITTED OR STRUCTURAL CONTROL HEXAURES IN THAT THAT HAVE THE STRUCTURAL SITE OF THAT THAT THAT THE STRUCTURAL SITE OF THAT THAT THAT THE STRUCTURAL DESTRUCTION SITE OF THAT THE STRUCTURAL SITE OF THE STRUCTURAL SIT
- ITS SYSTEM.

  SI ALL SITE EROSION AND SEDIMENT CONTROL MEASURES AND BEST MANAGEMENT FRACTICES SHALL BE THE RESPONSIBILITY OF THE ORDERAL DEATH OF THE CONTROL OF THE STORY OF THE CONTROL OF THE STORY OF THE THE CONTROL OF THE CONTROL OF THE STORY OF THE CONTROL OF THE CONTROL OF THE CONTROL OF THE STORY OF THE
- 5.2. CONTRACTOR IS RESPONSIBLE FOR INSTALLATION OF ANY ADDITIONAL STRUCTURAL CONTROL MEASURES NECESSARY TO PREVENT EROSION AND SEDIMENTATION AS DETERMINED BY THE SITE INSPECTIONS.
- PERFORM STREET CLEANING OPERATIONS AND OTHER BEST MANAGEMENT PRACTICES AS NEEDED.
- PERFORM SITE CLEARING AND GRUBBING AND REMOVE EXISTING VEGETATION AS NEIDED FOR INITIAL SITE GRADING OPERATIONS. VEGETATED SITE AREAS THAT ARE NOT INCLUDED WITH THE INITIAL GRADING SHALL REHAIN INDISTREED, ALL TOPSOIL STOCKPILES SHALL BE SUPROUNDED WITH SITE OF TOKEN OF FORMING THE STOCKFILE FINE AND STABLIZED WITHIN TRIFEE (3) DAYS OF FORMING THE STOCKFILE.
- 7. REMOVE ALL ITEMS NOTED FOR REMOVAL IN THE DEMOLITION PLAN.
- PERFORM ROUGH GRADING OPERATIONS, CONSTRUCT OVERFLOW ROUTES, AND STABILIZE ALL DISTRIBED AREAS, INCLUDING BUT NOT LIMITED TO STEEP SLOPES, DRAINAGE CHANGLES AND SYNLES (E.E. THEPORARY AND FERMANENT SEEDINS, ERGISIO CONTROL BLANKETS, RIP-RAP, CHECK DAYS, TEMPORARY DRAINAGE DIVERSIONS, EXC.
- 9. INSTALL TEMPORARY CONCRETE WASHOUT FACILITY.
- IO. INSTALL BUILDING FOUNDATIONS AND BEGIN BUILDING CONSTRUCTION.
- II. INSTALL DETENTION SYSTEMS, STORM SEVERS AND OTHER SITE UTILITIES AND IMMEDIATELY INSTALL DRAINAGE INLET AND OUTLET PROTECTION DEVICES AS INDICATED ON THE PLANS.
- PROVIDE TEMPORARY SEEDING AND/OR MULCHING FOR ALL DISTURBED SITE AREAS THAT WILL NOT BE WORKED ON FOR MORE THAN FOURTEEN (14) DAYS.
- INSTALL CURBS AND BEGIN SITE PAVING OPERATIONS (I.E. DRIVEWAYS, SIDEWALKS, ETC.).
- 14 COMPLETE BUILDING CONSTRUCTION AND REMAINING SITE IMPROVEMENTS
- REMOVE TEMPORARY SITE EROSION AND SEDIMENT CONTROL MEASURES WITHIN THIRTY (3O) DAYS OF FINAL SITE STABILIZATION.
- I6. SUBMIT A NOTICE OF TERMINATION (N.O.T.) TO THE ILLINOIS ENVIRONMENTAL PROTECTION AGENCY UPON COMPLETION OF ALL SITE CONSTRUCTION AND FINAL SITE STABILIZATION (IE. OVER TOR VEGETATIVE COVER).

SOIL EROSION AND SEDIMENT CONTROL CONSTRUCTION SCHEDULE OUP GR

THE PRIDE OF KANE COUNTY 33W573 EAST MAIN STREET SAINT CHARLES, ILLINOIS 60174


CIMA DEVELOPERS 30W180 BUTTERFIELD ROAD WARRENVILLE, IL 60555

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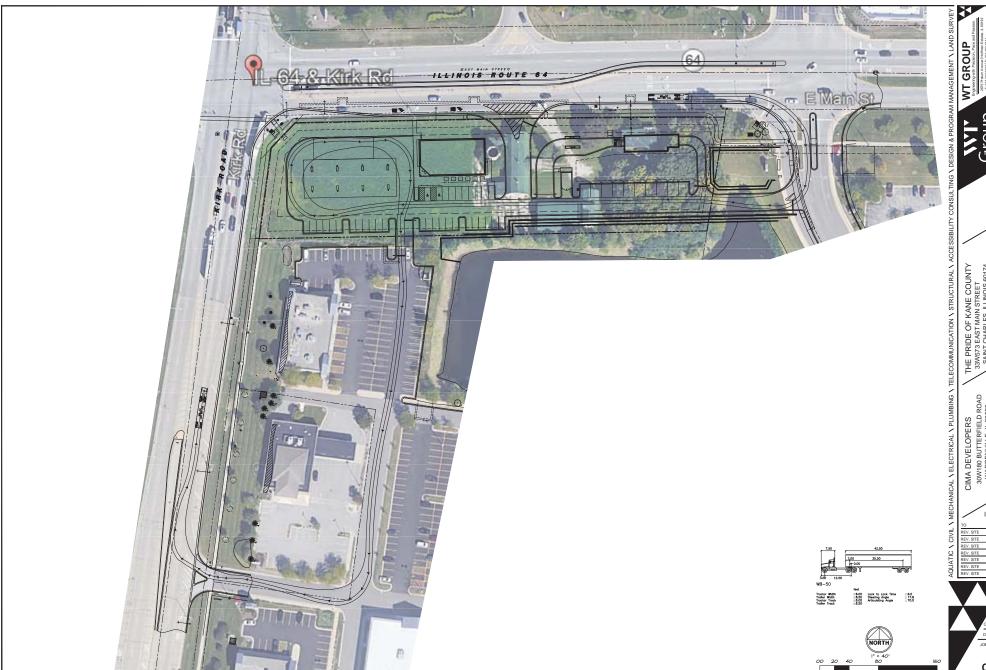
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THE PRIDE OF KANE COUNTY
33W573 EAST MAIN STREET
SAINT CHARLES, ILLINOIS 60174

CIMA DEVELOPERS 30W180 BUTTERFIELD ROAD WARRENVILLE, IL 60555

ISSUE TO DATE

REV. SITE 8/26/19

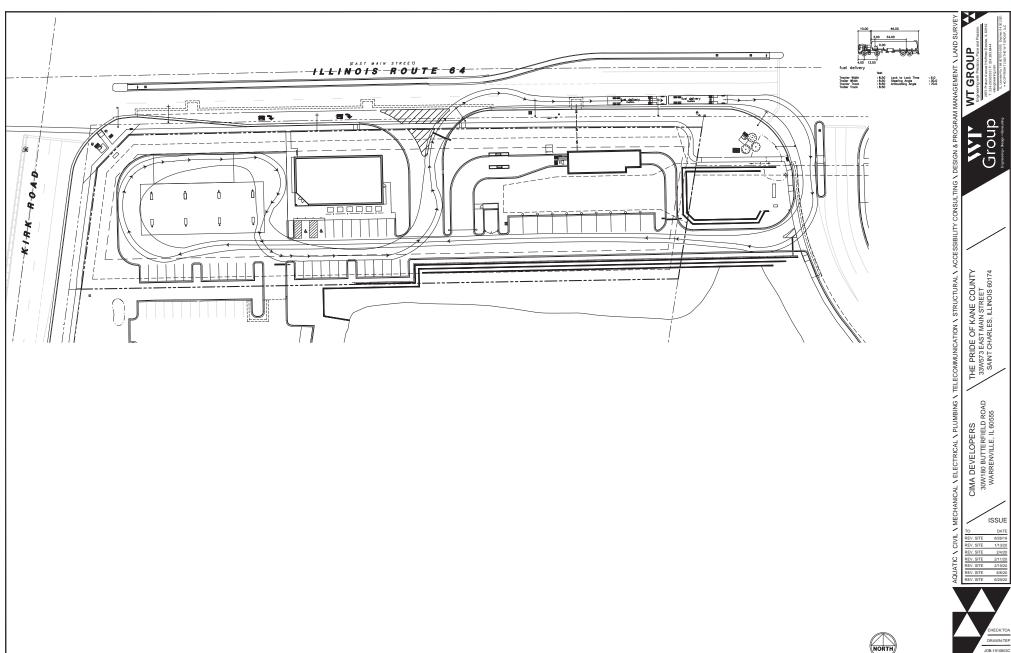REV. SITE 1/13/20

REV. SITE 2/14/20

REV. SITE 2/19/20

REV. SITE 2/19/20

REV. SITE 6/8/20


REV. SITE 6/29/20

CHECK:TOA

DRAWN:TEP

JOB:1910803C

C-9.0 FIRE APPARATUS CIRCULATION PLAN

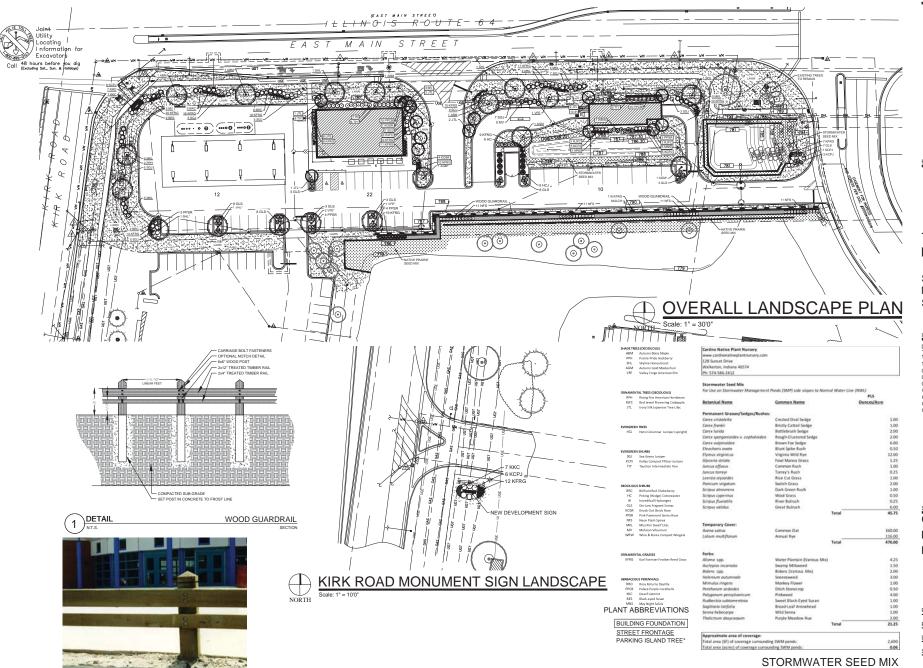

EXAMPLE OF WOOD GUARDRAIL

HELLER &
ASSOCIATES, ILC
LAN DEGREE ARCHITE CTURE
DO. BOR 1359
pt 202,089 133
double watershells as 147,1359
pt 202,089 133
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# THE PRIDE OF KANE COUNTY

Southeast Corner of Main St. & Kirk Rd. St. Charles, IL


ISSUANCE AND REVISIONS		
DATE	DESCRIPTION	
10.3.19	ISSUE TO OWNER	
10.25.19	REVISIONS	
03.03.20	REVISIONS	
05.15.20	CITY COMMENTS	
05.20.20	CITY COMMENTS	
05.28.20	REV. MONUMENT SIGN	
06.22.20	REVISED CIVIL	
07.21.20	REVISED CIVIL	
08.03.20	REVISED CIVIL	

ion contained herein is based on survey information, fie inspection, and believed to be accurate.

OVERALL LANDSCAPE PLAN

PR	ROJECT MANAGER	WDH
PR	ROJECT NUMBER	19-066
DΑ	ATE.	08.03.20
SH	HEET NUMBER	

L 1.0

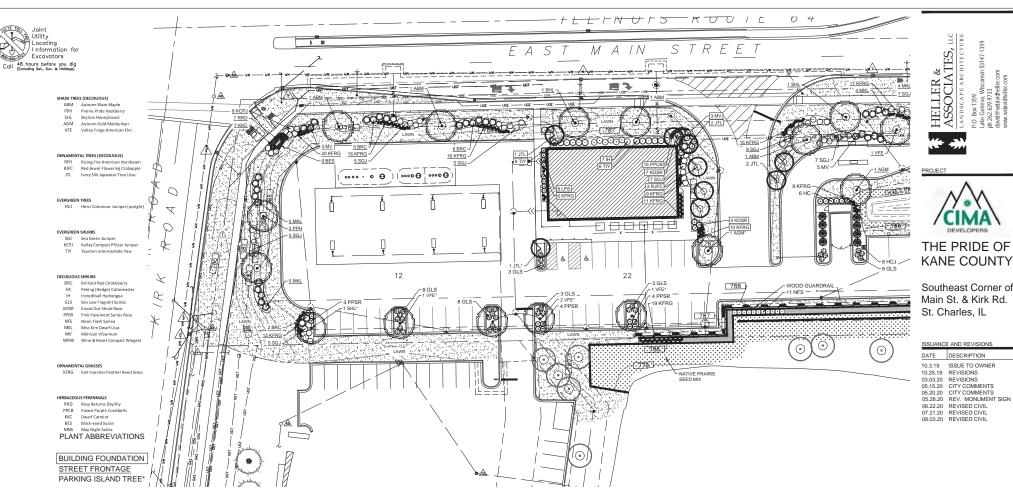




Information contained herein is based on survey information, file
SHEET TITLE
ENLARGED

ENLARGED LANDSCAPE PLAN

PROJECT MANAGER	WD
PROJECT NUMBER	19-06
DATE	08.03.2
SHEET NUMBER	

L 1.1

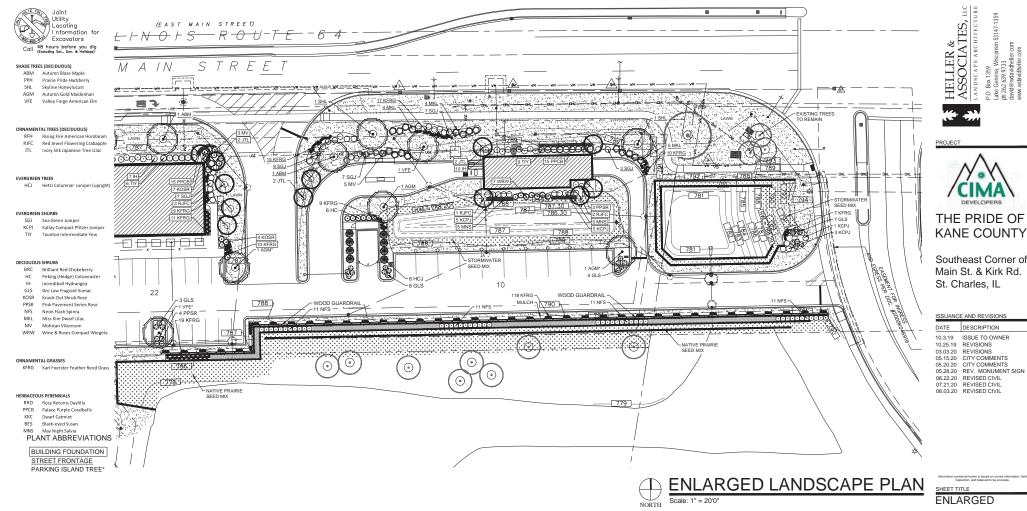

SHEET TITLE

ENLARGED LANDSCAPE **PLAN** 

WDH
19-066
08.03.20

L 1.2

PLANT & MATERIAL SCHEDULE

PLANTING & HARDSCAPE DETAILS

#### LANDSCAPE GENERAL NOTES

erww.cardnonativeplantnur 128 Sunset Drive Walkerton, Indiana 46574 Ph: 574-586-2412

Corex bicknettii / Corex brevio

Panicum virgatum Schizochyrium scopariu Big Bluestern Side-Oats Gramma

Prairie Sedge Min

Canada Wild Rye

Switch Grass Little Bluestern Indian Grass

Common Milkweed Butterfly Milkweed Smooth Blue Aster

New England Aster

NATIVE PRAIRIE SEED MIX

16.00 18.00 1.00 16.00 2.50 24.00 18.00

0.50 1.00 0.25 0.75 12.00 5.00 7.50 0.25 0.50 0.25 0.50 3.50 8.00

Botanical Name

Permanent Grasse

# THE PLANT IN COLUMN STREET PLANT IN COLUMN ST

INDSCAPE GENERAL NOTES

Information contained herein is based on survey information, inspection, and believed to be accurate.

SHEET TITLE

HELLER & ASSOCIATES, LEANDSCAPE ARCHITECTU


THE PRIDE OF KANE COUNTY Southeast Corner of Main St. & Kirk Rd. St. Charles, IL

08.03.20 REVISED CIVIL

LANDSCAPE
DETAILS, NOTES,
& SCHEDULES

PROJECT MANAGER	WDH
PROJECT NUMBER	19-066
DATE	08.03.20
SHEET NUMBER	

L 1.3

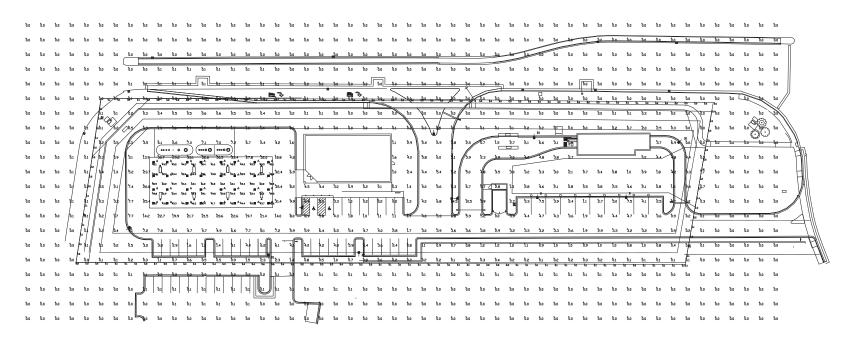

Luminaire Schedule									
Symbol	Qty	Label	Arrangement	Description	LLD	UDF	LLF	Arr. Lum. Lumens	Arr. Watts
=	32	A	SINGLE	SCV-LED-15L-SC-50 MTD € 15'	1.000	1.000	1.000	15410	103
-	3	В	SINGLE	SLM-LED-18L-SIL-FT-50-70CRI-SINGLE-16'PDLE+2'BASE	1.000	1.000	1.000	19664	148.5
-	6	B1	SINGLE	SLM-LED-18L-SIL-FT-50-70CRI-IL-SINGLE-16'PDLE+2'BASE	1.000	1.000	1.000	12568	148.5
	1	С	D180	SLM-LED-18L-SIL-FT-50-70CRI-D180-16'PDLE+2'BASE	1.000	1.000	1.000	39328	297

Calculation Summary						
CalcType	Units	Avg	Max	Min	Avg/Min	Max/Min
Illuminance	Fc	1.52	35.4	0.0	N.A.	N.A.
Illuminance	Fc	50.74	63.1	41.6	1.22	1.52
Illuminance	Fc	0.31	1.6	0.0	N.A.	N.A.
Illuminance	Fc	0.07	0.3	0.0	N.A.	N.A.
Illuminance	Fc	0.20	0.7	0.0	N.A.	N.A.
Illuminance	Fc	0.11	0.2	0.0	N.A.	N.A.
Illuminance	Fc	7.21	35.4	0.0	N.A.	N.A.
	Illuminance Illuminance Illuminance Illuminance Illuminance Illuminance Illuminance	Illuminance	Illuminance   Fc   1.52	Illuminance   Fc   1.52   35.4	Illuminance   Fc   1.52   35.4   0.0	Illuminance   Fc   1.52   35.4   0.0   N.A.



Click image to open Product Page

ased on the information provided, all dimensions and luminaire locations one represent recommended positions. The engineer and/or architect must eternine the applicability of the layout to existing or future field conditions

The lighting plan represents librarious invest construct of the plant plant plant perspective for the plant plant













02 - WEST ELEVATION
3/16" = 1'-0"

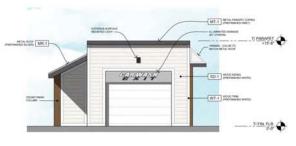

03 - EAST ELEVATION




04 - SOUTH ELEVATION

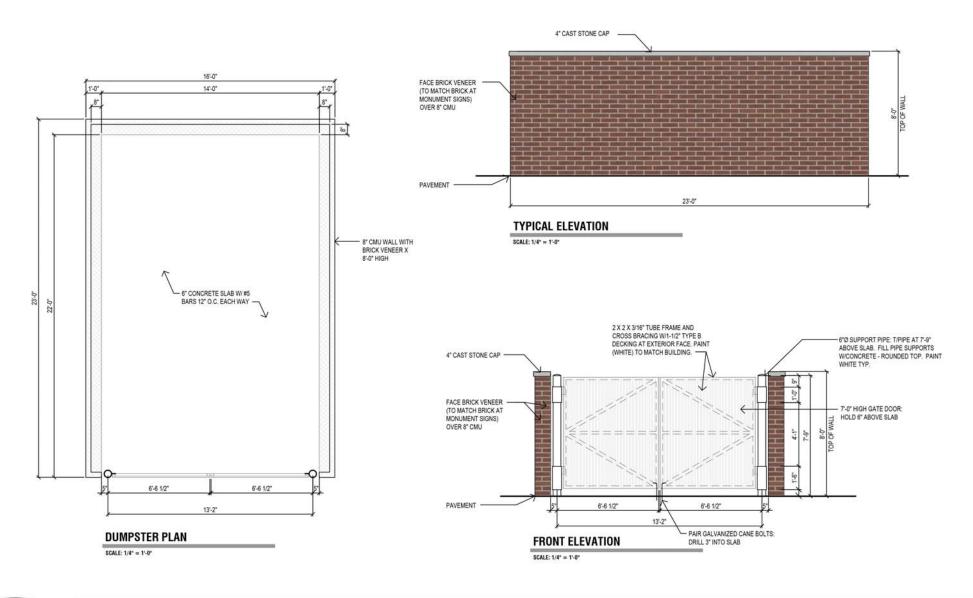






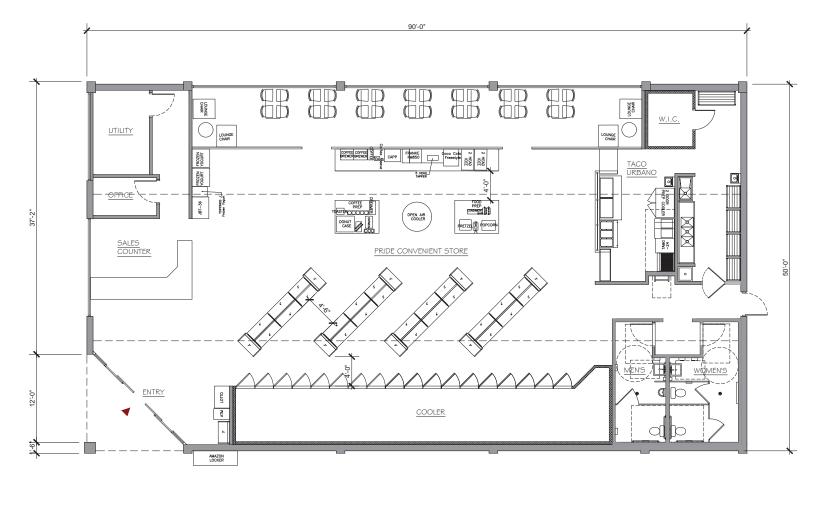


C - S T O R E P L A N

1/4" = 1'-0"



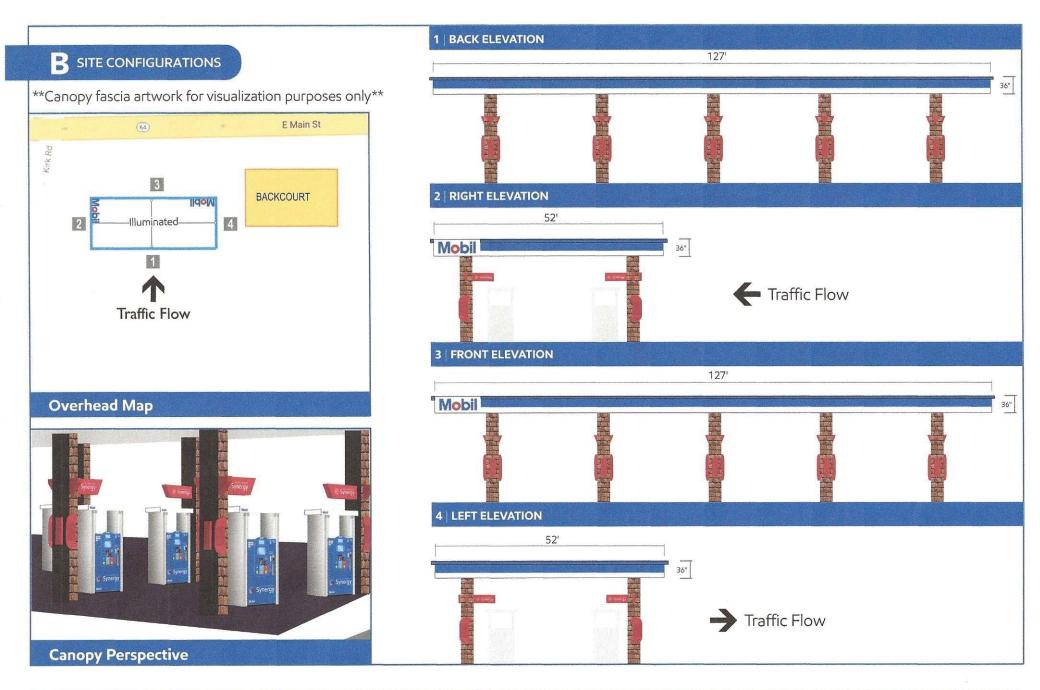

Project Name	PBL#	Customer	Created by	Bood Book
ExxonMobil	-	ExxonMobil	B.Dighero	Brand Book Site Image Materials Maintenance
Revision #	Date	Scale	Page #	2 Northfield Plaza, Ste 250 Northfield, IL 60093
R3	06_18_2020	NA	4 OF 13	P: (847) 441-1818 F: (847) 592-9564

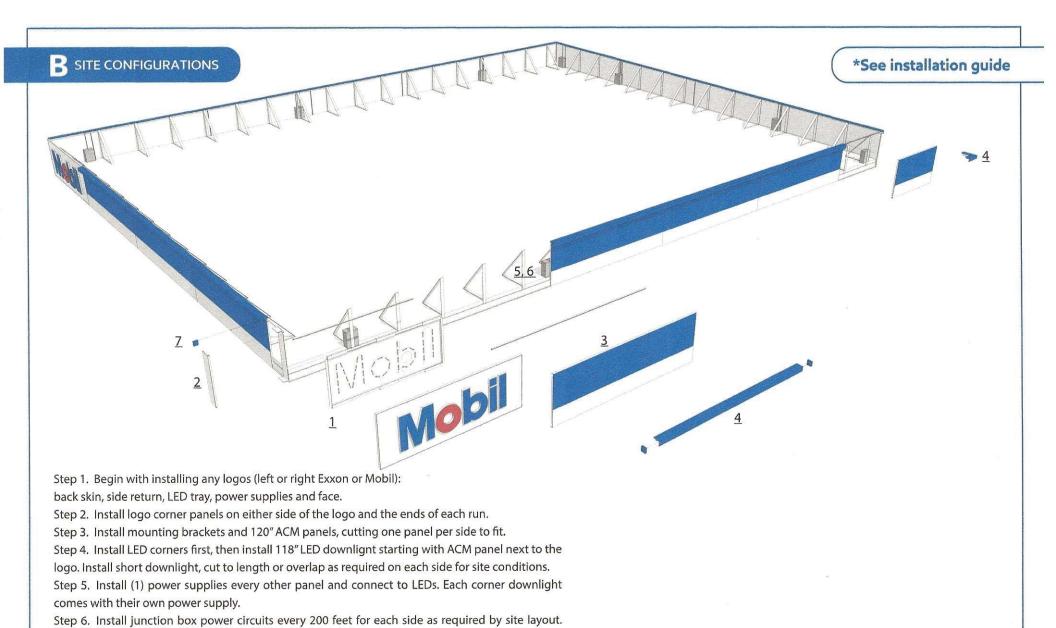


Project Name	PBL#	Customer	Created by	
ExxonMobil	· -	ExxonMobil	B.Dighero	Brand Book Site Image Materials Maintenance
Revision #	Date	Scale	Page #	2 Northfield Plaza, Ste 250 Northfield, IL 60093
R2	05/ 26/ 2020	NA	9 OF 16	P. (847) 441-1818 F: (847) 592-9564

Electrician to connect to 120VAC.

Step 7. Install end caps.

#### R SITE CONFIGURATIONS \*See installation guide #8 X 3/4" k-lathe screws 100.000" zinc plated, painted white 73.927" Qty: (6) @ top SINGLE LETTER SPECS: "M" = 2.88 sq ft 7.287" Translucent white sign grade #12 X 7 Tek screws "o" = 1.44 sq ftpolycarbonate (2447) with zinc plated, Qty: (10) "b" = 1.83 sq ft50% transmission Attaches .063 aluminum "i" = .80 sq ftback skin to canopy "I" = .83 sq ft36.000" TOTAL = 7.78 sq ft structure 36.000" 22.030" 22,445" 1.620" -O.D. LETTER SPECS: 22.445" X 73.927" = 11.5 SF SIGN SPECS: Translucent Mobil Blue vinyl 36" X 100" = 25 SF applied to front face: UL NUMBER: E84811 3M 3630-8248, PMS 293C Translucent Mobil Red vinyl 1.500" FRONT VIEW - PUSH THRU LETTERS IN FACE applied to front face: #8 X 3/4" k-lathe screws Appx weight of sign = 75lbs END VIEW 3M 3630-2590, PMS 485C zinc plated, painted white Qty: (6) @ bottom 99.625" (40) Streetfighter LED .72W / module 28.08W Total Power Supply w/ switch 60W power supply 120 - 277VAC 120VAC / 12VDC 1.1A - .45A 60W / 12VDC 35.625" .063" aluminum pre-paint white with 1/4" X 1" neoprene gasket PN 394204 **END VIEW** INTERNAL DETAILS **NIGHT VIEW**

Project Name	PBL#	Customer	Created by	Brand Book
ExxonMobil	-	ExxonMobil	B.Dighero	Site Image Materials Maintenance
Revision #	Date	Scale	Page #	2 Northfield Plaza, Ste 250 Northfield, IL 60093
R2	05/ 26/ 2020	NA	8 OF 16	P: (847) 441-1818 F: (847) 592-9564

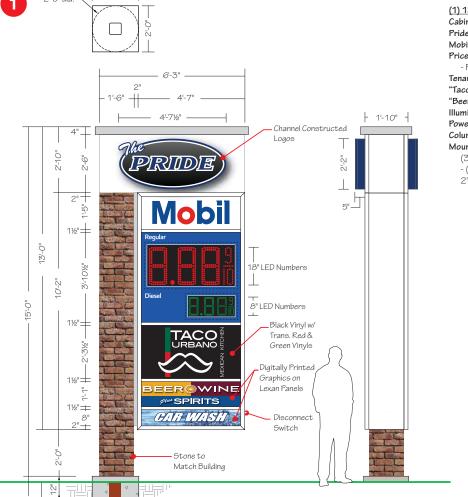

#### (1) 13'-0" x 6'-3" Double Face Illuminated Flag Mounted Sign - 81.25 SF

Cabinet: Fabricated Aluminum Painted White - Satin Finish

Pride Logos: 5" Deep Fabricated Channel Letter - Decorated White Acrylic Face - White LED Illumination

Mobile Logos: 3M 3630-97 Bristol Blue & 143 Poppy Red Translucent Vinyls Pricer Panel: 3M 3630-97 Bristol BlueTranslucent Vinyl - Copy Reversed Out White

- Pricer Units: 16" LED & 12" LED

Tenant Panels: White Polycarbonate

"Taco Urbano" Graphics: 3M 7725-12 Black / 3630-76 Holly Green / 3630-33 Red Vinyls "Beer Wine Liquor" & Car Wash Panels: White Polycarbonate w/ Digitally Printed Graphics

Illumination: White LEDs

Power: (2) 20Amp @ 120Volts Electrical Circuits Run to Site by Others

Column: CMU Block w/ Brick to Match Building

Mounting: (1) HSS 6" x 6" x 3/8" ASTM A-500 Gr. B with

(3) 4" x 4" x 3/16" ASTM A-500 Gr. B Steel Mounting Plates

- (1) 2'-0" dia. x 8'-0" deep Concrete Foundation w/

2'-0" W x 2'-0" L x 12" D Square Concrete Pad for Masonry



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www.parvinclauss.com

#### PROJECT:



SEC Kirk Road & Main Street (Rt. 64) St. Charles, IL

#### **CUSTOMER APPROVAL:**

DAT

AUTHORIZED SIGNATURE

#### REPRESENTATIVE

House / RM / KZ

DRAWN BY

Bill Marlow

DATE 10.23.19

SCALE 3/8" = 1'

SHEET NO.

WORK ORDER

82989

FILE NAME PRD82989

#### **REVISIONS:**

1 11.04.19 - center sundry cab

5.18.20 - new layout

3 5.19.20 - size adjustments

4 5.26.20 - Taco Urbano Logo


61020

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7

8

This sign is intended to be installed in accordance with the requirements of Article 600 of the National Electrical Code and/or other applicable local codes. This includes proper grounding and bonding of the sign.

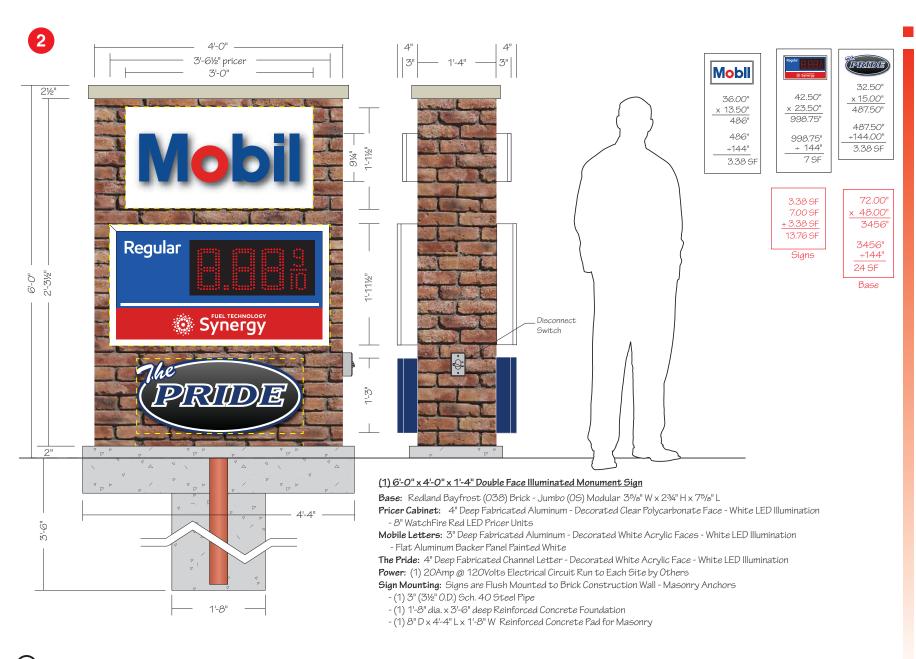

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SEC Kirk Road & Main Street (Rt. 64) St. Charles, IL

#### CUSTOMER APPROVAL:

DATE

AUTHORIZED SIGNATURE

#### REPRESENTATIVE

SHEET NO.

WORK ORDER

82989

1" = 11

2 of 12

FILE NAME PRD82989

#### **REVISIONS:**

11.04.19 - all cabs. on brick area


**2** 5.18.20

**3** 5.19.20

4 5.26.20 - Mobil letters / cab. depth

61020

o

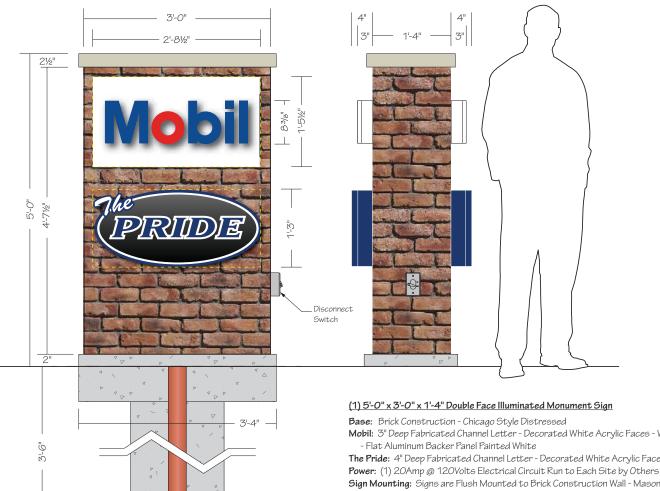

1'-8"

32.50" x 17.50" 568.75" 568.75" ÷144" 4 SF

(PRIDE 32.50" x 15.00" 487.50" 487.50" ÷144" 3.38 SF

4.00 SF + 3.38 SF 7.38 SF

Signs

2160" 2160" ÷ 144" 15 SF

60"

x 36"

Base

WORK ORDER

FILE NAME PRD82989

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**CUSTOMER APPROVAL:** 

House / RM / KZ

Bill Marlow

10.23.19

1" = 1'

3 of 12

82989

AUTHORIZED SIGNATURE

PROJECT:

St. Charles, IL

REPRESENTATIVE

DRAWN BY

DATE

SCALE

SHEET NO.

#### **REVISIONS:**

11.04.19

**2** 5.18.20

**3** 5.19.20

4 5.26.20 - Mobil letters / cab. depth

This sign is intended to be installed in accordance with the requirements of Article 600 of the National Electrical Code and/or other applicable local codes. This includes proper grounding and bonding of the sign.

#### (1) 5'-0" x 3'-0" x 1'-4" Double Face Illuminated Monument Sign

Mobil: 3" Deep Fabricated Channel Letter - Decorated White Acrylic Faces - White LED Illumination

The Pride: 4" Deep Fabricated Channel Letter - Decorated White Acrylic Face - White LED Illumination

Sign Mounting: Signs are Flush Mounted to Brick Construction Wall - Masonry Anchors

- (1) 3" (3½" O.D.) Sch. 40 Steel Pipe

- (1) 1'-8" dia. x 3'-6" deep Reinforced Concrete Foundation

-(1) 8" D x 3'-4" L x 1'-8" W Reinforced Concrete Pad for Masonry

### 12 4" Stand Off Rings 12 12 1-0 2'-6" -2-6

3-0

#### (1) Single Face Fingerpost Directional Sign

**Pole:** 4" Aluminum - Smooth - Painted Black - Ball Cap

Finger Panels: 125" Aluminum Painted Black w/ Reflective White Vinyl In-line Border

Mobil & The Pride Logos: Digitally Printed on White Vinyl Applied Panda Express Logo: Digitally Printed on White Vinyl Applied

Orangetheory Logo: 3M 7725-14 Bright Orange, 53 Cardinal Red & 31 Medium Gray Vinyls Applied

**STOP Sign:** (1) Std. 30" x 30" Applied to .125" thick Black Aluminum Backer Panel

- See Detail A for Attachment Hardware

Mounting: Direct Burial in 1'-0" dia. x 3'-6" deep Concrete Foundation



DETAIL A - Post Brackets

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#### **CUSTOMER APPROVAL:**

AUTHORIZED SIGNATURE

#### REPRESENTATIVE

House / RM / KZ DRAWN BY Bill Marlow DATE

10.23.19 SCALE

SHEET NO.

WORK ORDER

4 of 12 82989

3/4" = 1'

FILE NAME PRD82989

#### **REVISIONS:**

11.04.19

**2** 5.18.20

**3** 5.19.20

**4** 5.26.20

**5** 6.19.20









#### **NAN ALLIM RETURNS** 1" JEWELITE TRIMCAP .187 WHITE ACRYLIC .187 CLEAR POLYCARBONATE BACK 2" DEEP ALUMINUM BACKER PANEL PAIGE WALL BUSTER TWO-PART THROUGH WALL WIRING PROTECTION DEVICE LED POWER SUPPLY IN VENTED BOX LED STRIP LIGHTING MASONRY ANCHORS CLIP (TYP.) 1/4" DIA DRAIN HOLES (MIN 2 PER LETTER

#### 3" DEEP U/L APPROVED LED-ILLUMINATED CHANNEL LETTER - WIREWAY MOUNT

#### (1) 5'-45/8" x 11'-81/2" x 2" Deep SF Wall Sign w/ Illuminated Channel Letters

Panel: 2" Deep Fabricated Aluminum Painted PMS 288 Blue - Smooth Satin Finish

Faces: .125" Aluminum Painted PMS 288 Blue

Inline Strip: 3M 7725-10 White Vinyl

Black/Grey Gradient: Digitally Printed on Orajet 3751 RA White Vinyl Applied to Face

Letters & White In-line: Fabricated 3" Deep Channel Letters

"The" Returns: .040" Aluminum Painted PMS 288 Blue- 1" White Trimcap


"PRIDE" & In-line Returns: .040" Pre-finished White Aluminum - 1" White Trimcap

Faces: 7328 White Acrylic w/ Avery UC 900-684T PMS 288 Blue Translucent Vinyl Applied to Faces

Illumination: White LEDs with Remote 60Watt Power Supplies

Power: Use Existing at Site

Mounting: Flush to Building with Anchors Appropriate for Wall Construction

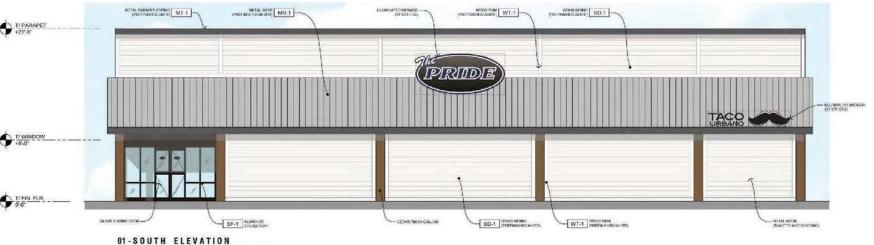

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REPRESENTATIVE

House / RM / KZ DRAWN BY

Bill Marlow DATE

10.23.19 SCALE

SHEET NO. 5 of 12

WORK ORDER

82989

1/2" = 1'

FILE NAME PRD82989

#### **REVISIONS:**

**2** 5.18.20

**3** 5.19.20

**4** 5.26.20

<sup>5</sup> 6.19.20 - New Elevation





#### (1) 5'-45/8" x 11'-81/2" x 2" Deep SF Wall Sign w/ Illuminated Channel Letters

Panel: 2" Deep Fabricated Aluminum Painted PMS 288 Blue - Smooth Satin Finish

Faces: .125" Aluminum Painted PMS 288 Blue

Inline Strip: 3M 7725-10 White Vinyl

Black/Grey Gradient: Digitally Printed on Orajet 3751 RA White Vinyl Applied to Face

Letters & White In-line: Fabricated 3" Deep Channel Letters

"The" Returns: .040" Aluminum Painted PMS 288 Blue- 1" White Trimcap


"PRIDE" & In-line Returns: .040" Pre-finished White Aluminum - 1" White Trimcap

Faces: 7328 White Acrylic w/ Avery UC 900-684T PMS 288 Blue Translucent Vinyl Applied to Faces

Illumination: White LEDs with Remote 60Watt Power Supplies

Power: Use Existing at Site

Mounting: Flush to Building with Anchors Appropriate for Wall Construction

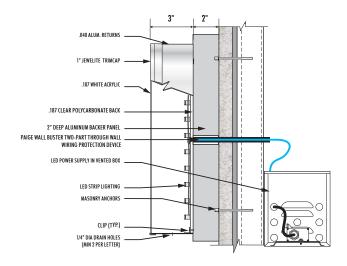

#### 3" DEEP U/L APPROVED LED-ILLUMINATED CHANNEL LETTER - WIREWAY MOUNT



#### 04-NORTH ELEVATION

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#### **CUSTOMER APPROVAL:**

AUTHORIZED SIGNATURE

#### REPRESENTATIVE

House / RM / KZ DRAWN BY Bill Marlow

DATE 10.23.19

SCALE

SHEET NO. 6 of 12

WORK ORDER

82989

1/2" = 1'

FILE NAME PRD82989

#### **REVISIONS:**

11.04.19

**2** 5.18.20

**3** 5.19.20

**4** 5.26.20

5 6.19.20 - New Elevation

### PROJECT:

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#### **CUSTOMER APPROVAL:**

5"

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REPRESENTATIVE

House / RM / KZ DRAWN BY

Bill Marlow

DATE

10.23.19

SCALE 1" = 1'

SHEET NO.

7 of 12

WORK ORDER

82989

FILE NAME PRD82989

#### **REVISIONS:**

**1** 11.04.19

**2** 5.18.20

**3** 5.19.20

**4** 5.26.20

<sup>5</sup> 6.19.20 - New Sign

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#### (2) 2'-11/2" x 11'-6" x 5" Deep SF Wall Sign

Cabinet: 5" Deep Fabricated Aluminum Painted PMS 288 Blue - Smooth Satin Finish


Faces: 3/16" White Poltcarbonate

Graphics: Digitally Printed on Translucent White Vinyl

Illumination: White LEDs with 12V 60W 120/277V Power Supplies

Power: Use Existing at Site

Mounting: Flush to Building with Anchors Appropriate for Wall Construction

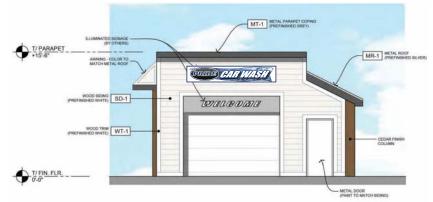




#### 04-SOUTH ELEVATION

Scale: 1/8" = 1'-0"

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This sign is built to UL Standards for operation in North America.

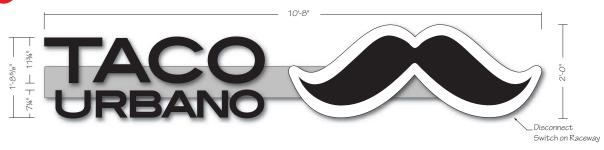

# 3.4" JEWELITE BLACK TRIMCAP 1.187 WHITE ACEPTLIC 1.188 WHITE ACEPTLIC 1.187 WHITE ACE


#### (1 set) 5" Deep Illuminated Channel Letters & Logo on Raceway

Letter & Logo Returns: .040" Fabricated Aluminum Prefinished Black

Letter Faces: White Acrylic w/ 3M 3635-222 Black Perforated Vinyl Applied - 3/4" Black Trimcap

Logo Face: White Acrylic W/3M 7725-12 Black Vinyl Applied - 3/4" Black Trimcap Raceway: Std. 8" Narrow - Extruded Aluminum Painted to Match Wall Color Illumination: White LEDs with 60Watt Power Supplies in Raceway

Power: (1) 20Amp @ 120Volt Electrical Circuit Run to Site by Others Mounting: Flush to Building with Anchors Appropriate for Wall Construction

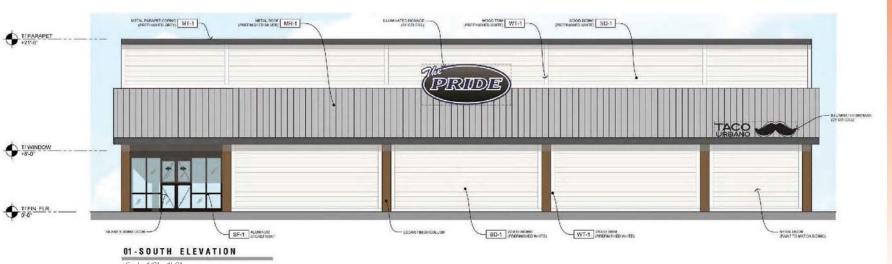

This sign is

This sign is built to UL Standards for operation in North America.

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#### **CUSTOMER APPROVAL:**

DATE

AUTHORIZED SIGNATURE

REPRESENTATIVE

House / RM / KZ

Bill Marlow

10.23.19 SCALE

3/4 " = 1'

8 of 12

WORK ORDER

FILE NAME PRD82989

82989

#### **REVISIONS:**

1 11.04.19

**2** 5.18.20


**3** 5.19.20

4 5.26.20

<sup>5</sup> 6.19.20 - New Elevation

.

8

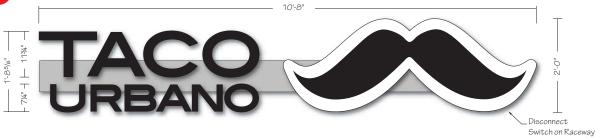

#### (1 set) 5" Deep Illuminated Channel Letters & Logo on Raceway


Letter & Logo Returns: .040" Fabricated Aluminum Prefinished Black

Letter Faces: White Acrylic w/ 3M 3635-222 Black Perforated Vinyl Applied - 3/4" Black Trimcap

Logo Face: White Acrylic w/ 3M 7725-12 Black Vinyl Applied - 3/4" Black Trimcap Raceway: Std. 8" Narrow - Extruded Aluminum Painted to Match Wall Color

Illumination: White LEDs with 60Watt Power Supplies in Raceway Power: (1) 20Amp @ 120Volt Electrical Circuit Run to Site by Others

Mounting: Flush to Building with Anchors Appropriate for Wall Construction

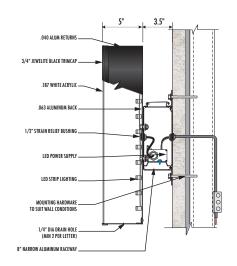

## WT-1 WOOD TRIM MT-1 METAL PARAPET COPE (PREFINISHED GREY)

SF-1 ALUMNUM

#### 04-NORTH ELEVATION

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#### **CUSTOMER APPROVAL:**

AUTHORIZED SIGNATURE

REPRESENTATIVE

House / RM / KZ

DRAWN BY Bill Marlow

DATE

10.23.19 SCALE

SHEET NO. 9 of 12

WORK ORDER

82989

1/2" = 1'

FILE NAME PRD82989

#### **REVISIONS:**

11.04.19

**2** 5.18.20

**3** 5.19.20

**4** 5.26.20

5 6.19.20 - New Elevation





Upside Down

#### (1 set each) 5" Deep Illuminated Channel Letters on Raceways - 8.45 SF / 14.40 SF

Returns: Fabricated Aluminum Painted PMS 288 Blue Faces: #7328 White Acrylic w/ 1" Jewelite White trimcap Vinyl: 3M 3630-157 Sultan Blue Translucent Vinyl


Raceways: Std. 7" x 7" Aluminum Painted to Match Wall Color - SW 7063 Nebulous White

Illumination: White LED

Power: (1) 20Amp @ 120Volts Electrical Circuit Run to Site by Others

Mounting: Raceways Flush Mounted to Building - Appropriate Hardware for Wall Construction

#### NOTE: FIELD SURVEY REQUIRED PRIOR TO FABRICATION

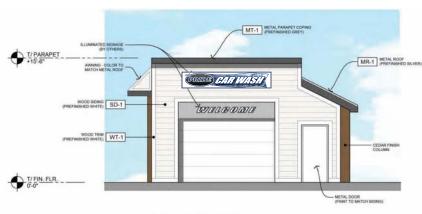

02-WEST ELEVATION

Scale: 1/8" = 1'-0"

MT-1 METAL PARAPET COPING METAL ROOF MR-1 SD-1 WOOD SIDE WT-1 WOOD TRS

03-EAST ELEVATION

Scale: 1/8" = 1'-0'

This sign is built to UL Standards

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AUTHORIZED SIGNATURE

REPRESENTATIVE House / RM / KZ DRAWN BY Bill Marlow

DATE 10.23.19

3/4" = 1'

10 of 12

SCALE

SHEET NO.

WORK ORDER

82989

FILE NAME PRD82989

#### **REVISIONS:**

11.04.19

**2** 5.18.20

**3** 5.19.20

**4** 5.26.20

5 6.19.20 - New Elevation



#### (1) 1'-6" x 27'-4" x 2" Single Face Non-Illuminated Entrance Gateway

Cabinet: Fabricated Aluminum Painted Black - Suede Satin Finish

- 2" x 2" Tube Internal Structure

Graphics: 3M 7725-37 Sapphire Blue & 7725-10 White Vinyls

Clearance Bar: 5" PVC Pipe w/ Caps Painted MAP 42248 Sundance Yellow Clearance Ht. Copy & Stripes: 3M 680-85 Black Reflective Vinyl

Bases: Masonry to Match Building - Redland Bayfrost (038) Brick

- Jumbo (OS) Modular: 35/8" W x 23/4" H x 75/8" L

Mounting: (2) 4" x 4" Tube Steel set into (2) 1'-6" dia. x 6'-0" deep Concrete Foundations

NOTE: FIELD SURVEY REQUIRED PRIOR TO FABRICATION

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REPRESENTATIVE House / RM / KZ DRAWN BY Bill Marlow

DATE 10.23.19 SCALE

3/8" = 1'

SHEET NO. 11 of 12

WORK ORDER

82989 FILE NAME PRD82989

#### **REVISIONS:**


11.04.19

**2** 5.18.20

**3** 5.19.20

5.26.20

**5** 6.19.20

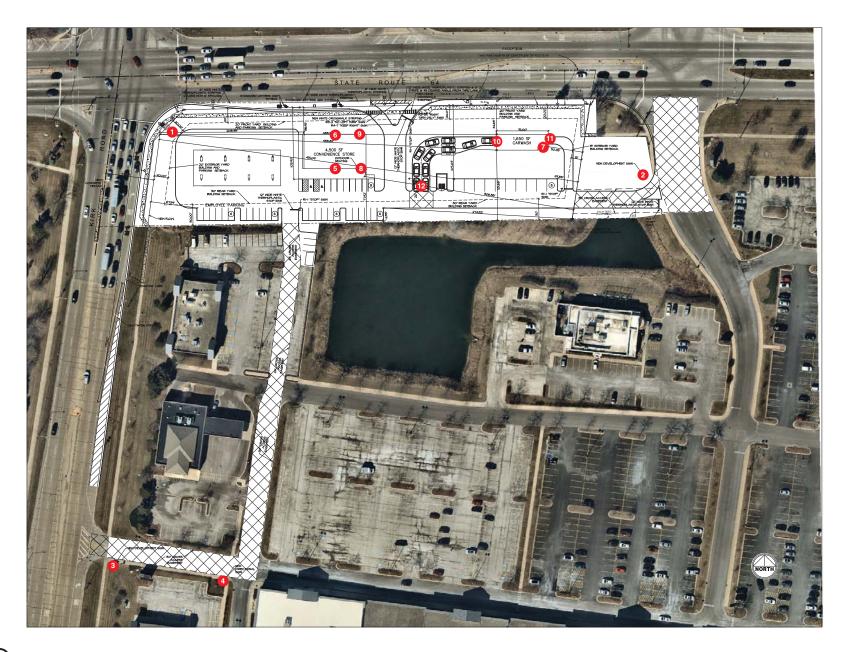

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#### REPRESENTATIVE

House/RM/KZ DRAWN BY

nts

Bill Marlow DATE

SCALE

SHEET NO.

WORK ORDER

82989

10.23.19

12 of 12

FILE NAME PRD82989

#### **REVISIONS:**

11.04.19

**2** 5.18.20

<sup>3</sup> 5.19.20

**4** 5.26.20

**5** 6.19.20



#### EXHIBIT "E"

#### **PUD DEVIATIONS**

Section 17.24.100 Drive-Through Facilities						
Stacking Lane Configuration	Two lanes of car wash vehicle stacking, as shown on the PUD Preliminary Plan.					
Section 17.26.080 Building Found	Section 17.26.080 Building Foundation Landscaping					
Foundation Landscape Planting Beds	3 ft. along west side of convenience store building, as shown on the PUD Preliminary Plan.					
Foundation Landscape Trees	3 trees along the north wall of the convenience store building and 2 trees along the north wall of the car wash building, as shown on the PUD Preliminary Plan.					
Section 17.26.090 Public Street Frontage Landscaping						
Street Frontage Plantings	Less than 75% of the Main St. frontage may be landscaped, as shown on the PUD Preliminary Plan.					
Table 17.28-2 Permitted Signs for Business & Mixed-Use Districts – BL, BC and BR Districts						
Freestanding Signs	3 ft. setback for monument sign at the corner of Main St. and Kirk Rd., as shown on the PUD Preliminary Plan.					
Wall Signs	Four wall signs on the convenience store building, as shown on the PUD Preliminary Plan.					
Section 17.28.080 Prohibited Signs						
Off-Premise Signs	Three off-premise signs to be placed in the Main Street Commons PUD: one monument sign at the Main St. entrance of Main Street Commons; one monument sign at the Kirk Rd. entrance of Main Street Commons; one directional sign within Main Street Commons; all as shown on the PUD Preliminary Plan					