THE PRIDE OF KANE COUNTY 33W573 EAST MAIN STREET SAINT CHARLES, ILLINOIS 60174

DRAWING INDEX				
SHEET	DESCRIPTION	DATE		
T-1.0	TITLE SHEET	06-08-20		
C-1.0	SITE DEMOLITION PLAN	06-08-20		
C-2.0	SITE GEOMETRIC PLAN	06-08-20		
C-3.0	SITE DEVELOPMENT PLAN	06-08-20		
C-3.1 - C-3.3	SITE DEVELOPMENT DETAILS	06-08-20		
C-4.0 - C-4.1	SITE GRADING PLAN	06-08-20		
C-5.0	SITE UTILITY PLAN	06-08-20		
C-5.1 - C-5.3	SITE UTILITY DETAILS	06-08-20		
C-6.0	STORMWATER POLLUTION PREVENTION PLAN	06-08-20		
C-6.1	STORMWATER POLLUTION PREVENTION DETAILS	06-08-20		
C-7.0 - C-7.1	PROJECT SPECIFICATIONS	06-08-20		
C-8.0	FIRE APPARATUS CIRCULATION PLAN	06-08-20		

SURVEY DRAWING INDEX				
SHEET	DESCRIPTION	DATE		
SUR-1	TOPOGRAPHIC SURVEY (PREPARED BY THE W-T GROUP)	03-12-19		

- SET CROSS ON CONCRETE SIDEMALK LOCATED APPROXIMATELY 25.3' ESE OF KIRK ROAD AND 22.8' SSM OF ENTRANCE, AS SHOWN ON SHEET SUR-2. ELEVATION=T19,03' (NAVD88)

SITE BENCHMARK #3 - SET CROSS IN WALK LOCATED 35" EAST OF POND AND 200 FEET SOUTH OF ROUTE 64 ON WEST SIDE OF DRIVE, AS SHOWN ON SHEET SUR-3. ELEVATION=189.12" (NAV/D88)


SITE LOCATION MAP SCALE I"=1000" MAP DATA 2019 GOOGLE

SECTION 25 TOWNSHIP 40N RANGE 8E


CIVIL ENGINEERING STATEMENT AND SEAL

TODD ABRAMS - ILLINOIS P.E. # 062-061600 DATE OF EXPIRATION - NOVEMBER 30, 2021 NOTE: SIGNED AND SEALED FOR SHEETS T-I.O THROUGH C-7.I



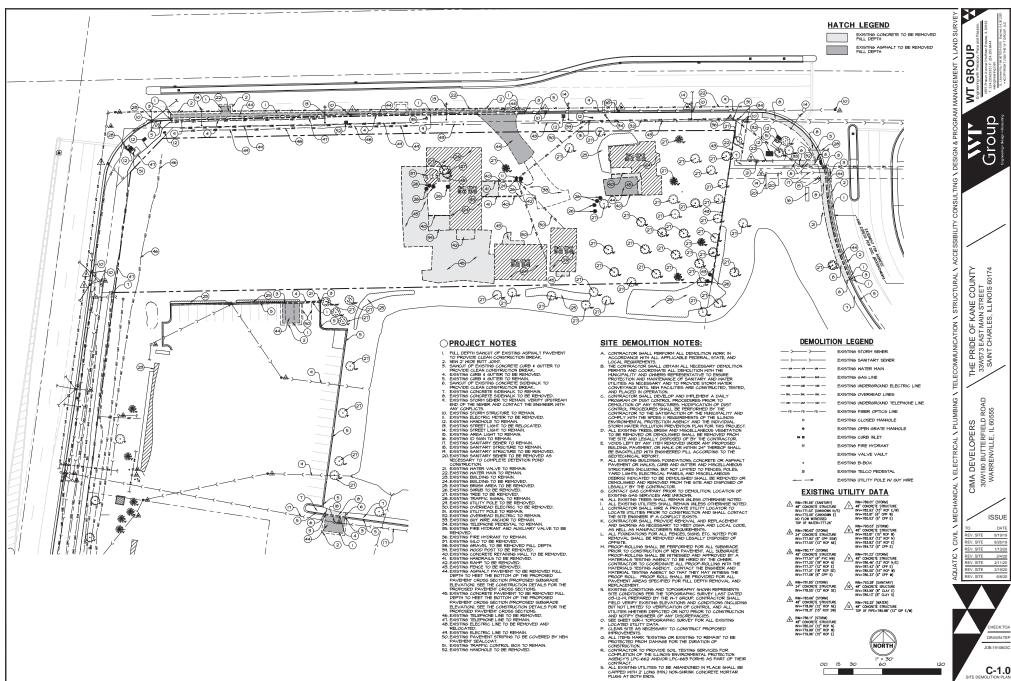

C-1.0

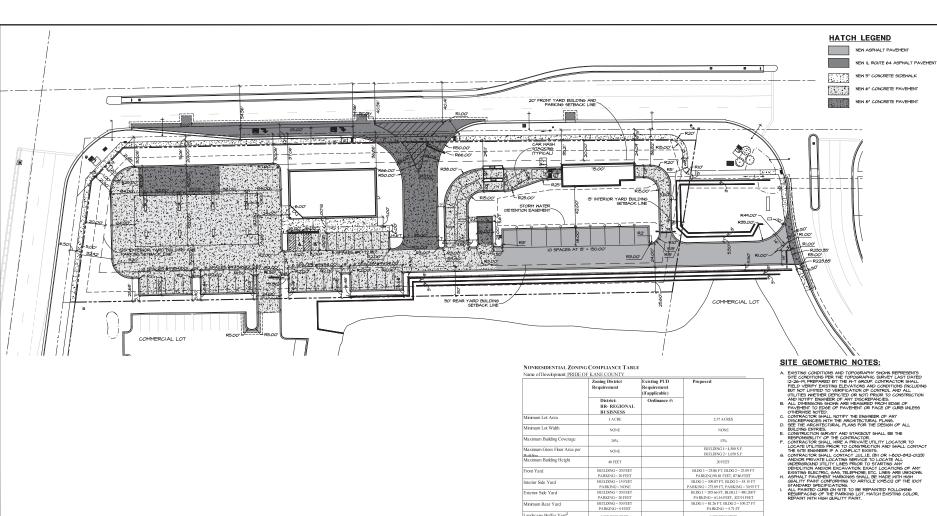

Exterior Side Yard Minimum Rear Yard Landscape Buffer Yard

% Overall Landscaped Area

Building Foundation Landscaping

% Interior Parking Lot Landscaping

Interior Parking Lot Shade Trees

of Parking space

50% HORIZONTAL

DIMENSIONS OF BUILDING WALL

NOT AVAILABLE

CARWASH = 2 PER BAY + 10 STACKING SPACES PER BAY RETAIL BUILDING = 4 PER L000 SF = 17 SPACES

37% WITH ON SITE STORM


BUILDING 1 = 50% BUILDING 2 = 100%

CARWASH = 10 SPACES + 10 STACKING RETAIL BUILDING = 34

CALL JULIE SIMPLY 811 OR TOLL FREE (800)842-0123 OPERATES 24 HOURS A DAY 365 DAYS A YEAR



GALL I(800)842-0123 48 HOURS BEFORE YOU DIG CONTRACTOR MUST LOCATE PRIVATE UTILITIES IN AREA OF CONSTRUCTION PRIOR TO PROCEEDING WITH WORK

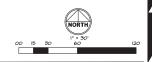


CIMA DEVELOPERS 30W180 BUTTERFIELD ROAD WARRENVILLE, IL 60555 ISSUE REV. SITE 8/19/19 REV. SITE 8/26/19 EV. SITE 2/4/20
EV. SITE 2/11/20
REV. SITE 2/19/20
REV. SITE 6/8/20

THE PRIDE OF KANE COUNTY 33W573 EAST MAIN STREET SAINT CHARLES, ILLINOIS 60174

GROUP

C-2.0

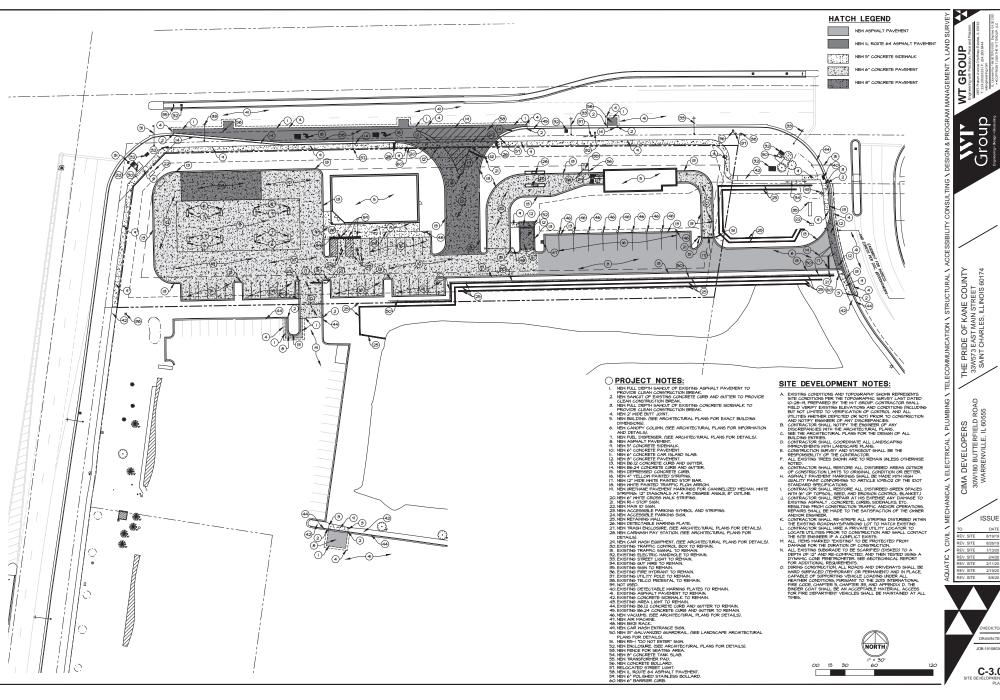





1/13/20

2/4/20




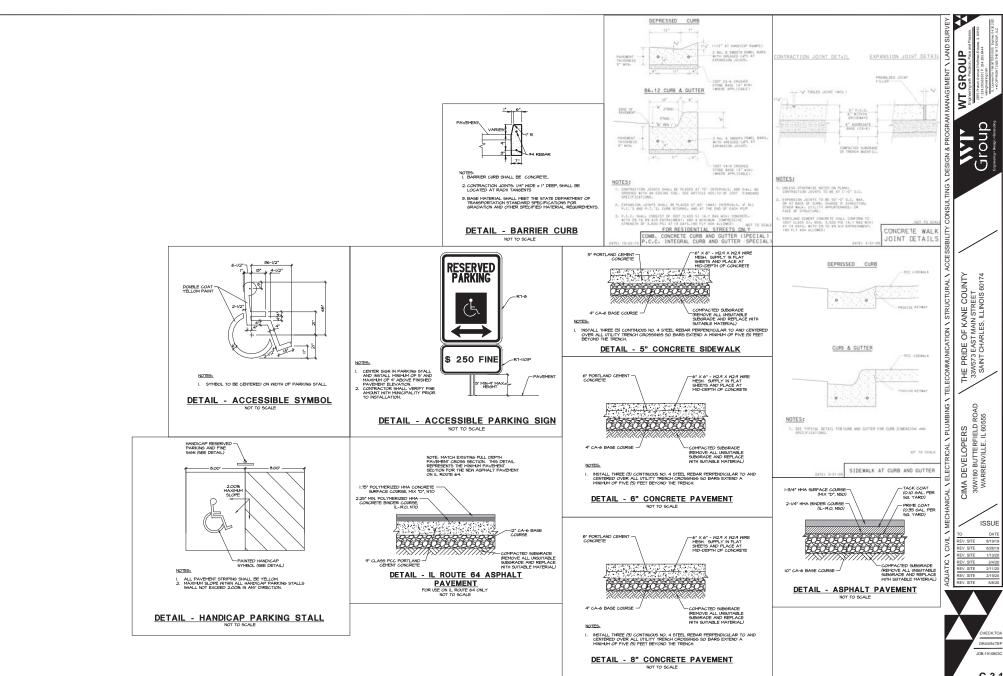


C-3.1

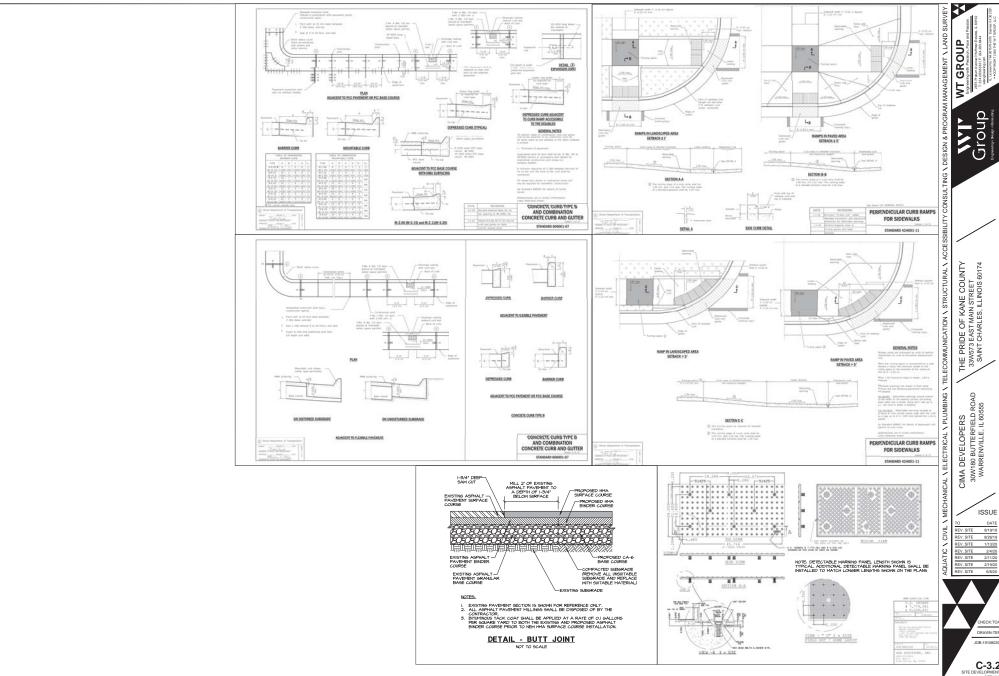

C-3.2

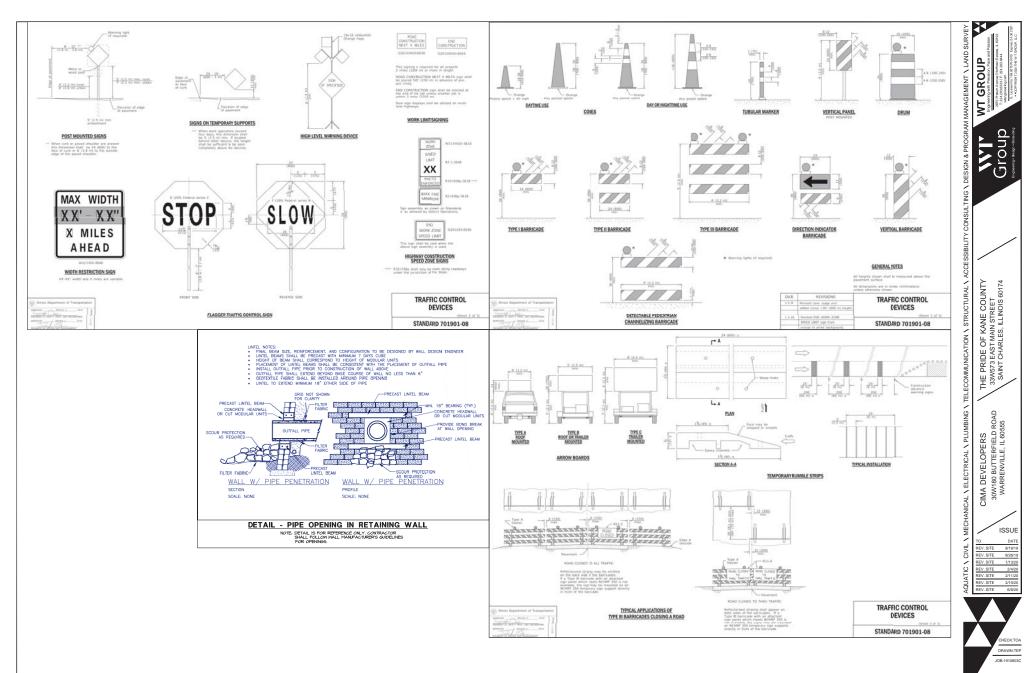

C-3.3

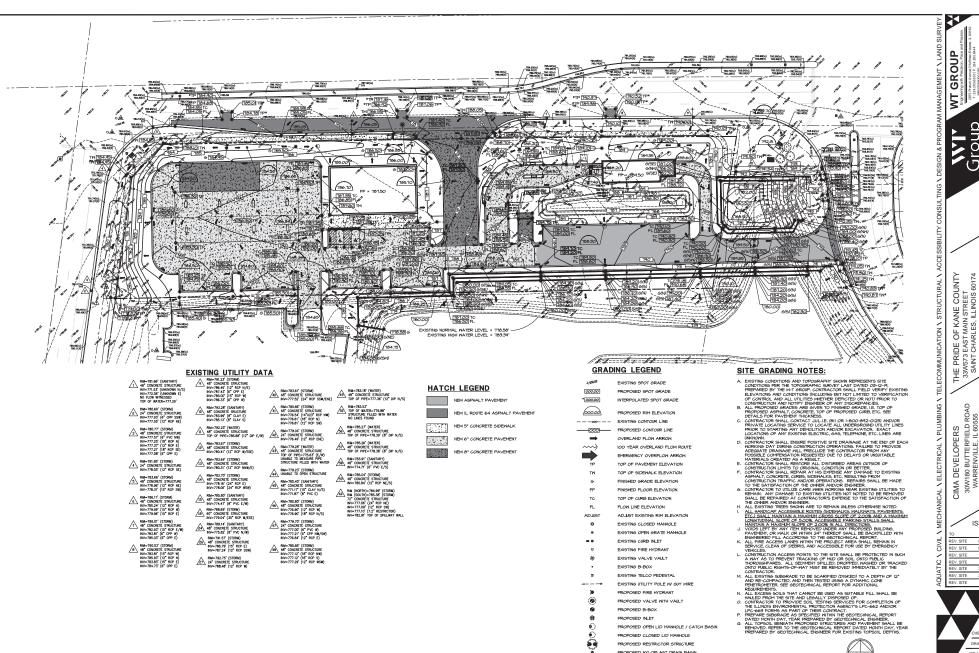

PROPOSED NYLOPLAST DRAIN BASIN

PROPOSED ELARED END SECTION PROPOSED GREASE TRAP

FIELD ROAI CIMA DEVELOPERS 30W180 BUTTERFIELD F WARRENVILLE, IL 605

ISSUE


1/13/2 2/4/20

REV. SITE

NORTH

JOB:1910803C

C-4.0

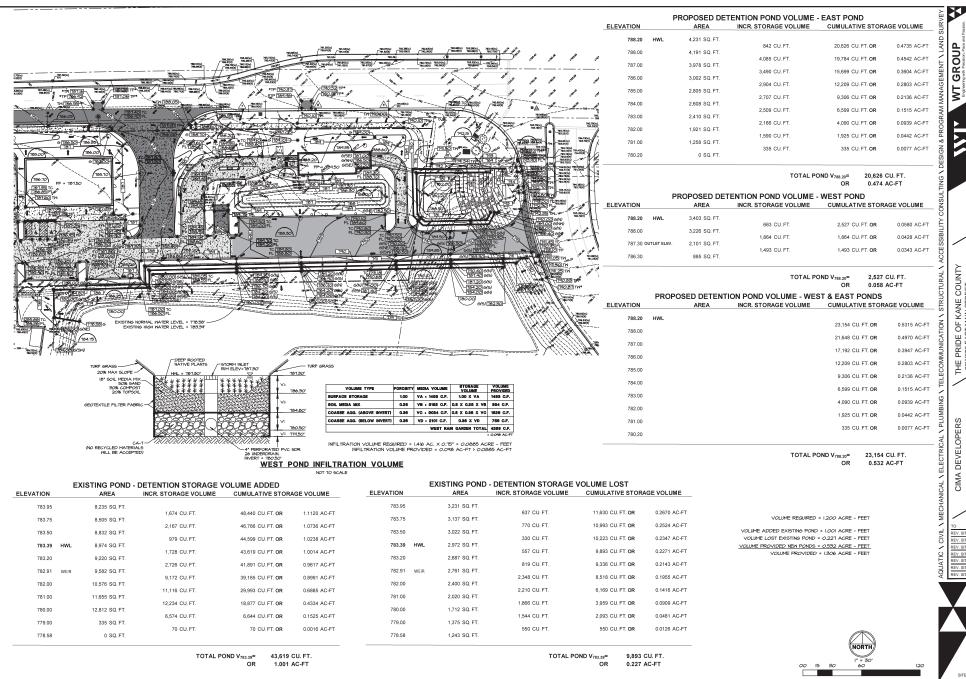


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FIELD RO IMA DEVELOPERS 30W180 BUTTERFIELD F WARRENVILLE, IL 605

ISSU REV. SITE 8/19/19 REV. SITE 8/26/19

REV. SITE 2/4/2

C-4.1

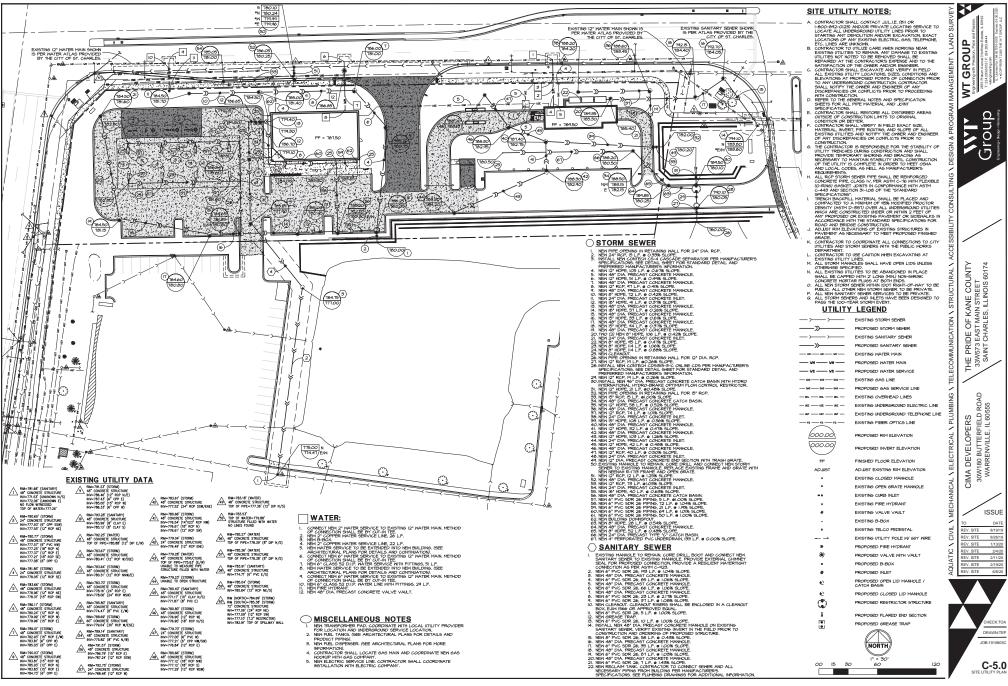


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ISSUE REV. SITE 8/19/19 1/13/20 2/4/20

REV. SITE 2/19/2 6/9/2

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CIMA DEVELOPE RS 300W 80 BUTTERFIELD ROAD PARE SERVINE SERVINE


THE PRIDE OF KANE COUNTY 33W573 EAST MAIN STREET SAINT CHARLES, ILLINOIS 60174

GROUP
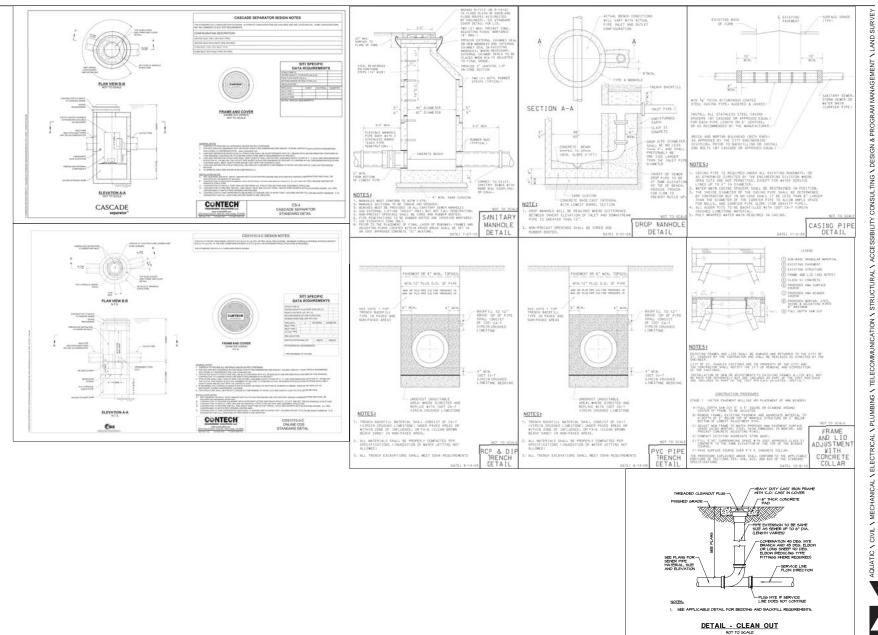
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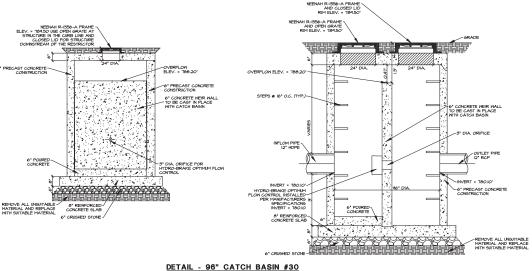
C-5.1




C-5.2

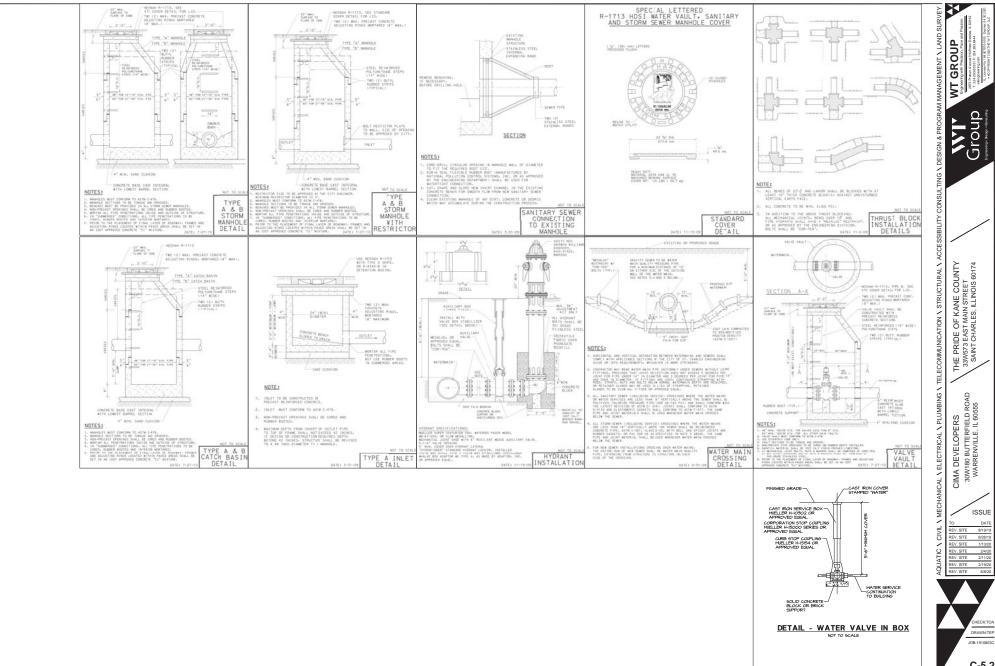
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C-5.3



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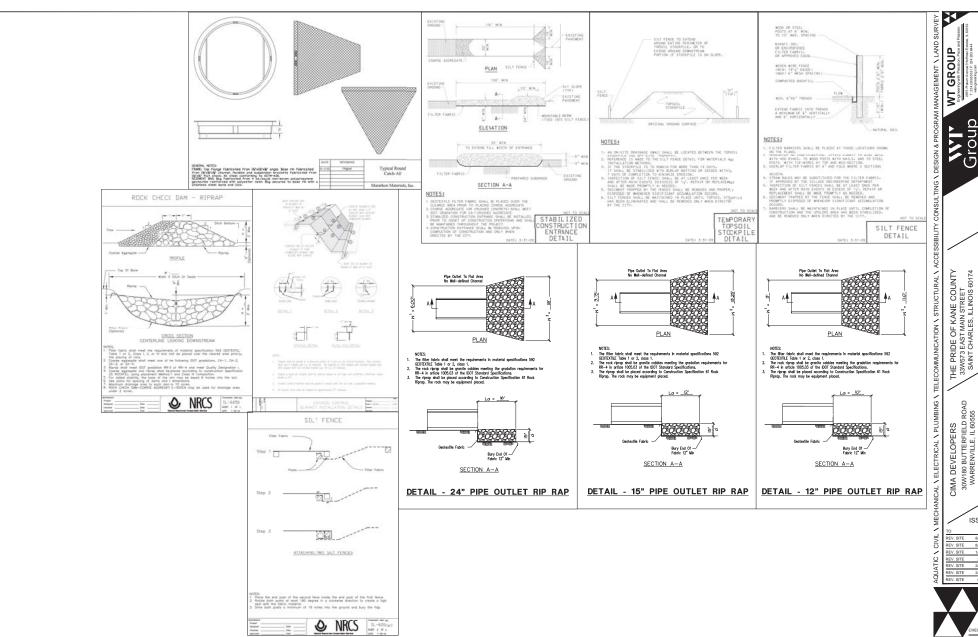


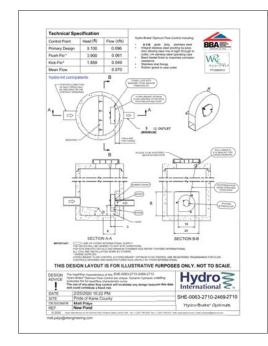

ISSUE 1/13/20 2/4/20

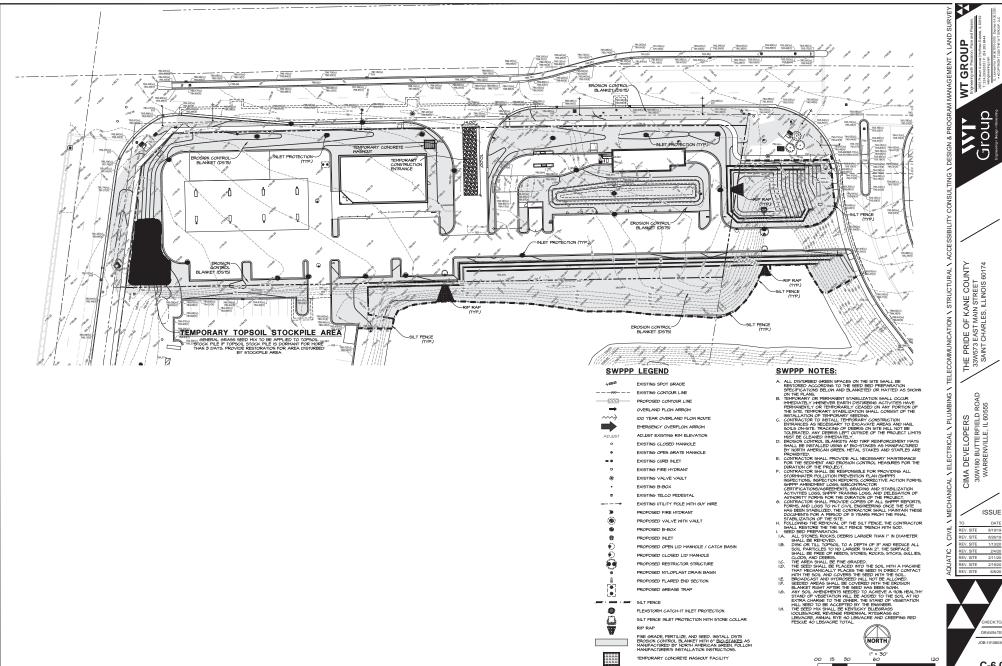REV. SITE 2/11/20 REV. SITE 2/19/20 6/9/2

C-6.0



ISSUE REV. SITE 8/19/19 REV. SITE 8/26/19 REV. SITE 2/4/20 REV. SITE 2/11/20 REV. SITE 2/19/20 REV. SITE 6/8/20

> JOB:1910803C C-6.1

- I.I. ILLINOIS DEPARTMENT OF TRANSPORTATION "STANDARD SPECIFICATIONS FOR ROAD AND BRIDGE CONSTRUCTION." LATEST EDITION.
- I.3. "ILLINOIS URBAN MANUAL," LATEST EDITION
- I.4. BUILDING CODES AND ORDINANCES OF THE LOCAL GOVERNING AUTHORITIES.
- I.5. UNITED STATES DEPARTMENT OF LABOR OCCUPATIONAL SAFETY AND HEALTH ADMINISTRATION (OSHA) REGULATIONS, 24 CFR PART 1426, "SAFETY AND HEALTH REGULATIONS FOR CONSTRUCTION."
- I.6. ILLINOIS DRAINAGE LAW.
- 17 II LINOIS ENVIRONMENTAL BARRIERS ACT
- LB. ILLINOIS ACCESSIBILITY CODE.

- 2. ALL REQUIRED FERMITS FROM THE APPROPRIATE GOVERNING AGENCY(S) SHALL BE OBTANED FOR CONSTRUCTION ALONG OR ACKNOSE ENSINES STREETS OR REPORT OF THE CONSTRUCTION ALONG OR ACKNOSE ENSINES STREETS OR REACHES, SECTION, AND OTHER REQUIRED PROVIDETION OF THE ACKNOSING OR ACKNOSING O
- CONTRACTOR SHALL NOTIFY THE LOCAL BISINEERING OF PUBLIC MORKS
 DEPARTMENT AND/OR DITER COVERNING ANTWENTING 46 MODES FROM TO
 DEPARTMENT AND/OR DITER COVERNING ANTWENTING 46 MODES FROM TO
 DEPARTMENT AND THE CONTRACT SHALL BE SHALL BE
- CONTRACTOR SHALL NOTIFY ALL UTILITY COMPANIES (6AS, ELECTRIC, TELEPHORE, CARLE, ETC.) AND THE LOCAL MANDALITY TO DETERMINE THE CONSTRUCTION OF THE PROPERTY OF THE CONSTRUCTION OF MODER TO ANOTO PRETIMAL CONFLICTOR, CONTRACTOR SHALL CALL THE JOINT UTILITY LOCATION PROPRIATION FOR EXCANATIONS (JULIE) AT HIGO-OS-OCIZION OF PURINES OF THE SUBTRICES (JULIE) AT HIGO-OS-OCIZION OF PURINES OF THE SUBTRICES (JULIE) AT HIGO-OS-OCIZION OF PURINES OF THE SUBTRICES (JULIE) AT HIGO-OS-OCIZION OF PURINES OF THE PURINES OF THE
- ALL DESEMBITS FOR DISTRIBUTIONS, BOTH FIRST CHARGE AND THE HEAD THE PROPERTY AND THE BENERIES ACCORDING TO INFORMATION AVAILABLE FROM FIRST EXCHANGES AND VISIGILATED THE DESEMBLY ACCORDING TO INFORMATION AVAILABLE FROM FIRST EXCHANGES AND FOR THE FROM THE PROPERTY OF TH
- ALL UTILITY CONNECTIONS TO EXISTING LINES SHALL BE CONSTRUCTED IN ACCORDANCE WITH THE RULES AND REGULATIONS AND TO THE SATISFACTION OF THE APPLICABLE UTILITY OWNER(S).
- CONTRACTOR SHALL FIELD VERIFY ALL DIMENSIONS, COORDINATES AND ELEVATIONS PRIOR TO THE COMMENCEMENT OF CONSTRUCTION AND SHALL IMMEDIATELY NOTIFY THE ENGINEER OF ANY DISCREPANCIES SO THE CONFLICT MAY BE RESOLVED.
- IO. THE SAFE AND ORDERLY PASSAGE OF TRAFFIG AND PEDESTRIANS SHALL BE PROVIDED WERRE CONSTRUCTION OPERATIONS ABUT PUBLIC THROUGH-FARES AND ADJACENT PROPERTY.
- ALL AREAS DISTURBED BY THE SENERAL CONTRACTOR OR SUB-CONTRACTORS SHALL BE RETURNED TO THE ORIGINAL CONDITIONS OR BETTER, EXCEPT WHERE PROPOSED CONSTRUCTION IS INDICATED ON THE PLANS.
- 12. NO BURNING OR INCINERATION OF RUBBISH WILL BE PERMITTED ON SITE.
- IS, PRICE TO INTILA, ACCEPTANCE BY THE CHARMED AND/OR SCOTEMBRE.
 ADDITION TO ALL INCRES SHALL BE INSECTION AND APPROVED BY THE CHARMED AND HE OF THE CHARMED AND HARCIPALITY BEINERS OR HIS REPRESENTATIVES. THE CONTRACTOR SHALL GUARANTIES BY DEVICE FOR A PRISED OF IN GROWING BROWNING TO THE CHARMED FOR THE PRICE OF THE PRISED AND THE TIME AND THE PRISED AND THE PRISED AND THE TIME AND THE PRISED AND TH
- I4. CONTRACTOR SHALL BE RESPONSIBLE FOR PROVIDING SAFE AND ADEQUATE WORKING CONDITIONS THROUGHOUT THE DURATION OF CONSTRUCTION OF THE PROPOSED IMPROVEMENTS.
- CONTRACTOR SHALL KEEP THE PUBLIC STREET PAVEMENTS CLEAN OF DIRT AND DEBRIS AND, WHEN NECESSARY, CLEAN PAVEMENTS AT THE END OF EACH KORKINS DAY. ALL CONSTRUCTION STAKING, SCHEDULING AND PAYMENT IS THE RESPONSIBILITY OF THE CONTRACTOR.
- THREE (3) ORIGINAL COPIES OF ALL SHOP DRAWINGS SHALL BE SUBMITTED TO THE ENGINEER FOR (BUT NOT LIMITED TO) THE FOLLOWING ITEMS.

- 17.3. GRANULAR MATERIAL GRADATION
- 17.4. PRECAST CONCRETE STRUCTURES (MANHOLES, INLETS, CATCH BASINS, VAULTS, ETC.)
- 17.5. WATER MAIN MATERIALS (VALVES, FIRE HYDRANTS, ETC.)
- I.B. AFTER COMPLETION OF THE PROPOSED IMPROVEMENTS AND WHEN REQUIRED BY THE GOVERNING AUTHORITY(S), CONTRACTOR SHALL PROVIDE THE OWNER AND DESINEER NATH AS-BULL TAKOOK RECORD PROVINGING, SHOOD AND SEALED BY A PROPESSIONALLY LICENSED PISINEER OR SURVEYOR AND SHALL INCLIDE AT A HIREMAN (WEREEL APPLICABLE TO THE SCOPE OF PROPRY THE POLLOWING TIEMS.
- 19.1 TOPOGRAPHY AND SPOT GRADE ELEVATIONS OF ALL PROPOSED PERMANENT SITE FEATURES INCLUDING ANY STORM WATER FACILITIES OR MODIFICATIONS TO EXISTING STORM WATER FACILITIES.
- 14.2 HORIZONTAL AND VERTICAL LOCATION AND ALIGNMENT OF ALL PROPOSED ROADWAYS, PARKING LOTS, UTILITIES, BUILDINGS OR OTHER PERMANENT SITE FEATURES.
- 14.3 RIM AND INVERT AND/OR TOP OF PIPE ELEVATIONS FOR ALL PROPOSED UTILITIES.
- 19.4 AS-BULT AND/OR RECORD DRAWING INFORMATION SHALL BE SHOWN ON THE PREVAMED ENGINEERING PLANS ISSUED FOR CONSTRUCTION, ANY AND ALL DEVALUED FROM THESE PAPROXIDE PLANS SHALL BE SHOWN BY MEANS OF STRIKING THEOLOGY THE PROPOSED INFORMATION AND CLEARLY INDICATING THE AS-BULL LOCATION AND ELEVATIONS ON THE APPLICABLE PLANS HEETING.

SITE GRADING AND PAVING

- ALL SITE KOST, GRADINE, AND PAVING OPPOSITORS, WHICH THE LINTE OF THIS PROJECT SHALL BE PERFORDED IN ACCORDANCE WITH THE LINTE OF DEPARTMENT OF TRANSPORTATION STANDARD SECURIFICATIONS FOR ROAD AND BRIDGE CONSTRUCTION. LATES EDITION IN STANDARD SECURIFICATIONS FOR ROAD HEAD BROAD SCHOOL STRUCTURE SHOULD SHALL SH
- EARTH EXCLATION BMLL INCLIEF CLEARING STRIPPING AND STOCKPLING TOPSOL, REPOVING INSULTANCE MATERIALS, CONTROL TO THE SHAKESHIN, KILLSTRICTERAL FILLS, FINAL SHAPING AND TRANSING. TO THE SHAKESHIN KILLSTRICTERAL FILLS FINAL SHAPING AND TRANSING TO THE SHAPE OF A CASCONDARY FINIT THE APPLICATE PROVINCES OF SECURITY AND AND A CASCONDARY OF THE PROJECT O
- EXCAVATED TOPSOIL SHALL BE STOCKPILED ON THE SITE IN AREAS DESIGNATED BY THE PROJECT ENGINEER WITH, SUCH TIME THAT THIS TOPSOIL CAN BE USED FOR INNAL, SEADNIS, LINESS OTHERWISE NOTEON TO THE PLANS A MINIMAN OF 6" TOPSOIL RE-SPREAD AND SEEDING FOR ALL DISTURBED AREAS IS REGULIED.
- THE SOLS INVESTIGATION REPORT FOR THE SITE AND ALL ADDRING THERETO AND SEPORTING DOCUMENTS FOR THIS PROJECT, THE MEDICANE SEPORTING DOCUMENTS FOR THIS PROJECT, THE MECAPROPARTED THIS THE PROJECTION INTO THE PROJECTION FOR THE PRESENCE AND SHALL BE FIGURATED BY ALL CONTRACTORS. THE GRADNIG OPERATIONS ARE TO BE LOCELY SEPORTIONS OF THE PROJECTION FOR THE PROJECTION OF THE
- ALL TESTINS, INSPECTION AND SUPERVISION OF SOIL QUALITY, INSUITABLE SOIL REMOVAL AND ITS REPLACEMENT AND OTHER SOILS RELATED OPERATIONS SHALL BE ENTRELLY THE RESPONSIBILITY OF THE CONTRACTOR.
- . THE CONTRACTOR SHALL USE CARE IN GRADING NEAR TREES, SHRUBS, AND BUSHES WHICH ARE NOT NOTED TO BE REMOVED SO AS NOT TO CAUSE INJURY TO ROOTS OR TRUNKS.
- THE CONTRACTOR SHALL USE CARE IN GRADING OR EXCAVATING NEAR ANY AND ALL EXISTING ITEMS WHICH ARE NOT INDICATED TO BE REMOVED. ANY DAMAGE DONE TO THESE EXISTING ITEMS BY THE CONTRACTOR'S OPERATIONS SHALL BE REPAIRED AT HIS OWN EXPENSE.
- REMOVED DRIVEWAY PAVEMENT, SIDEWALK, CURBS, TREES AND STUMPS SHALL BE DISPOSED OF LEGALLY OFF-SITE AT LOCATIONS DETERMINED BY THE CONTRACTOR.
- IO. PROPOSED ELEVATIONS INDICATE FINSHED GRADE CONDITIONS, FOR ROUSH GRADING ELEVATIONS ALLOW FOR THE THICKNESS OF THE PROPOSED PAVING (ROADS, WALKS, DRIVE, ETC.) SECTION OR TOPSOIL AS INDICATED ON THE PLANS.
- CONTRACTOR SHALL PROVIDE SMOOTH VERTICAL CURVES THROUGH THE HIGH AND LOW POINTS INDICATED BY SPOT ELEVATIONS ON THE PLANS. CONTRACTOR SHALL PROVIDE INFORM SLOPES BETWEEN NEW AND EXISTING GRADES AND AVOID ANY RIDGES AND/OR DEPRESSIONS.
- ALL PROPOSED GRADING, PAVEMENT, APRONS, CURBS, WALKS, ETC. SHALL MATCH EXISTING GRADES FLUSH.
- ALL EXISTING AND PROPOSED TOP OF FRAME ELEVATIONS FOR STORM, SANITARY, MATTER AND OTHER UTILITY STRUCTURES SHALL BE ADJUSTED TO MEET FINISHED GRADE MITHIN THE PROJECT LIMITS.
- 14. ALL CONCRETE POURED SHALL BE:
- I4.I. MINIMM COMPRESSIVE STRENSTH: I4.I.I. 8500 P.S.I. AT I4 DAYS (PER I.D.O.T.) I4.I.2. 4500 P.S.I. AT 26 DAYS (PER A.C.I.)
- 14.2. MAX WATER-GEMENTITIOUS MATERIALS RATIO: 0.44 (AIR-ENTRAINED)
- I4.3. AIR CONTENT: 6%, +/- I.5% AT POINT OF DELIVERY FOR EXPOSED CONCRETE
- 15. WHEN PIBER MESH REINFORCEMENT IS SPECIFIED, IT SHALL CONSIST OF PIBRINATED POLYRROW/LIBE FIBERS BIGHIERRED AND DESIGNED FOR USE IN CONCRETE RAYMEDIT, CORPLYING WITH ASTAL OIL (III, TYPE III, TO \$\frac{3}\$ INCHES LONG, FIBERS SHALL BE UNFORMLY DISPESSED IN THE CONCRETE MIXTURE AT THE MANAPACHISER'S RECORDERINED RATE OIL TO IT OF IT LESS HAND IS LIBE? (ALL)
- 16. THE GRADING AND CONSTRUCTION OF THE PROPOSED PAVEMENT IMPROVEMENTS SHALL NOT CAUSE PORDING OF STORM MATER. ALL AREAS ADJACENT TO THESE IMPROVEMENTS SHALL BE GRADED TO ALLOW POSITIVE DRAINAGE AND MATCH EXISTING GRADES FLUSH.
- IT. CONTRACTOR SHALL ENSURE POSITIVE SITE DRAINAGE AT THE END OF EACH MORKING DAY DURING CONSTRUCTION OPERATIONS, FAILURE TO PROVIDE ADEIGNATE DRAINAGE MILL PRECLIDE THE CONTRACTOR FROM MAY POSSIBLE COMPENSATION REQUESTED DUE TO DELAYS OR UNSUITABLE MATERIALS CREATED AS A RESULT.
- Iô. DRIVENAYS SHALL BE CONSTRUCTED SO AS NOT TO IMPEDE THE SURFACE DRAINAGE SYSTEM.
- IR. TRAFFIC CONTROL DEVICES SHALL BE IN CONFORMANCE WITH THE ILLINOIS DEPARTMENT OF TRANSPORTATION STANDARDS AND SHALL BE INSTALLED AND PROVIDED HEBEVER CONSTRUCTION FOR UTILITIES ARE WITHIN STREET AREAS, APPLICABLE ORDINANCES OF THE MINICIPALITY, COUNTY OR STATE SHALL ALSO SOVERN THE TRAFFIC CONTROL REGUIREMENTS.

WATER MAINS AND SEWERS HORIZONTAL SEPARATION

- MATER MAINS SHALL BE LOCATED AT LEAST TEN (IO) FEET HORIZONTALLY FROM ANY EXISTING OR PROPOSED DRAIN, STORM SEWER, SANITARY SEWER, COMBINED SEWER, SEWER SERVICE CONNECTION.
- 2. WATER MAINS MAY BE LOCATED CLOSER THAN TEN (IO) FEET TO A SEMER LINE WHEN:
- 2.I. LOCAL CONDITIONS PREVENT A LATERAL SEPARATION OF TEN (IO) FEET;
- THE WATER MAIN INVERT IS AT LEAST EIGHTEEN (IB) INCHES ABOVE THE CROWN OF THE SEMER; AND
- THE WATER MAIN IS EITHER IN A SEPARATE TRENCH OR IN THE SAME TRENCH ON AN UNDISTURBED EARTH SHELF LOCATED TO ONE SIDE OF THE SEVER.
- 5. WEN IT IS INPOSSIBLE TO MEET IJ OR 2) ABOVE, BOTH THE MATER MAIN AND DRAIN OR SERVER SHALL BE CONSTRUCTED OF SUP-COLOR MECHANICAL, JOINT PRE-SPRESSED CONCRETE INFO, OR PVC. PITE GUIVALENT TO NATURE MAIN STANDARDS OF CONSTRUCTION, THE DRAIN OR SERVER SHALL BE PRESSURE TESTED FOR THE MANIMAN BOTSETIED SECRIFICE PLAD PRISON EAST SHALL BE PRESSURE.

SANITARY SEWERS

- ALL ANTIANY SINCE CONSTRUCTION SHALL BE IN ACCROUNCE INTH THE STANDARD SPECIFICATIONS FOR ANTIRE AND SINCE CONSTRUCTION IN LILINGS; LATEST EDITION, AND ALL SUBSEQUENT REVISIONS THERETO (TYANDARD SPECIFICATIONS), AN SPECIAL PROVIDENCE, THE NOTES ON THE COYARDING SHALL SHAL
- ALL SANITARY SEVER PIPE AND STRUCTURES SHALL BE FURNISHED AND INSTALLED IN ACCORDANCE WITH DIVISION III OF THE "STANDARD SPECIFICATIONS."
- ALL SANITARY SEVER PIPE SHALL BE POLYVINYL CHLORIDE (PVC) SDR 26 PIPE PER ASIM D-3034 WITH WATERTIGHT JOINTS CONFORMING TO ASTM D-3212, UNLESS OTHERWISE NOTES.
- 3.1. IMPERE SANITARY SEMER PIPE IS NOTED AS PVC C-400, THE PIPE SHALL BE IN ACCORDANCE WITH AMERICAN MATER MORKS ASSOCIATION (AMMA) C-400 MITH MATERITIOHT, PRESSURE RATED JOINTS CONFORMING TO ASTM D-3199.
- SANITARY SENER CONSTRUCTION SHALL COMMENCE AT THE EXISTING MANHOLE(S) AND/OR CONNECTION POINT(S) INDICATED ON THE PLANS.
- 4.1. A MATERTIGHT PLIJO SHALL BE INSTALLED AND LEFT IN PLACE AT THE POINT OF COMMENCEMENT WITTL THE REMAINDER OF THE PROPOSED SHERS HAVE BEEN CONSTRUCTED, PROPERLY TESTED AND DEEMED READY FOR FINAL ACCEPTANCE.
- ALL SANTARY SENER TRENCH EXCAVATIONS AND PIPE FOUNDATION, BEDDING AND HAINCHING SHALL BE CONSTRUCTED IN ACCORDANCE WITH THE APPLICABLE SECTIONS OF DIVISION II OF THE "STANDARD SPECIFICATIONS."
- 5.1. ALL SANITARY SENERS MIST BE PLACED ON PROPRIETY COMPACTED STOKE DECOMING HISTORIA. SHALL BE A NINIMM OF FOUR MATERIAL SHALL BE CARBON OF THE DECOMING HISTORY SHALL BE CARBON OF THE PIET PER ASTH D-2321. PIET BEDDING MATERIAL SHALL BE CRUSHED GRAVEL OR STOKE MEETING DOT GRADATION CA-II OR CA-II OR STOKE MEETING DOT GRADATION CA-II OR CA-II OR
- 5.2. TRENCH BACKFILL MATERIAL SHALL BE PLACED AND COMPACTED TO A MININAM OF 498 MODIFIED PROCITOR DENSITY, PER ASTM D-1957, OVER ALL SANITARY SENERS WHICH ARE CONSTRUCTED UNDER, OR MITHIN TWO (2) FEET OF, ANY PROPOSED OR EXISTING PAYEMENT, PARKING LOTS OR SIDEMALKS.
- DEFORMANCE IS REQUIRED TO RECORD HE LOCATION OF ALL SIMPERS

 THE CONTRACTOR IS REQUIRED TO RECORD HE LOCATION OF ALL SIMPERS
 REPRESENTATIVE. THE CONTRACTOR SHALL LOCATE ALL SIMPERS BY
 HEAGUSEDHER'S TO LOT CORRECTOR OF OTHER REPORTMENT SITE FRATILE AND
 DOING OWNERS REPRESENTATIVE LIVEN FOR LECT COMPLETION. THIS
 BY CONTRACTOR SHALL ASSO INCLUDE THE DEPTH OF PLOYS SIVEN BY
 HER PROPRIENT SHALL ASSO INCLUDE THE DEPTH OF PLOYS SIVEN BY
 RESPONSIBLE FOR ALL COSTS WHICH ARE INCLUDED AS A RESULT OF THE
 RESPONSIBLE FOR ALL COSTS WHICH ARE INCLUDED.
- ALL SANTARY SEVER MANHOLES SHALL BE PRECAST CONCRETE AND SHALL BE FURNISHED AND INSTALLED IN ACCORDANCE WITH THE APPLICABLE PORTIONS OF DIVISION II, SECTION 32 OF THE "STANDARD SPECIFICATIONS" AND THE DETAILS IN THE PILANS.
- AND THE DETAILS IN THE FLAME.

 11. A FLORING ETTEL JOINT SHALL BE FLRINSHED AT POINTS OF ENTRY INTO AND ENTRING PROOF MANAGLE STRUCTURES AND SHALL BE OF A DESIGN APPROVED BY THE BENERIES PROOK TO INSTALLATION, THE FLEXIBLE PROPERTY OF THE PROOK TO THE PROOF AND THE PROOF THE
- ALL REGUIRED MANHOLE RIM ADJISTMENTS SHALL BE MADE WITH PRECAST CONCRETE ADJISTING RINGS NOT TO EXCEED A MAXIMM OF EIGHT (8) INCHES IN CYRRALL RIGHIST, A MAXIMM OF TWO (2) ADJISTING RINGS ARE ALLOWED. BUTHLROPE JOINT SEALANT SHALL BE USED ON ALL JOINTS DETIVEDS THE PRECAST ELEMENTS.
- AFTER FINAL ADJISTMENTS HAVE BEEN MADE, ALL JOINTS IN PRECAST STRUCTURES SHALL BE MORTARED, THE MORTAR SHALL BE COMPOSED OF ONE (I) PART CEMENT TO THEE (B) PARTS SAND, BY VOLUME, BASED ON DRY MATERIALS, AND SHALL BE THOROUGHLY METTED BEFORE LAYING.
- IO. WHEN CONNECTING TO AN EXISTING SEMER MAIN BY MEANS OTHER THAN AN EXISTING MYE, TEE, OR MANIOLE, THE FOLLOWING METHOD SHALL BE USED:
- IO.I. CIRCULAR SANI-CUT OF SEMER MAIN BY PROPER TOOLS (SEMER-TAP) MACHINE OR SIMILARI AND PROPER INSTALLATION OF HUB-MYE SADDLE OR HUB-TEE SADDLE.
- II. ALL FLOOR DRAINS SHALL BE CONNECTED TO THE SANITARY SEMER, ALL FOOTING DRAINS AND DOWNSPOUTS SHALL DISCHARGE ONTO THE GROUND OR INTO THE STORM SEMER SYSTEM AS INDICATED ON THE DRAMINGS.
- 12. UPON COMPLETION OF THE SANITARY SEMEN CONSTRUCTION, INCLUDING THE SERVICE LINES, ALL SEMENS SHALL BE TESTED IN ACCORDANCE WITH SECTIONS 9-11,2 AND 9-11,30 OF THE "STANDARD SPECIFICATIONS" AND WITHESSED BY THE LOCAL GOVERNING AUTHORITY OR AUTHORIZED REPRESENTATIVE.

WATER MAINS

- - ALL NATES MAINS MIST BE FLACED ON PROPERLY COMPACTED STORE BEDONIE, PIRE BEDONIE MATERIAL SHALL BE A MINIMOM OF FOX (4) INCHES THICK WILDER THE BANGEL, OF THE PIRE IMPERIONS MATERIAL CALL DE CASE ORACIL. OF STORE METING INDICATOR OR MORADITOR CASE. THE CASE MAKE THE MATERIAL SHALL BE PLACED AND COMPACTED TO A MINIMOM OF 80% MOOFTED PROCTOR DESIGN, THE AND THE JOST, OVER ALL NATES MAINS MINIMOM ARE CONSTRUCTED MORES, OR WITHIN TOO (2) PIET OF, ANY PROPOSED OR ESSITIS PAYMENT, PARKING LOTS OR
- FETT OF ANY PROPOSED OR BUSTING PAMENTAL PARKING LUTE OR

 A THERTON THAN SHALL BE FAZED IN THE BUD OF THE WATER MAIN PIPE
 AT THERTON THE BUD OF THE WATER MAIN PIPE
 AT THE THAN THE PARKING THE PARKING THE PARKING THAN SHALL

 BE TESTED IN ACCORDINATE WITH THE FOLLOWING MINIMAL STANDARDS.

 JUSTIC OF THE PARKING THE PARKING THE STANDARD SHALL

 JUSTIC OF THE PARKING THE PARKING THE PARKING THAN THE SHALL

 BY THE LOCAL GOVERNING AITHORITY.

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 SHALL BY THE PARKING THE PARKING THE STANDARD SHALL

 AND WITHESEED BY THE LOCAL GOVERNING AUTHORITY.

WATER SERVICES AND CONNECTIONS

- L WATER SERVICE PIPE AND STRUCTURES SHALL BE FURNISHED AND STALLED IN ACCORDANCE WITH DIVISION IV OF THE "STANDARD ECIFICATIONS."
- ALL MATER SERVICE LINES 2" IN DIAMETER OR SMALLER SHALL BE TYPE K'.
 COPPER TUBING COMPORMING TO ASTM 8-56-56. NO COUPLINGS SHALL BE
 PERMITTED BETWEEN THE COMPORATION AND CURB STOPS OR BETWEEN THE
 CURB STOP AND THE BUILDING.
- SERVICE BOXES SHALL BE OF SUFFICIENT LENGTH TO PERMIT THE TOP TO BE INSTALLED FLUXH WITH THE FINISHED GRADE. EACH SERVICE BOX SHALL BE PROVIDED WITH A CAP WITH THE WORD "NATER" CAST IN THE TOP.
- ALL VALVES, VALVE BOXES OR VAILTS SHALL BE CONSTRUCTED IN ACCORDANCE WITH THE PROVISIONS OF DIVISION IV, SECTION 44 OF "THE STANDARD SPECIFICATIONS."
- VALVES SHALL BE AMERICAN FLOW CONTROL SERIES 2500 DUCTLE IRON RESILIENT SEAT EPOXY COATED NEDSE VALVES OR APPROVED EQUAL.
- ALL PRESSURE CONNECTIONS TO THE EXISTING WATER MAIN SHALL BE CONSTRUCTED IN ACCORDANCE WITH SECTION 46 OF THE "STANDARD SPECIFICATION" AND SHALL INCLUDE THE INSTALLATION OF A FULL STAINLESS STEEL TAPPING SADDLE.
- ALL VALVES SHALL BE INSTALLED IN VALVE VAILTS HAVING A MINIMM DIAMETER OF FIVE (5) FEET BELOW THE PRECAST CONCRETE COME SECTION. THE VAILTS SHALL BE CONSTRUCTED OF PRECAST CONCRETE SECTIONS AND SHALL CONFORM TO THE DETAILS SPECIFIED ON THE PLANS, ALL VALVE VAILTS SHALL BE LEAK PROCE
- IO, ALL REQUIRED RIM ADJUSTMENTS SHALL BE MADE WITH PRECAST CONCRETE ADJUSTING RINGS NOT TO EXCEED A MAXIMAM OF BIGHT (8) INCHES IN OVERALL RIBGHT, A MAXIMAM OF TWO (2) ADJUSTING RINGS ARE ALLOWED. BUTTLROPE JOINT SEALANT SHALL BE USED ON ALL JOINTS BETWEEN THE PRECAST BLIMPINTS.

WATER MAINS AND SEWERS VERTICAL SEPARATION REQUIREMENTS

- HATER HAIDS SHALL BE SEPARATED FROM A SERIER SO THAT ITS NUTRIL IS A MINISHA OF BEHTER (II) BLICKE BOOK THE CRAIN OF THE PRANK OF SERIES OF HAITER HABIC CARGOS STORY SEPARES, SANITARY SEPARES, OR HAITER HABIC CARGOS STORY SEPARES, SANITARY SEPARES, OR HAITER HAS BOOK AND THE HAITER HAS BOOK AND THE HAITER HAVE AND THE HATER HAVE LOCATED HITHIN THE (II) FANT SHALL SHALL

- 2.2. THE WATER MAIN PASSES UNDER A SEMER OR DRAIN

- ALL RCP STORM SEIVER PIPE I2* IN DIAMETER AND LARGER SHALL BE REINFORCED CONCRETE PIPE, CLASS IV, PER ASTM G-76 WITH FLEXIBLE (O-RING) GARGET JOINTS IN CONFORMANCE WITH ASTM C-445 AND SECTION SHILDOO OF THE "STANDARD SPECIFICATIONS." ALL IO* DIAMETER RCP STORM SEVER PIPE SHALL BE REINFORCED CONCRETE PIPE, CLASS V.
- ALL HOPE STORM SEVER PIPE SHALL BE RIGID HIGH DENSITY POLYETHYLENE PIPE WITH CORRUPATED EXTREME AS SHOOTH INTERCEM MEETING AND ANOTHER PIPE WITH CORRUPATION PIPE. AND ANOTHER PIPE WITH CORRUPATION DESCRIPTION OF MICHAEL PIPE. AND THE PIPE WITH CHAINS CANCENTE EXPELIENTATION of MICHAELON EXALL HIGHT CO. EXCEPT THAT OF PIVE SIZE XX WITH RIGH-ON JOINTS, ALL HOPE STORM SEVER PIPE SHALL ONLY BE FOR PRIVATE USE.
- ALL PVC STORM SEINER PIPE SHALL BE POLYVINYL CHLORIDE SDR 26 PIPE PER ASTM D-3034 MITH MATERTIGHT JOINTS CONFORMING TO ASTM D-3212, UNLESS OTHERWISE MOTERS.
- ALL STORM SENER TRENCH EXCAVATIONS AND PIPE FOUNDATION, BEDDING (HAUNCHING SHALL BE CONSTRUCTED IN ACCORDANCE NITH THE APPLICABLE SECTIONS OF DIVISION II OF THE "STANDARD SPECIFICATIONS."
- ALL STORM SENERS MUST BE PLACED ON PROPERLY COMPACTED STONE BEDDINS, PIER BEDDINS MATERIAL, SHALL BE A MINIMO MO FOUR (4) INCHES THICK MODER THE BARREL OF THE PIER AND FOR FVC PIER, MATERIAL, SHALL BE EXTENDED A MINIMO MO TO YOUR THE THE PIER AND FOR FVC PIER, MATERIAL, SHALL BE CARDINED MATERIAL, SHALL BE CARDINED MATERIAL, SHALL BE CARDINED GRAVEL OR STONE MEETING IDOT GRADATION CA-T, CA-II OR CA-II.
- 62. TRENCH BACKFILL MATERIAL SHALL BE PLACED AND COMPACTED TO A MINIMM OF 49% MODIFIED PROCTOR DENSITY, PER ASTM D-1957, OVER ALL STORM SEMERS WHICH ARE CONSTRUCTED UNDER, OR WITHIN TWO (2) FEET OF, ANY PROPOSIED OR ENSTING PRAVING IN PARKING LOTS OR SIDEMALKS.
- ALL REQUIRED STORM STRUCTURE RIM ADJISTMENTS SHALL BE MADE WITH PRECAST CONCRETE ADJISTING RINGS NOT TO EXCEED A MAXIMM OF EIGHT (8) NICHES IN OVERALL HEIGHT, ANAMIMM OF THO (2) ADJISTING RINGS ARE ALLOWED, BUTTLROPE JOINT SEALANT SHALL BE USED ON ALL JOINTS BETWEEN THE PRECAST ELEMENTS.
- PRECION ELEPRID.

 A. AL FIED THE ENCANTERED DIRING CONSTRUCTION OFBRATIONS SHALL BE CONNECTED TO THE PROPOSED STOMM SERVER SYSTEM OR EXTREMED TO CUTLET MICE A REPOSEDED DRAINAGE MAY, IT THIS CAMPED THE ACCOMPLISHED, THEN THE PROPOSED DRAINAGE MAY, IT THIS CAMPED THE ACCOMPLISHED, THEN THE ACCOMPLISHED SHALL BE ACCOMPLISHED SHALL BE ACCOMPLISHED SHALL BE REPOSED OF THE LOCATION OF THAT FIRED SHALL BE DEFINED OR PAIN PIPE BENCHMENTED SHALL BE REPORTED THE CONTROL OF THE TREATMENT OF THE OWNER MOST DESIDERED HAVE ACCOMPLISHED SHALL BE REPORTED TO DRAININGS. OF THE PROPERTY AND ACCOMPLISHED SHALL BE SHALL BE REPORTED TO THE PROPERTY AND ACCOMPLISHED SHALL BE SHALL BE REPORTED TO THE PROPERTY AND ACCOMPLISHED SHALL BE SHALL BE SHALL BE REPORTED TO THE PROPERTY AND ACCOMPLISHED SHALL BE SHA

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- ALL TEMPORARY CONNECTIONS FOR CONSTRUCTION PURPOSES TO NEWLY INSTALLED OR EXISTING WATER MAINS SHALL BE MADE AND METERED IN ACCORDANCE HITH LOCAL REQUIREMENTS.

- 2. BOTH THE WATER MAIN AND SEMER SHALL BE CONSTRUCTED OF SLIP-ON OR MECHANICAL JOINT CAST OR DUCTILE IRON PIPE, ASBESTOS-CEMENT PRESSURE PIPE, PRE-STRESSED CONCRETE PIPE, OR PVC PIPE EQUIVALENT TO MATER HAIN STANDARDS OF CONSTRUCTION PHEM.
- IT IS IMPOSSIBLE TO OBTAIN THE PROPER VERTICAL SEPARATION AS DESCRIBED IN I ABOVE; OR
- 3. A VERTICAL SEPARATION OF BIGHTEIN (IB) INCHES BETWEEN THE INVERT OF THE SPIER OR BANIA NOT THE CACONS OF THE MATTER MAIN SHALL BE MAINTAINED MERGE A MAINTE MAIN CAROSSES UNDER A SIDER, THE SELECT OR THE MATTER MAIN, AS SHOWN ON THE PLANS OR AS APPROVED BY THE BISINEER.
- CONSTRUCTION SHALL EXTEND ON EACH SIDE OF THE CROSSING UNTIL THE FERTENDICULAR DISTANCE FROM THE WATER MAIN TO THE SEVER OR DRAIN LINE IS AT LEAST TEN (IO) FEET.

STORM SEWERS

- ALL STORM SEMER CONSTRUCTION SHALL BE IN ACCORDANCE MITH THE
 "STADARD SHEUPELATIONS FOR HATTER AND SEMER CONSTRUCTION IN LLINDIS,"
 TRANSCRIPTION STADARDS SHEUPELATIONS FOR KNOW AND BRIDGE OF
 CONSTRUCTION, LATEST EDITION ("BOT STADARDS SHEUPELATIONS), ANY SHEGULA
 PROVISION, THE MOTES ON THE PLANS, AND IN ACCORDANCE HITH THE CODES AND
 ORDINANCES OF THE GOVERNION AUTORITIES. IN CASE OF CONFLICT, THE MORE
 STRINGIST COST SHALL TAKET PRECEDENCE.
- ALL STORM SENER PIPE AND STRUCTURES SHALL BE FURNISHED AND INSTALLED IN ACCORDANCE WITH DIVISION Y OF THE "STANDARD SPECIFICATIONS" AND DIVISIONS 500 AND 600 OF THE "IDOT STANDARD SPECIFICATIONS."

<u>ت</u>

THE PRIDE OF KANE COUNTY 33W573 EAST MAIN STREET SAINT CHARLES, ILLINOIS 60174

ROA 555 LOPERS TELD IL 605 CIMA DEVELOPEI 30W180 BUTTERFII WARRENVILLE, II

ISSUE REV. SITE 8/19/19

REV. SITE 2/4/20

REV. SITE 2/19/2 REV. SITE 6/8/2

1/13/2

IOR-1910803C C-7.0

STORMWATER POLLUTION PREVENTION NOTES

- PREVENTION NOTES

 PREVENTION NOTES

 OF THE APPROVED STORM MATER POLITION RENCHITOR FLANS
 SHALL BE HARTANED ON THE SITE AT ALL THE® ALCAS WITH THE PREVIT,
 MICIDENT OF INCLODES, AND COLON FOR A HOUSE REPORT ON THE PREVIT.

 ACCOUNT, AND THE PREVIOUS PREVIOUS PREVENTION OF THE PREVIOUS PREVIOUS
- DAYS AND JATHAN THENTY-FOOR (201 ALURIS OF THE BID OF ALL DAYS AND JATHAN THENTY-FOOR (201 ALURIS OF THE BID OF ALL DAYS AND JATHAN THENTY-FOOR (201 ALURIS OF THE BID OF ALL DAYS AND JATHAN THE SHOPPED JATHAN SHOPPED

SOIL EROSION AND SEDIMENT

- OBTAIN NPDES AND OTHER APPLICABLE SITE PERMITS AND REVIEW PROJECTS STORMANTER POLLUTION PREVENTION PLAN (SWPPP). CONTRACTOR SHALL BE RESPONSIBLE FOR MAINTAINING AND UPDATING THE SWPPP THROUGHOUT THE DURATION OF CONSTRUCTION AS NECESSARY UNTIL FINAL SITE STABILIZATION IS A CHIEVED.
- 2. INSTALL STABILIZED CONSTRUCTION ENTRANCE.
- 4. INSTALL PROTECTION DEVICES FOR EXISTING DRAINAGE INLET AND OUTLET
- 5. FERFORM SCIONANCES ROLLINGNI RES, BRITCH SITE INFECTIONS ON A RESEAL PASSE AND HITHIN RESEALITIONS OF THE BIS OF A RAIFFALL EXPET THAT IS OS INGLI OR GREATER (OR EQUIVALENT SOOPFALL). CONSTRUCTION SITE INFORMATION OF THE STANDARD OF THE CONSTRUCTION SITE THAT HAVE ROTHER HAVE AND FROBLEDD ALL STRUCTURAL CONTROL HAVANGES IN COST HAVE VEHICLES BRITTED OR STRUCTURAL CONTROL HAVANGES IN THATACHES THAT PROVINCES INSTRUCTION OF THE SAFETY OF THATACHES IN THATACHES IN THE SAFETY OF THE SAFETY OF THATACHES IN THATACHES IN THE SAFETY OF THE S
- ITS SYSTEM.

 SI ALL SITE EROSION AND SEDIMENT CONTROL MEASURES AND BEST MANAGEMENT FRACTICES SHALL BE THE RESPONSIBILITY OF THE ORDERAL DELIVERY OF THE CONTROL OF THE STORY OF THE POLLITION FREVENTION NOTES AND STORYMATER POLLITION REVENTION HOTELY AND STORYMATER POLLITION REVENTION HOTELY SHALL HAVE AND CONTRETT THE REQUIRED REPAIRS WITHIN FORTY-BISHT (4s) HORSE OF THE RESPONSIBILITY OF THE STORY OF THE RESPONSIBILITY OF THE POLITION REVENTION OF THE RESPONSIBILITY OF THE POLITION REVENTION OF THE RESPONSIBILITY OF THE POLITION REVENTION OF THE RESPONSIBILITY OF THE RESP
- 5.2. CONTRACTOR IS RESPONSIBLE FOR INSTALLATION OF ANY ADDITIONAL STRUCTURAL CONTROL MEASURES NECESSARY TO PREVENT EROSION AND SEDIMENTATION AS DETERMINED BY THE SITE INSPECTIONS.
- PERFORM STREET CLEANING OPERATIONS AND OTHER BEST MANAGEMENT PRACTICES AS NEEDED.
- PERFORM SITE CLEARING AND GRUBBING AND REMOVE EXISTING VEGETATION AS NEIDED FOR INITIAL SITE GRADING OPERATIONS. VEGETATED SITE AREAS THAT ARE NOT INCLUDED WITH THE INITIAL GRADING SHALL REHAIN SILD FEMAN SILD
- 7. REMOVE ALL ITEMS NOTED FOR REMOVAL IN THE DEMOLITION PLAN.
- PERFORM ROUGH GRADING OPERATIONS, CONSTRUCT OVERFLOW ROUTES, AND STABILIZE ALL DISTRIBED AREAS, INCLUDING BUT NOT LIMITED TO STEEP SLOPES, DRAINAGE CHANGLES AND SYNLES (E.E. THEPORARY AND FERMANENT SEEDINS, ERGISIO CONTROL BLANKETS, RIP-RAP, CHECK DAYS, TEMPORARY DRAINAGE DIVERSIONS, EXC.
- 9. INSTALL TEMPORARY CONCRETE WASHOUT FACILITY.
- IO. INSTALL BUILDING FOUNDATIONS AND BEGIN BUILDING CONSTRUCTION.
- II. INSTALL DETENTION SYSTEMS, STORM SEVERS AND OTHER SITE UTILITIES AND IMMEDIATELY INSTALL DRAINAGE INLET AND OUTLET PROTECTION DEVICES AS INDICATED ON THE PLANS.
- PROVIDE TEMPORARY SEEDING AND/OR MULCHING FOR ALL DISTURBED SITE AREAS THAT WILL NOT BE WORKED ON FOR MORE THAN FOURTEEN (14) DAYS.
- INSTALL CURBS AND BEGIN SITE PAVING OPERATIONS (I.E. DRIVEWAYS, SIDEWALKS, ETC.).
- 14 COMPLETE BUILDING CONSTRUCTION AND REMAINING SITE IMPROVEMENTS
- REMOVE TEMPORARY SITE EROSION AND SEDIMENT CONTROL MEASURES WITHIN THIRTY (3O) DAYS OF FINAL SITE STABILIZATION.
- I6. SUBMIT A NOTICE OF TERMINATION (N.O.T.) TO THE ILLINOIS ENVIRONMENTAL PROTECTION AGENCY UPON COMPLETION OF ALL SITE CONSTRUCTION AND FINAL SITE STABILIZATION (IE. OVER TOR VEGETATIVE COVER).


CONTROL CONSTRUCTION SCHEDULE

OUP GR

ELECTRICAL \ PLUMBING \

CAL

C-7.1

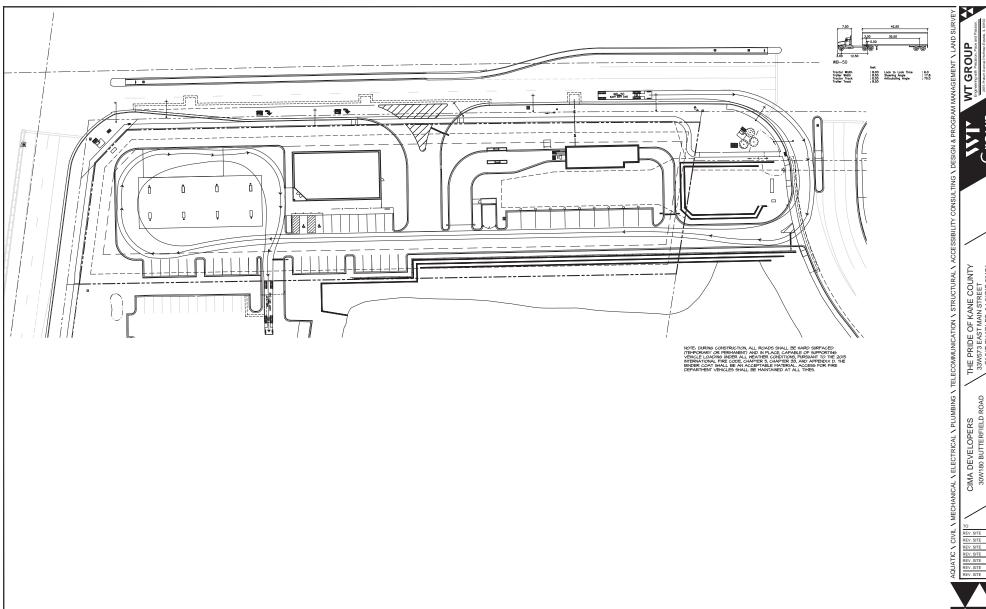

THE PRIDE OF KANE COUNTY
33W573 EAST MAIN STREET
SAINT CHARLES, ILLINOIS 60174

CIMA DEVELOPERS 30W180 BUTTERFIELD ROAD WARRENVILLE, IL 60555

ISSUE TO DATE
REV. SITE 8/19/19
REV. SITE 8/26/19
REV. SITE 1/13/20
REV. SITE 2/1/20
REV. SITE 2/11/20
REV. SITE 2/19/20
REV. SITE 6/8/20



TOPOGRAPHIC SURVEY

NOTES:

- SITE BENCHMARK SET CROSS ON SSE BOLT OF HYDRANT LOCATED APPROXIMATELY 4.3 OF EAST MAIN STREET AND 290' E OF KIRK ROAD, AS SHOWN. ELEVATION=789.75' (NAVD88
- THE LOCATION OF UNDERGROUND UTILITIES WAS DETERMINED BY FIELD OBSERVATION AN VISIBLE MARKINGS ONLY.
- 3. FIELD WORK COMPLETED ON 3/5/2019
- 4. SURVEY PREPARED FOR: CIMA DEVELOPERS, INC.
- 5. ANY DISCREPANCIES FOUND WITHIN THIS DOCUMENT NEED TO BE REPORTED TO THE SURVEYOR AS SOON AS POSSIBLE.

8 PROGRAM MAN

GROUP

EAST MAIN STREET



STATE OF ELINOIS) SS

WE THE WIT GROUP DO HEREBY DECLARE THAT THIS TOPOGRAPHIC SURVEY WAS MADE UNDER OUR DIRECTION AND SUPERVISION. THIS PROFESSIONAL SERVICE CONFORMS TO TICKPRENT LUNGS WINMIN STANDARDS FOR TOPOGRAPHIC SURVEYS.

GIVEN UNDER OUR HAND AND SEAL THIS __12TH__ DAY OF ___ AT HOFFMAN ESTATES, NUMBER

The w-1 choir, inc




CHECKEM

ISSUE

93W573 EAST MAIN STREET SAINT CHARLES

SUR-1

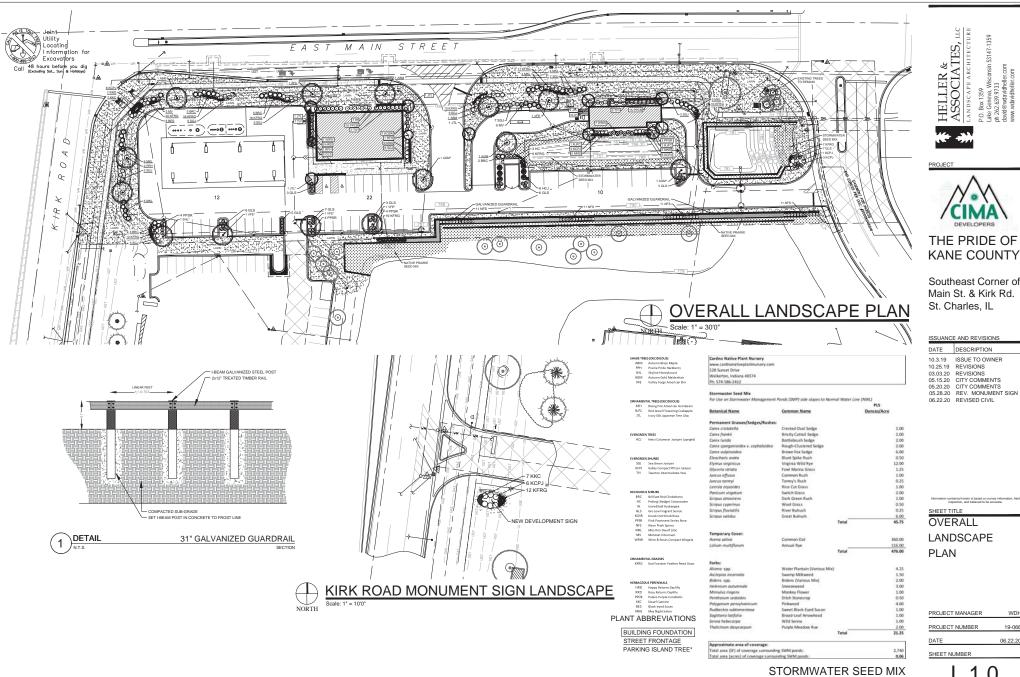




THE PRIDE OF

Southeast Corner of Main St. & Kirk Rd.

10.3.19 ISSUE TO OWNER 05.20.20 CITY COMMENTS 05.28.20 REV. MONUMENT SIGN

19-066 06.22.20

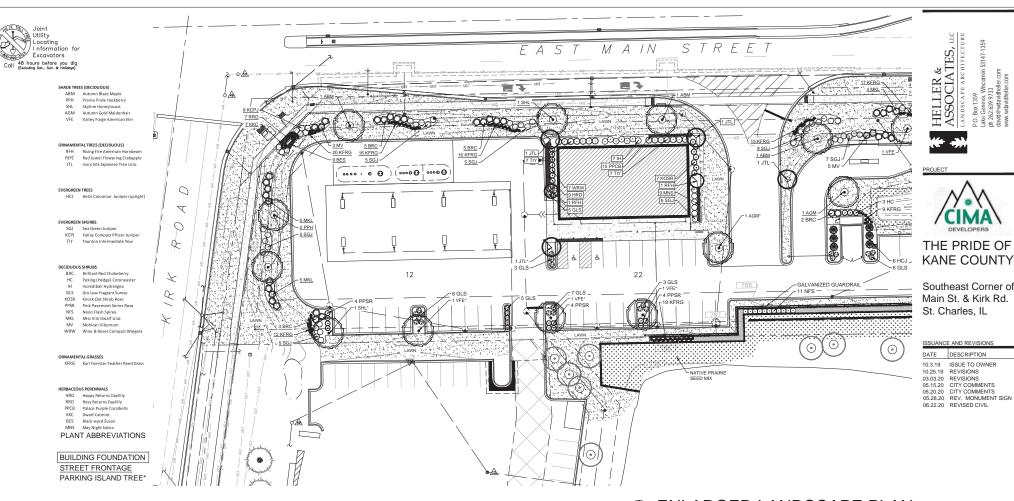




SHEET TITLE ENLARGED LANDSCAPE PLAN

HELLER & ASSOCIATES, LLC LANDSCAPE ARCHITECTURE

PROJECT MANAGER PROJECT NUMBER 19-066 DATE 06.22.20 SHEET NUMBER

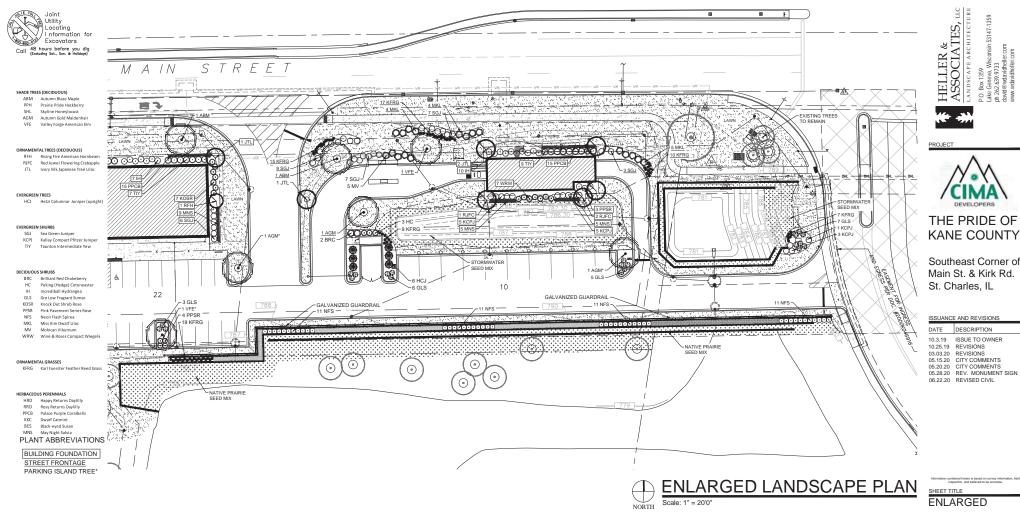


THE PRIDE OF KANE COUNTY

DATE DESCRIPTION 10.3.19 ISSUE TO OWNER 05.15.20 CITY COMMENTS 05.20.20 CITY COMMENTS 05.28.20 REV. MONUMENT SIGN

LANDSCAPE PLAN


PROJECT MANAGER PROJECT NUMBER 19-066 DATE 06.22.20 SHEET NUMBER

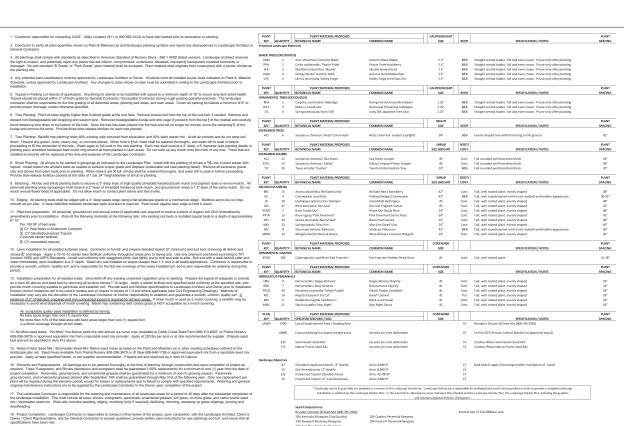

LANDSCAPE GENERAL NOTES

PLANT & MATERIAL SCHEDULE



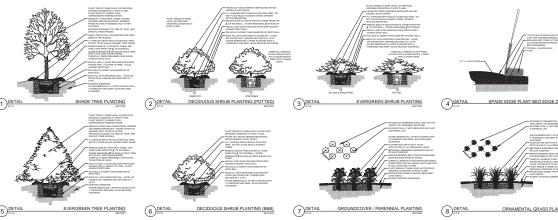

PLANTING & HARDSCAPE DETAILS

Information contained herein is based on survey information, fi inspection, and believed to be accurate. SHEET TITLE

HELLER & ASSOCIATES, LLC LANDSCAPE ARCHITECTURE

THE PRIDE OF KANE COUNTY

Southeast Corner of Main St. & Kirk Rd. St. Charles, IL

DATE	DESCRIPTION
10.3.19	ISSUE TO OWNER
10.25.19	REVISIONS
03.03.20	REVISIONS
05.15.20	CITY COMMENTS
05.20.20	CITY COMMENTS IGN
05.22.20	REV. MONUMENT SIGN
06.22.20	REVISED CIVIL


LANDSCAPE
DETAILS, NOTES,
& SCHEDULES

 PROJECT MANAGER
 WDH

 PROJECT NUMBER
 19-066

 DATE
 06.22.20

 SHEET NUMBER

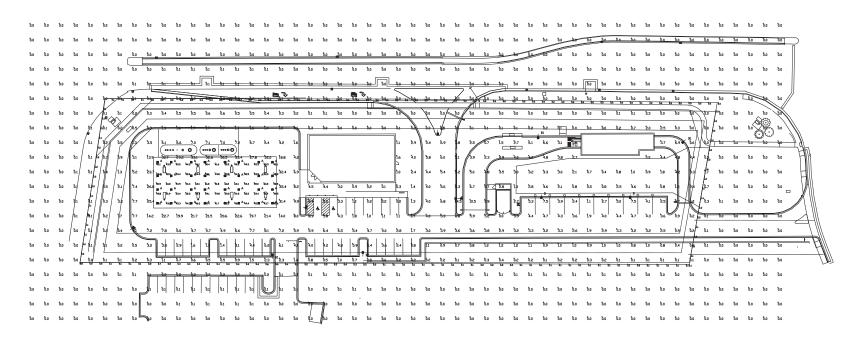

Luminaire Sched	Luninaire Schedule								
Symbol	Qty	Label	Arrangement	Description	LLD	UDF	LLF	Arr. Lum. Lumens	Arr. Watts
	35	A	SINGLE	SCV-LED-15L-SC-50 MTD € 15'	1.000	1.000	1.000	15410	103
-	3	В	SINGLE	SLM-LED-18L-SIL-FT-50-70CRI-SINGLE-16'PDLE+2'BASE	1.000	1.000	1.000	19664	148.5
-	6	B1	SINGLE	SLM-LED-18L-SIL-FT-50-70CRI-IL-SINGLE-16'PDLE+2'BASE	1.000	1.000	1.000	12568	148.5
	1	С	D180	SLM-LED-18L-SIL-FT-50-70CRI-D180-16'PDLE+2'BASE	1.000	1.000	1.000	39328	297

Calculation Summary							
Label	CalcType	Units	Avg	Max	Min	Avg/Min	Max/Min
ALL CALC POINTS	Illuminance	Fc	1.52	35.4	0.0	N.A.	N.A.
CANDPY	Illuminance	Fc	50.74	63.1	41.6	1.22	1.52
EAST PROPERTY LINE	Illuminance	Fc	0.31	1.6	0.0	N.A.	N.A.
NORTH PROPERTY LINE	Illuminance	Fc	0.07	0.3	0.0	N.A.	N.A.
SOUTH PROPERTY LINE	Illuminance	Fc	0.20	0.7	0.0	N.A.	N.A.
WEST PROPERTY LINE	Illuminance	Fc	0.11	0.2	0.0	N.A.	N.A.
INSIDE CURB	Illuminance	Fc	7.21	35.4	0.0	N.A.	N.A.



Click image to open Product Page

ased on the information provided, all dimensions and luminaire locations hown represent recommended positions. The engineer and/or architect must etermine the applicability of the layout to existing or future field conditions.

The lighting plan represents librarious invest construct of the plant plant plant perspective for the plant plant



I HEREBY CERTIFY THAT THE PERSONS WHOSE NAMES ARE SUBSCRIBED TO THE FOREGOING CERTIFICATE ARE KNOWN TO ME AS SUCH OWNERS.

GIVEN UNDER MY HAND AND SEAL THIS _____ DAY OF _____, A.D. ____

NOTARY PURITO

MY COMMISSION EXPIRES: ____

I, FURTHER CERTIFY THAT I HAVE RECEIVED ALL STATUTORY FEES IN CONNECTION WITH THIS DIAT.

COUNTY CLERK

GIVEN UNDER MY HAND AND SEAL OF THE COUNTY CLERK OF KANE COUNTY, ILLINOIS,

GROUP

M

TELECOMMUNICATION \ STRUCTURAL \ ACCESSIBILITY PLAT OF ANNEXATION
PRIDE OF KANE COUNTY
33W573 EAST MAIN STREET
SAINT CHARLES, ILLINOIS

SIMA DEVELOPERS 30W180 BUTTERFIELD R WARRENVILLE, IL 6055

MECHANICAL \ ELECTRICAL \ PLUMBING \

THS IS TO CERTIFY THAT I, FRANJO I. MATIOC, ILLNOS PROFESSIONAL LAND SURVEYOR NO. 3568, HAVE PREPARED THIS PLAT FROM EXISTING PLATS AND RECORDS FOR THE PURPOSE OF AMEXIATION TO THE CITY OF ST. CHARLES, ILLNOS, AS SHOWN BY THE PLAT HEREON DRAWN. DISTANCES ARE SHOWN IN FEET AND DECIMAL PARTS THEREOF.

GIVEN UNDER OUR HAND AND SEAL THIS ______ DAY OF ______
ESTATES, ILLINOIS.

FOR REVIEW 06/02/20

FRANJO I. MATICIC - PLS #035-003556 EXPIRES 11/30/2016 ILLINOIS PROFESSIONAL DESIGN FIRM LICENSE NO. 184-004387

THE W-T GROUP, LLC.

ISSUE

DRAWN:KCH

ANNEX-1

NOTARY PUBLIC

MY COMMISSION EXPIRES: _____

BASIS OF BEARINGS IS TRUE NORTH BASED ON ILLINOIS STATE PLANE COORDINATE SYSTEM, ILLINOIS FAST 1201 ZONE.

PRELIMINARY PLAT OF SUBDIVISION PRIDE OF KANE COUNTY






PIN NUMBER: 09-25-100-036

GROUP

5

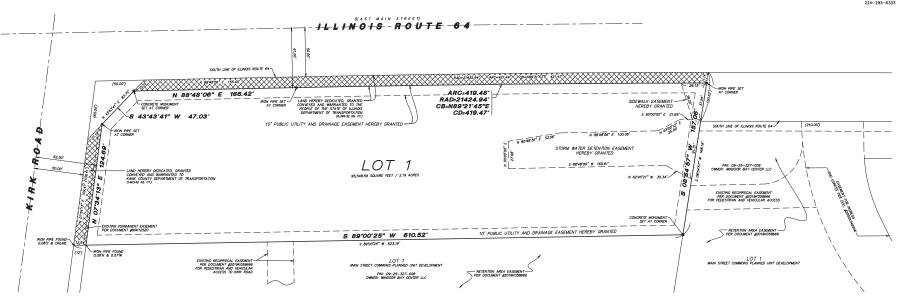

THIS _____ DAY OF _____

____, A.D. ____

BE SURVEYED, SUBDIVIDED AND PLATED AS SHOWN THEREON FOR THE USES AND PURPOSES THEREIN SET FORTH AND DOES HEREBY ACKNOWLEDGE AND ADOPT THE SAME UNDER THE STYLE AND TITLE THEREON SHOWN.		
THE UNDERSIGNED DO HEREBY CERTIFY THAT, AS OWNERS OF THE PROPERTY DESCRIBED IN THE SURVEYOR'S CERTIFICATE, TO THE BEST OF THEIR KNOWLEDGE, IS LOCATED WITHIN THE BOUNDARIES OF ST. CHARLES COMMUNITY UNIT SCHOOL DISTRICT 303.	CITY COUNCIL CERTIFICATE	
DATED THIS DAY OF A.D	STATE OF ILLINGS) SS COUNTY OF KANE)	SPECIAL ASSESSMENT CERTIFICATE
8Y:	APPROVED THIS DAY OF A.D BY THE COUNCIL OF THE CITY OF ST. CHARLES.	STATE OF
ADDRESS:	MAYOR	CURRENT OF FORFEITED SPECIAL ASSESSMENTS OR ANY DEFERRED INSTALLMENTS THEREOF THAT THAT HAVE BEEN APPORTIONED AGAINST THE TRACT OF LAND ROLLIDED IN THE PLAT.
	GTY CLERK	COLLECTOR OF SPECIAL ASSESSMENTS DATED AT ST. CHARLES, ILLINOIS, THIS DAY OF A.D
NOTARY CERTIFICATE		
STATE OF) SS COUNTY OF)	DIRECTOR OF COMMUNITY DEVELOPMENT CERTIFICATE	
LISTERY CERTIFY THAT. A NOTARY PUBLIC, IN AND FOR SAD COUNTY, IN THE STATE AFGRESAD, DO INTERPRETABLE OF THE SAME PRISONED IN THE TOP SECOND STRUMENT AS SUCH OWNERS, APPLAND ECTORS ME MICH AMERICA STRUMENT ACT FOR THE USES AND PURPOSES THEREIN SET FORTH. GIVEN UNDER MY HAND AND SEAL THIS	STATE OF	PLAN COMMISSION CERTIFICATE STATE OF ILLINOIS) SS COUNTY OF KAME) APPROVED BY THE PLAN COMMISSION OF THE CITY OF ST. CHARLES.

DATED AT ______, ILLINOIS, THIS _____ DAY OF _____, .D. 20___

DIRECTOR OF COMMUNITY DEVELOPMENT

PORTATION DEDICATION DESCRIPTION
PORTATION DEDICATION DESCRIPTION
PORTATION DEDICATION DESCRIPTION

ILLINOIS DEPARTMENT OF TRANSPORTATION CERTIFICATE

THIS PLAT HAS BEEN APPROVED BY THE ILLINOS DEPARTMENT OF TRANSPORTATION WITH RESPECT TO ROADWAY ACCESS PURSUANT OF §2 OF "AN ACT TO REVISE THE LAW IN RELATION TO PLATS," AS AMENDED. A PLAN THAT HERS THE REQUIREDHTS CONTAINED IN THE DEPARTMENTS "POLICY ON PERMITS FOR ACCESS DRIVEWAYS TO STATE HIGHWAYS" WILL BE REQUIRED BY THE DEPARTMENTS.

PORTATION CERTIFICATE
THE STATE OF ILLINOIS, DEPARTMENT
ATE: 20

CIMA DEVELOPERS 30W180 BUTTERFIELD ROAD WARRENVILLE, IL 60555 ISSUE

MECHANICAL \ ELECTRICAL \ PLUMBING \ TELECOMMUNICATION \ STRUCTURAL \ ACCESSIBILITY CONSULTING \ D

PLAT OF SUBDIVISION
PRIDE OF KANE COUNTY
33W573 EAST MAIN STREET
SAINT CHARLES, ILLINOIS

SUB-1

	GEND PROPERTY LINE
	CENTERLINE OF RIGHT OF WAY
	UNDERLYING PROPERTY LINES
	SET CONCRETE MONUMENT / SET IRON PI
(2001)	RECORD PROPERTY DIMENSIONS
XXXXXXXXXX	RIGHT OF WAY (HEREBY DEDICATED)

PRELIMINARY PLAT OF SUBDIVISION PRIDE OF KANE COUNTY

BEING A SUBDIVISION IN THAT PART OF THE NORTHWEST 1/4 OF SECTION 25, TOWNSHIP 40 NORTH, RANGE 8 EAST OF THE THRD PRINCIPAL MERIDIAN, IN THE TOWNSHIP AND CITY OF ST. CHARLES, KAME COUNTY, ILLINOIS.

AFTER RECORDING RETURN TO: CITY OF ST. CHARLES 2 E. MAIN STREET ST. CHARLES, IL 60174

PIN NUMBER: 09-25-100-036

DESIGNER/ENGINEER THE W-T GROUP, LLC 2675 PRATUM AVE HOFFMAN EST, IL 60192 224-293-6333

STATE OF ILLINOS) COUNTY RECORDER'S CERTIFICATE SS COUNTY OF KANE)
THE UNDERSIONED AS THE RECORDER OF DEEDS FOR KANE COUNTY DO HEREBY CERTIFY THAT INSTRUMENT NUMBER
RECORDER OF DEEDS
PLEASE PRINT/TYPE NAME
STATE OF ILLINOS) SCOUNTY ENGINEER'S CERTIFICATE SCOUNTY OF KAME)
THIS PLAT HAS BEEN APPROVED BY THE KANE COUNTY ENGINEER WITH RESPECT TO ROADWAY ACCESS TO
COUNTY ENGINEER DATED AT BLINDIS, THIS DAY OF0. 20
COUNTY CLERK'S CERTIFICATE STATE OF ILLINOS) SS
COUNTY OF KANE) L. THAT THERE ARE NO DELINQUENT COMERAL TAXES, NO UNFAID FORFEITED TAXES, AND NO REDEMABLE TAX SALES AGAINST ANY OF THE LIMB INCLUDED IN THIS PLAT.
I, FURTHER CERTIFY THAT I HAVE RECEIVED ALL STATUTORY FEES IN CONNECTION WITH THIS PLAT.
GIVEN UNDER MY HAND AND SEAL OF THE COUNTY CLERK OF KANE COUNTY, ILLINOIS,
THIS DAY OF, A.D.,20
COUNTY CLERK
STATE OF ILLINOIS) SS COUNTY OF KANE)
THE UNDERSIONED AS THE RECORDER OF DEEDS FOR KAME COUNTY DO HEREBY CERTIFY THAT INSTRUMENT NUMBERWAS FILED FOR RECORD IN THE RECORDER'S OFFICE OF KAME COUNTY, LLINIOS ON THE DAY OF
RECORDER OF DEEDS
PLEASE PRINT/TYPE NAME

PUBLIC UTILITY AND DRAINAGE LASEARY PROVISIONS

A ETRAMENT HON-EXCLUSIVE EASEARY IS HEREY CONVETE TO THE OT OF ST.

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FRANCISE GANTHIO, THE LESSIBLY BROTTS FROM SAD OTTO OF ST. OMAGES

FRANCISE GANTHIO, THE LESSIBLY BROTTS FROM SAD OTTO OF ST. OMAGES

FRANCISE GANTHIO, THE SECRET HOST ST. OMAGES

AND A ASSORD FRENCH CULLETURE, PETERDE TO AS "OMAGES", AND ASSORD GENERAL OF THE ST.

MARKET ST. OMAGES

FRANCISCO ST.

MARKET ST. OMAGES

MARKET ST. OMA

SURVEYORS CERTIFICATE

STATE OF ILLINOIS) SS COUNTY OF COOK)

THIS IS TO STATE THAT I, FRANJO I. MATICIC, ILLINOIS PROFESSIONAL LAND SURVEYORS #035-003556, HAVE SURVEYED AND SUBDIVIDED THE FOLLOWING DESCRIBED PROPERTY:

THIS IS O STATE THAT I, PRANJO I, MATIOC, LINGOF PROFESSIONAL LARGE SURVIVORS (2023—0,00056), HAVE SURVIVORD AND S

I FURTHER CERTIFY THAT THE PLAT HEREON DRAWN IS A CORRECT AND ACCURATE REPRESENTATION OF SAID SURVEY AND SUBDIVISION. ALL DISTANCES ARE SHOWN IN FEET AND DECIMAL PARTS THEREOF.

I FURTHER CRETET THAT I MILL SET ALL SUBDIVISION MONUMENTS AND HAVE DESCRIBED THEM ON THIS FINAL PLAT AS REQUIRED BY THE PLAT ACT (758 LCS 205/). THE EXTERIOR SUBDIVISION MONUMENTS HAVE BEEN SET AND INTERIOR MONUMENTS WILL BE SET WITHIN 12 MONTHS OF THE RECORDING OF THIS PLAT (SECTION 1270-56 OF THE ILLINGS) PROFESSIONAL LAND SURVEYOR ACT OF 1989)

GIVEN UNDER OUR HAND AND SEAL THIS ______ DAY OF ______ A.D.____. AT HOFFMAN ESTATES, ILLINOIS.

FOR REVIEW 06/03/20 FRANJO I. MATICIC - PLS #035-003556 EXPIRES 11/30/2020 ILLINOIS PROFESSIONAL DESIGN FIRM LICENSE NO. 184.007570-0015 GROUP ⋝


PLAT OF SUBDIVISION
PRIDE OF KANE COUNTY
33W573 EAST MAIN STREET
SAINT CHARLES, ILLINOIS


ERFIELD ROAD LE, IL 60555 DEVELOPERS 180 BUTTERFIELD ARRENVILLE, IL 606


ISSUE

CLIENT

SUB-2

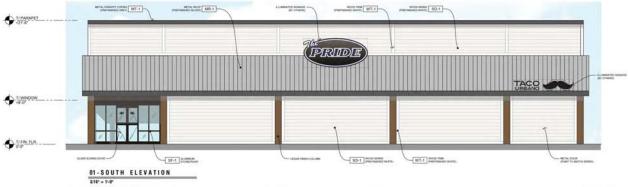

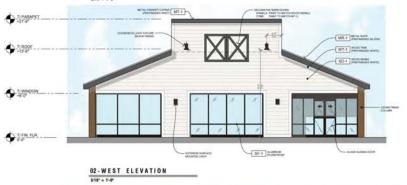

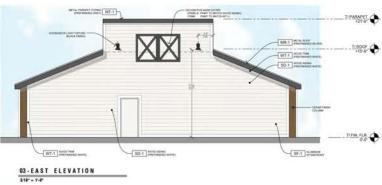


MR-1 METAL ROOM
preprospects severe MT-1 METAL PROMPET SOPHIS PRIDE +8':0" TIFIN FLR. SF-1 ACAMON 04 - N O R T H E L E V A T I O N

(PRIDE)







02 - WEST ELEVATION
3/16" = 1'-0"

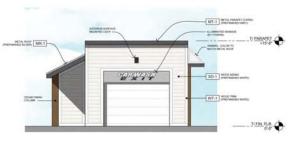

03 - EAST ELEVATION

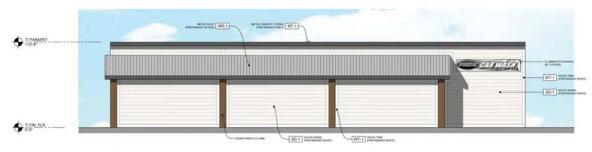

04 - SOUTH ELEVATION

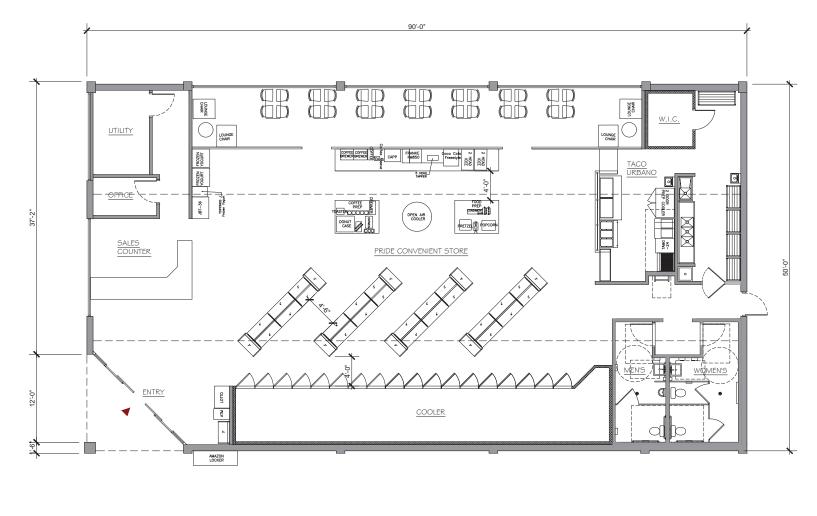

C - S T O R E P L A N

1/4" = 1'-0"




B RETAIL CANOPY






Project Name	PBL#	Customer	Created by	Prood Pook	
ExxonMobil	-	ExxonMobil	B.Dighero	Brand Book Site Image Materials Maintenan	
Revision #	Date	Scale	Page #	2 Northfield Plaza, Ste 250 Northfield, IL 60093	
R2	05/ 26/ 2020	NA	5 OF 16	P: (847) 441-1818 F: (847) 592-9564	

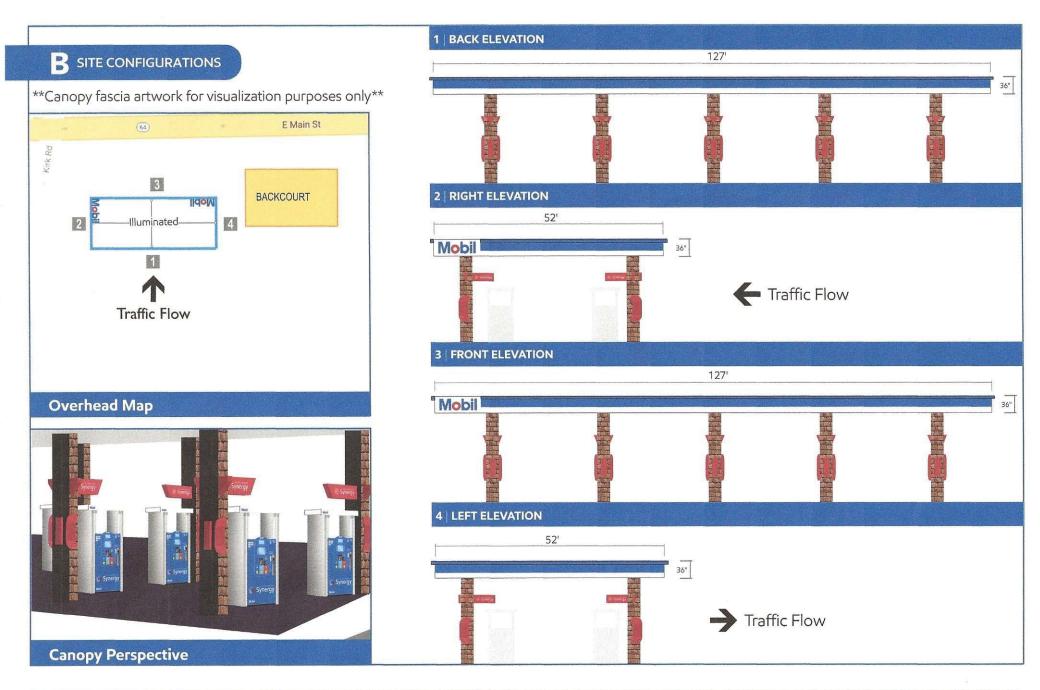

Project Name	PBL#	Customer	Created by	Bood Book
ExxonMobil	-	ExxonMobil	B.Dighero	Brand Book Site Image Materials Maintenance
Revision #	Date	Scale	Page #	2 Northfield Plaza, Ste 250 Northfield, IL 60093
R3	06_18_2020	NA	4 OF 13	P: (847) 441-1818 F: (847) 592-9564

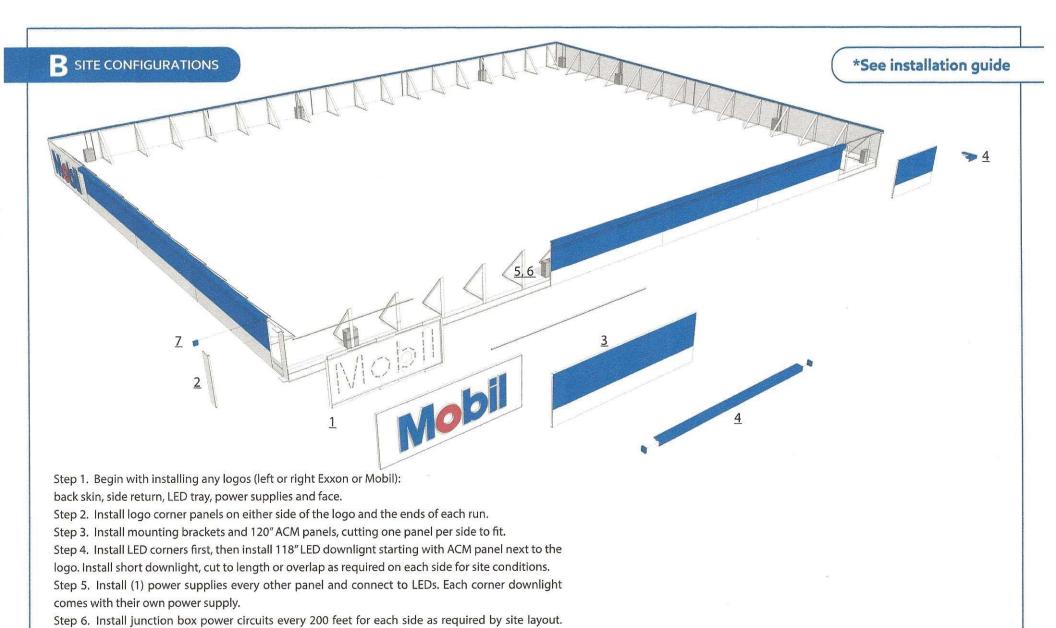


Project Name	PBL#	Customer	Created by	
ExxonMobil	· -	ExxonMobil	B.Dighero	Brand Book Site Image Materials Maintenance
Revision #	Date	Scale	Page #	2 Northfield Plaza, Ste 250 Northfield, IL 60093
R2	05/ 26/ 2020	NA	9 OF 16	P; (847) 441-1818 F: (847) 592-9564

Electrician to connect to 120VAC.

Step 7. Install end caps.

R SITE CONFIGURATIONS *See installation guide #8 X 3/4" k-lathe screws 100.000" zinc plated, painted white 73.927" Qty: (6) @ top SINGLE LETTER SPECS: "M" = 2.88 sq ft 7.287" Translucent white sign grade #12 X 7 Tek screws "o" = 1.44 sq ftpolycarbonate (2447) with zinc plated, Qty: (10) "b" = 1.83 sq ft50% transmission Attaches .063 aluminum "i" = .80 sq ftback skin to canopy "I" = .83 sq ft36.000" TOTAL = 7.78 sq ft structure 36.000" 22.030" 22,445" 1.620" -O.D. LETTER SPECS: 22.445" X 73.927" = 11.5 SF SIGN SPECS: Translucent Mobil Blue vinyl 36" X 100" = 25 SF applied to front face: UL NUMBER: E84811 3M 3630-8248, PMS 293C Translucent Mobil Red vinyl 1.500" FRONT VIEW - PUSH THRU LETTERS IN FACE applied to front face: #8 X 3/4" k-lathe screws Appx weight of sign = 75lbs END VIEW 3M 3630-2590, PMS 485C zinc plated, painted white Qty: (6) @ bottom 99.625" (40) Streetfighter LED .72W / module 28.08W Total Power Supply w/ switch 60W power supply 120 - 277VAC 120VAC / 12VDC 1.1A - .45A 60W / 12VDC 35.625" .063" aluminum pre-paint white with 1/4" X 1" neoprene gasket PN 394204 **END VIEW** INTERNAL DETAILS **NIGHT VIEW**

Project Name	PBL#	Customer	Created by	Brand Book
ExxonMobil	-	ExxonMobil	B.Dighero	Site Image Materials Maintenance 2 Northfield Plaza, Ste 250 Northfield, IL 60093
Revision #	Date	Scale	Page #	
R2	05/ 26/ 2020	NA	8 OF 16	P: (847) 441-1818 F: (847) 592-9564

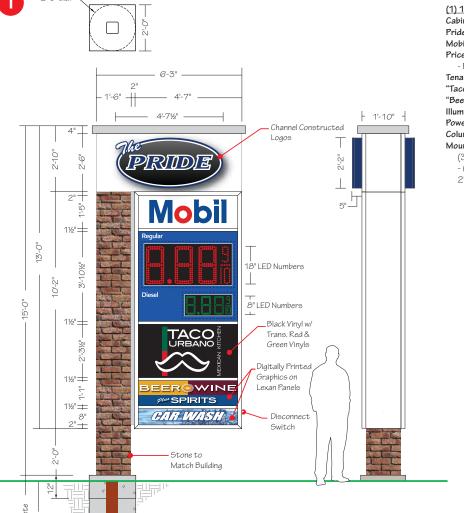

(1) 13'-0" x 6'-3" Double Face Illuminated Flag Mounted Sign - 81.25 SF

Cabinet: Fabricated Aluminum Painted White - Satin Finish

Pride Logos: 5" Deep Fabricated Channel Letter - Decorated White Acrylic Face - White LED Illumination

Mobile Logos: 3M 3630-97 Bristol Blue & 143 Poppy Red Translucent Vinyls Pricer Panel: 3M 3630-97 Bristol BlueTranslucent Vinyl - Copy Reversed Out White

- Pricer Units: 16" LED & 12" LED

Tenant Panels: White Polycarbonate

"Taco Urbano" Graphics: 3M 7725-12 Black / 3630-76 Holly Green / 3630-33 Red Vinyls "Beer Wine Liquor" & Car Wash Panels: White Polycarbonate w/ Digitally Printed Graphics

Illumination: White LEDs

Power: (2) 20Amp @ 120Volts Electrical Circuits Run to Site by Others

Column: CMU Block w/ Brick to Match Building

Mounting: (1) HSS 6" x 6" x 3/8" ASTM A-500 Gr. B with

(3) 4" x 4" x 3/16" ASTM A-500 Gr. B Steel Mounting Plates

- (1) 2'-0" dia. x 8'-0" deep Concrete Foundation w/

2'-0" W x 2'-0" L x 12" D Square Concrete Pad for Masonry



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SIGN COMPANY

Design • Fabrication • Installation • Maintenance 165TubewayDrive CarolStream Illinois60188 Tel/630-510-2020 • Fax/630-510-2074 e-mail/signs@parvinclauss.com www.parvinclauss.com

PROJECT:



SEC Kirk Road & Main Street (Rt. 64) St. Charles, IL

CUSTOMER APPROVAL:

AUTHORIZED SIGNATURE

REPRESENTATIVE

House / RM / KZ

DRAWN BY

Bill Marlow

DATE

10.23.19

SCALE

SHEET NO. 1 of 12

WORK ORDER

82989

3/8" = 1'

FILE NAME PRD82989

REVISIONS:


11.04.19 - center sundry cab

5.18.20 - new layout

3 5.19.20 - size adjustments

4 5.26.20 - Taco Urbano Logo

This sign is intended to be installed in accordance with the requirements of Article 600 of the National Electrical Code and/or other applicable local codes. This includes proper grounding and bonding of the sign.

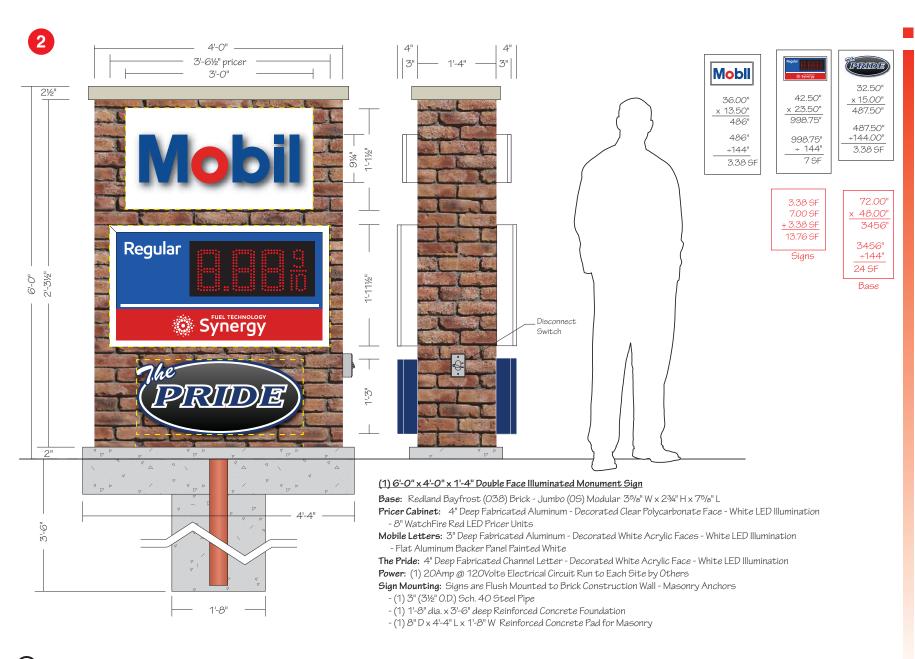

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PROJECT:



SEC Kirk Road & Main Street (Rt. 64) St. Charles, IL

CUSTOMER APPROVAL:

DATE

AUTHORIZED SIGNATURE

REPRESENTATIVE

House / RM / KZ

DRAWN BY

Bill Marlow

DATE

10.23.19

SCALE 1" = 1'

SHEET NO. 2 of 12

WORK ORDER

82989

FILE NAME PRD82989

REVISIONS:

11.04.19 - all cabs. on brick area

2 5.18.20

3 5.19.20


4 5.26.20 - Mobil letters / cab. depth

61020

7

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o

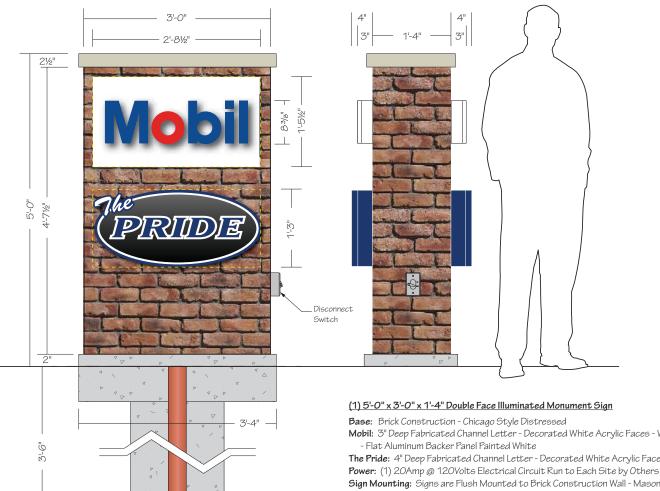

1'-8"

32.50" x 17.50" 568.75" 568.75" ÷144" 4 SF

(PRIDE 32.50" x 15.00" 487.50" 487.50" ÷144" 3.38 SF

4.00 SF + 3.38 SF 7.38 SF

Signs

60" x 36" 2160"

2160" ÷ 144" 15 SF

Base

Mobil: 3" Deep Fabricated Channel Letter - Decorated White Acrylic Faces - White LED Illumination

The Pride: 4" Deep Fabricated Channel Letter - Decorated White Acrylic Face - White LED Illumination

Sign Mounting: Signs are Flush Mounted to Brick Construction Wall - Masonry Anchors

- (1) 3" (3½" O.D.) Sch. 40 Steel Pipe

- (1) 1'-8" dia. x 3'-6" deep Reinforced Concrete Foundation

-(1) 8" D x 3'-4" L x 1'-8" W Reinforced Concrete Pad for Masonry



SEC Kirk Road & Main Street (Rt. 64) St. Charles, IL

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AUTHORIZED SIGNATURE

REPRESENTATIVE

PROJECT:

House / RM / KZ

DRAWN BY

Bill Marlow

DATE

10.23.19

SCALE 1" = 1'

SHEET NO.

3 of 12

WORK ORDER

82989

FILE NAME PRD82989


REVISIONS:

11.04.19

2 5.18.20

3 5.19.20

4 5.26.20 - Mobil letters / cab. depth

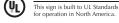

2'-0" A" Stand Off Rings A" Stand Off Rings A" Stand Off Rings

3-0

(1) Single Face Fingerpost Directional Sign

Pole: 4" Aluminum - Smooth - Painted Black - Ball Cap

Finger Panels: .125" Aluminum Painted Black w/ Reflective White Vinyl In-line Border

Mobil & The Pride Logos: Digitally Printed on White Vinyl Applied Panda Express Logo: Digitally Printed on White Vinyl Applied

Orangetheory Logo: 3M 7725-14 Bright Orange, 53 Cardinal Red & 31 Medium Gray Vinyls Applied

STOP Sign: (1) Std. 30" x 30" Applied to .125" thick Black Aluminum Backer Panel

- See Detail A for Attachment Hardware

Mounting: Direct Burial in 1'-0" dia. x 3'-6" deep Concrete Foundation



DETAIL A - Post Brackets

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CUSTOMER APPROVAL:

DATE

AUTHORIZED SIGNATURE

REPRESENTATIVE

House / RM / KZ

DRAWN BY

Bill Marlow

DATE

10.23.19

SCALE 3/4" = 1'

SHEET NO. 4 of 12

WORK ORDER

82989

FILE NAME PRD82989

REVISIONS:

111.04.19

2 5.18.20

3 5.19.20

4 5.26.20

5 6.19.20

0.10.20

o









NAN ALLIM RETURNS 1" JEWELITE TRIMCAP .187 WHITE ACRYLIC .187 CLEAR POLYCARBONATE BACK 2" DEEP ALUMINUM BACKER PANEL PAIGE WALL BUSTER TWO-PART THROUGH WALL WIRING PROTECTION DEVICE LED POWER SUPPLY IN VENTED BOX LED STRIP LIGHTING MASONRY ANCHORS CLIP (TYP.) 1/4" DIA DRAIN HOLES (MIN 2 PER LETTER

3" DEEP U/L APPROVED LED-ILLUMINATED CHANNEL LETTER - WIREWAY MOUNT

(1) 5'-45/8" x 11'-81/2" x 2" Deep SF Wall Sign w/ Illuminated Channel Letters

Panel: 2" Deep Fabricated Aluminum Painted PMS 288 Blue - Smooth Satin Finish

Faces: .125" Aluminum Painted PMS 288 Blue

Inline Strip: 3M 7725-10 White Vinyl

Black/Grey Gradient: Digitally Printed on Orajet 3751 RA White Vinyl Applied to Face

Letters & White In-line: Fabricated 3" Deep Channel Letters

"The" Returns: .040" Aluminum Painted PMS 288 Blue- 1" White Trimcap


"PRIDE" & In-line Returns: .040" Pre-finished White Aluminum - 1" White Trimcap

Faces: 7328 White Acrylic w/ Avery UC 900-684T PMS 288 Blue Translucent Vinyl Applied to Faces

Illumination: White LEDs with Remote 60Watt Power Supplies

Power: Use Existing at Site

Mounting: Flush to Building with Anchors Appropriate for Wall Construction

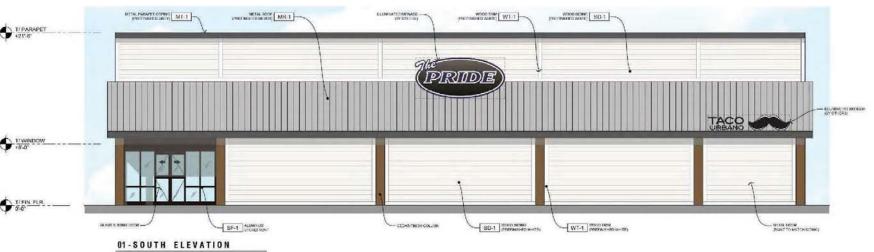

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PROJECT:



SEC Kirk Road & Main Street (Rt. 64) St. Charles, IL

CUSTOMER APPROVAL:

AUTHORIZED SIGNATURE

REPRESENTATIVE

House / RM / KZ DRAWN BY Bill Marlow DATE 10.23.19

SCALE 1/2" = 1'

SHEET NO.

WORK ORDER

82989 FILE NAME PRD82989

5 of 12

REVISIONS:

2 5.18.20

3 5.19.20

4 5.26.20

⁵ 6.19.20 - New Elevation

This sign is intended to be installed in accordance with the requirements of Article 600 of the National Electrical Code and/or other applicable local codes. This includes proper grounding and bonding of the sign.

This sign is built to UL Standards



NAN ALLIM RETURNS 1" JEWELITE TRIMCAP .187 WHITE ACRYLIC .187 CLEAR POLYCARBONATE BACK 2" DEEP ALUMINUM BACKER PANEL PAIGE WALL BUSTER TWO-PART THROUGH WALL WIRING PROTECTION DEVICE LED POWER SUPPLY IN VENTED BOX LED STRIP LIGHTING MASONRY ANCHORS CLIP (TYP.) 1/4" DIA DRAIN HOLES (MIN 2 PER LETTER

3" DEEP U/L APPROVED LED-ILLUMINATED CHANNEL LETTER - WIREWAY MOUNT

(1) 5'-45/8" x 11'-81/2" x 2" Deep SF Wall Sign w/ Illuminated Channel Letters

Panel: 2" Deep Fabricated Aluminum Painted PMS 288 Blue - Smooth Satin Finish

Faces: .125" Aluminum Painted PMS 288 Blue

Inline Strip: 3M 7725-10 White Vinyl

Black/Grey Gradient: Digitally Printed on Orajet 3751 RA White Vinyl Applied to Face

Letters & White In-line: Fabricated 3" Deep Channel Letters

"The" Returns: .040" Aluminum Painted PMS 288 Blue- 1" White Trimcap

"PRIDE" & In-line Returns: .040" Pre-finished White Aluminum - 1" White Trimcap

Faces: 7328 White Acrylic w/ Avery UC 900-684T PMS 288 Blue Translucent Vinyl Applied to Faces

Illumination: White LEDs with Remote 60Watt Power Supplies

Power: Use Existing at Site

Mounting: Flush to Building with Anchors Appropriate for Wall Construction



04-NORTH ELEVATION

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PROJECT:



SEC Kirk Road & Main Street (Rt. 64) St. Charles, IL

CUSTOMER APPROVAL:

AUTHORIZED SIGNATURE

REPRESENTATIVE

House / RM / KZ DRAWN BY Bill Marlow DATE

10.23.19 SCALE

1/2" = 1'

6 of 12

SHEET NO.

WORK ORDER

82989

FILE NAME PRD82989

REVISIONS:

11.04.19

2 5.18.20

3 5.19.20

4 5.26.20

5 6.19.20 - New Elevation



(2) 2'-11/2" x 11'-6" x 5" Deep SF Wall Sign

Cabinet: 5" Deep Fabricated Aluminum Painted PMS 288 Blue - Smooth Satin Finish

Faces: 3/16" White Poltcarbonate


Graphics: Digitally Printed on Translucent White Vinyl

Illumination: White LEDs with 12V 60W 120/277V Power Supplies

Power: Use Existing at Site

Mounting: Flush to Building with Anchors Appropriate for Wall Construction



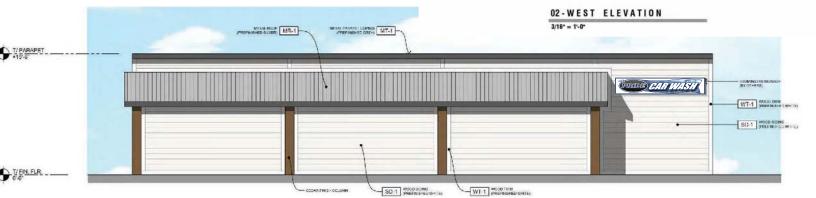

04-SOUTH ELEVATION

Scale: 1/8" = 1'-0"

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PROJECT:

5"



SEC Kirk Road & Main Street (Rt. 64) St. Charles, IL

CUSTOMER APPROVAL:

AUTHORIZED SIGNATURE

REPRESENTATIVE House / RM / KZ DRAWN BY

Bill Marlow DATE 10.23.19

SCALE 1" = 1'

7 of 12 WORK ORDER

82989 FILE NAME PRD82989

REVISIONS:

1 11.04.19

2 5.18.20

SHEET NO.

3 5.19.20


4 5.26.20

⁵ 6.19.20 - New Sign

This sign is intended to be installed in accordance with the requirements of Article 600 of the National Electrical Code and/or other applicable local codes. This includes proper grounding and bonding of the sign.



This sign is built to UL Standards for operation in North America.

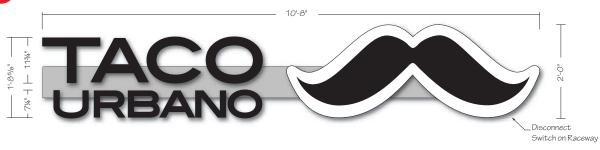

3./4" JEWELITE BLACK TRIMCAP 1.87 WHITE ACEPTIC 1.063 ALUMINUM BACK 1.72" STRAIN RELEF BUSHING LED FOWER SUPPLY LED STRIP LIGHTING MOUNTING HARDWARE TO SUIT MALL COMDITIONS 1/4" DIA DRAIN HOLE (MIN 2 PER LETTER)

(1 set) 5" Deep Illuminated Channel Letters & Logo on Raceway

Letter & Logo Returns: .040" Fabricated Aluminum Prefinished Black

Letter Faces: White Acrylic w/ 3M 3635-222 Black Perforated Vinyl Applied - 3/4" Black Trimcap

Logo Face: White Acrylic W/3M 7725-12 Black Vinyl Applied - 3/4" Black Trimcap Raceway: Std. 8" Narrow - Extruded Aluminum Painted to Match Wall Color Illumination: White LEDs with 60Watt Power Supplies in Raceway

Power: (1) 20Amp @ 120Volt Electrical Circuit Run to Site by Others Mounting: Flush to Building with Anchors Appropriate for Wall Construction



01-SOUTH ELEVATION

Scale: 1/8" = 1'-0'

This sign is built to UL Standards for operation in North America.

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Tel/630-510-2020 • Fax/630-510-2074

e-mail/signs • parvinclauss.com

PROJECT:



SEC Kirk Road & Main Street (Rt. 64) St. Charles, IL

CUSTOMER APPROVAL:

DATE

AUTHORIZED SIGNATURE

REPRESENTATIVE

House / RM / KZ

DRAWN BY

Bill Marlow

DATE 10.23.19

SHEET NO.

WORK ORDER

SCALE

82989

3/4" = 1'

8 of 12

FILE NAME PRD82989

REVISIONS:

11.04.19

2 5.18.20


3 5.19.20

4 5.26.20

⁵ 6.19.20 - New Elevation

8

9

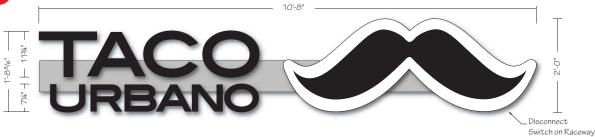

(1 set) 5" Deep Illuminated Channel Letters & Logo on Raceway

Letter & Logo Returns: .040" Fabricated Aluminum Prefinished Black


Letter Faces: White Acrylic w/ 3M 3635-222 Black Perforated Vinyl Applied - 3/4" Black Trimcap

Logo Face: White Acrylic w/ 3M 7725-12 Black Vinyl Applied - 3/4" Black Trimcap

Raceway: Std. 8" Narrow - Extruded Aluminum Painted to Match Wall Color Illumination: White LEDs with 60Watt Power Supplies in Raceway

Power: (1) 20Amp @ 120Volt Electrical Circuit Run to Site by Others

Mounting: Flush to Building with Anchors Appropriate for Wall Construction

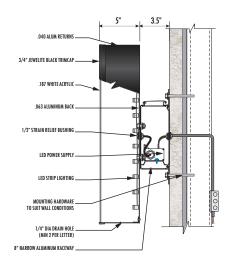



04-NORTH ELEVATION

Scale: 1/8" = 1'-0"

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Tel/630 • 510 - 2020 • Fax/630 • 510 - 2074
e - mail/signs @ parvinclauss.com
w w w , parvinclauss.com

PROJECT:



SEC Kirk Road & Main Street (Rt. 64) St. Charles, IL

CUSTOMER APPROVAL:

DATE

AUTHORIZED SIGNATURE

REPRESENTATIVE

House / RM / KZ

DRAWN BY

Bill Marlow

DATE

10.23.19

SCALE

SHEET NO.

WORK ORDER

82989

1/2" = 1'

9 of 12

FILE NAME PRD82989

REVISIONS:

11.04.19


2 5.18.20

3 5.19.20

4 5.26.20

5 6.19.20 - New Elevation

8

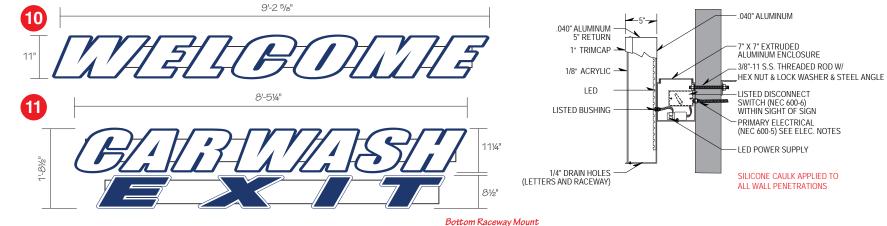

Upside Down

(1 set each) 5" Deep Illuminated Channel Letters on Raceways - 8.45 SF / 14.40 SF

Returns: Fabricated Aluminum Painted PMS 288 Blue Faces: #7328 White Acrylic w/ 1" Jewelite White trimcap Vinyl: 3M 3630-157 Sultan Blue Translucent Vinyl


Raceways: Std. 7" x 7" Aluminum Painted to Match Wall Color - SW 7063 Nebulous White

Illumination: White LED

Power: (1) 20Amp @ 120Volts Electrical Circuit Run to Site by Others

Mounting: Raceways Flush Mounted to Building - Appropriate Hardware for Wall Construction

NOTE: FIELD SURVEY REQUIRED PRIOR TO FABRICATION

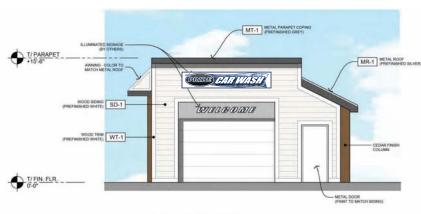

02-WEST ELEVATION

Scale: 1/8" = 1'-0"

MT.1 METAL PARAPET COPING

METAL ROOF

MET

03-EAST ELEVATION

Scale: 1/8" = 1'-0"

This sign is built to UL Standards for operation in North America.

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SIGN COMPANY

Design • Fabrication • Installation • Maintenance

165TubewayDrive • CarolStream • Illinois60188

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www.parvinclauss.com

PROJECT:



SEC Kirk Road & Main Street (Rt. 64) St. Charles, IL

CUSTOMER APPROVAL:

DAT

AUTHORIZED SIGNATURE

REPRESENTATIVE
House / RM / KZ

DRAWN BY
Bill Marlow

DATE 10.23.19

3/4" = 1'

82989

SCALE

SHEET NO. 10 of 12

WORK ORDER

FILE NAME PRD82989

REVISIONS:

1 11.04.19


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4 5.26.20

⁵ 6.19.20 - New Elevation

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(1) 1'-6" x 27'-4" x 2" Single Face Non-Illuminated Entrance Gateway

Cabinet: Fabricated Aluminum Painted Black - Suede Satin Finish

- 2" x 2" Tube Internal Structure

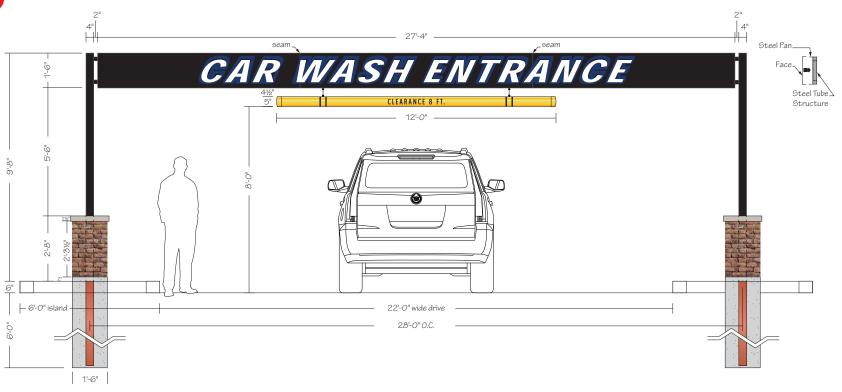Graphics: 3M 7725-37 Sapphire Blue & 7725-10 White Vinyls

Clearance Bar: 5" PVC Pipe w/ Caps Painted MAP 42248 Sundance Yellow

Clearance Ht. Copy & Stripes: 3M 680-85 Black Reflective Vinyl Bases: Masonry to Match Building - Redland Bayfrost (038) Brick

- Jumbo (OS) Modular: 35/8" W x 23/4" H x 75/8" L

Mounting: (2) 4" x 4" Tube Steel set into (2) 1'-6" dia. x 6'-0" deep Concrete Foundations

NOTE: FIELD SURVEY REQUIRED PRIOR TO FABRICATION

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Bill Marlow DATE

10.23.19

SCALE 3/8" = 1'

SHEET NO. 11 of 12

WORK ORDER

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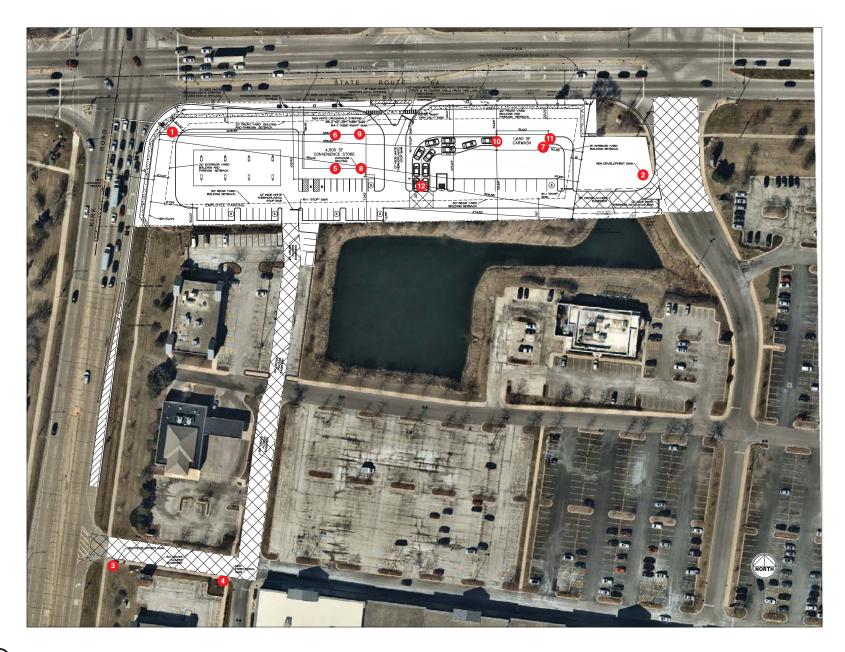
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12 of 12

nts

Bill Marlow

SCALE

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